POLYGON HOMES LTD.





PROPERTY INFORMATION

Legal Description:

Lot C: Block 5; District Lot: 265; Plan: 17693 New PID: 003-050-009

Civic Addresses:

820 W 15th St, (818-858 W 15th St) North Vancouver BC V7P 1M6

BUILDING CODE INFORMATION

APPLICABLE CODE

British Columbia Building Code 2018 - Division B - Part 3

RESIDENTIAL/ COMMERCIAL LEVELS

Major Occupancies	Group A2 (Daycare), Group C (Residential), Group E (CRU),
	, Group F (Parkade)
Bylaw Requirement	3.2.2.50
Construction Type	Noncombustible
Floor Fire Ratings	1 hour -Residential to Residential
	2 hour - Residential to Parkade
	2 hour - Residential to Comemrcial
Roof Fire Ratings	No Rating (Not Occupied)
Building Height	6 Storeys
Building Areas	>1200 sq. meters
Sprinkler System	Required (NFPA 13R)
Fire Alarm System	Required (CAN/ULC-S524)
Standpipe System	Required (NFPA 14)

STORAGE GARAGE (PARKADE)

Major Occupancies Group F Division 3 - Parking Garage Bylaw Requirement 3.2.2.77, 3.2.1.2 Construction Type Noncombustible (3.2.1.2) Floor Fire Ratings 2 hour - Basement Parking Garage to Residential Below Grade Levels 2 Level Sprinkler System Required (NFPA 13R) Fire Alarm System Required (CAN/ULC-S524) Standpipe System Required (NFPA 14)

PROJECT DESCRIPTION

Zoning Current

CS-1 Service Commercial

Project Description

The mixed-use development proposal consists of a 6-storey mixed-use (commercial/residential) building consisting of 90 market strata residential units, 9 commercial retail units (CRUs) and a childcare facility at grade. In total, 90 market strata residential units are being proposed. The breakdown of the unit types are as follows:

- 1-Bedroom 30 (33%)
- 1-Bedroom & Dens 30 (33%)
- 2-Bedroom 25 (28%)
- Greater than 2-Bedroom (2BR+Den) 5 (6%)

CRUs are oriented along the South of the site, facing West 15th Street. The commercial units are narrower (19' to 22') to accommodate smaller local businesses. Larger tenants can also be accommodated by combining several smaller CRUs into one large commercial space. The fine grain retail at grade will activate the streetscape along West 15th Street. The commercial has been designed to accommodate large patios to take advantage of the southern exposure.

PROJECT STATISTICS

STATISTICS AND CALCULATIONS

Zoning Ca	lculations -	Overall Project	t											
Site Area								FAR				Over / Under	-87.3	sq.ft.
Existing		3,021	.70 sq. m.	32,525.	3 sq. ft.			Allowable		2.50	7,554.18	sq.m	81,313.2	sq. ft.
								Proposed Re	sidential	2.17	6,555.71	sq.m	70,565.7	' sq. ft.
								Proposed Co	mmercial	0.33	990.36	sq.m	10,660.2	sq. ft.
								Total Propos	sed	2.50	7,546.07	ˈsq.m.	81,225.9) sq.ft.
Lot Coverage	е													
Allowable	45%	1,359	.75 sq.m	14,636.4	4 sq. ft.	_								
Proposed	60.6%	1,830	.08 sq.m	19,699.0	0 <i>sq. ft.</i>	_								
Setbacks		North	South	East	West			Adaptable	Unit Exclusion	(Min. 25% Ur	nits)			
Allowable		6.10	6.10	N/A	N/A	_		Required		25%	-	Units	23	Units
Proposed		9.39	7.54	3.00	4.60	_		Proposed	- 1.9 m2/Unit	28%			25	5 Units
Building Hei	ght													
Allowable	6 stories	(OCP Schedule 2	1)											
Proposed	6 Stories	and	73.0 ft	or	22.25 m	_								
Area Sumi	mary													
						_	Gross Ai	rea						
	Units					Total				Exclusions				FSR AREA
	Onits	Residential	Circulation	Commercial		10101	Lobby	Daycare	Adaptable				Total	
Level 1	0	0.0	1,504.1	10,660.2	0.0	15,500.2	937.5	2,398.4	0.0	0.0	0.0	0.0	3,335.9	12,164.3
Level 2	18	12,165.1	1,631.9	0.0	0.0	13,898.0	0.0	0.0	101.0	0.0	0.0	0.0	101.0	13,797.0
Level 3	18	12,185.8	1,636.2	0.0	0.0	13,923.0	0.0	0.0	101.0	0.0	0.0	0.0	101.0	13,822.0
Level 4	18	12,185.8	1,636.2	0.0	0.0	13,923.0	0.0	0.0	101.0	0.0	0.0	0.0	101.0	13,822.0
Level 5	18	12,185.8	1,636.2	0.0	0.0	13,923.0	0.0	0.0	101.0	0.0	0.0	0.0	101.0	13,822.0
Level 6	18	12,163.9	1,634.7	0.0	0.0	13,899.6	0.0	0.0	101.0	0.0	0.0	0.0	101.0	13,798.6
Totals	90	60,886.4	9,679.3	10,660.2	0.0	85,066.8	937.5	2,398.4	505.0	0.0	0.0	0.0	3,840.9	81,225.9

Balcony Summary

FSR Area	81,313.2 sq. ft.
Allowable	<i>10% 8,131.3</i> sq. ft.
Proposed	7.76% 6,309.4 sq. ft.

Parking Summary

VEHICLES	<u>ا</u>	/ehicle	Small	Car	Acce	ssible	EV 24	0-volt
	Required	Provided	Maximum	Provided	Required	Provided	Required	Provided
Residential	95	99	33	3	3	4	95	99
Visitor	9	10	3	0	0	2	N/A	
Commercial	20	25	7	2	0	2	N/A	
Office	0	0	0	0	0	2	N/A	
Shared	0	0	7	0	0	0	N/A	
Total Parking	124	134	50	5	3	10	95	99

<u>PH M15</u>

LOADING

Total 1

Provided

BICYCLES	Bicycle - Lo	ng Term	Horizon	tal Stalls	Vertica	l Stalls	Lock	ers
	Required	Provided	Maximum	Provided	Maximum	Provided	Required	Provided
Residential	135	136	N/A	0	N/A	0	N/A	136
Commercial	4	4	N/A	0	N/A	0	N/A	5
Daycare	1	1	N/A	0	N/A	0	N/A	5
Total Parking	140	141	0	0	0	0	0	136

Residential Unit Distribution - Overall Project

UNIT TYPE	Areas	LE	VEL 2		LEVE	EL 3		LEVEL 4 LEVEL 5 LEV		EVEL 6		UNITS	SUMMARY	Beds	Total Beds	Unit Ratio					
A	540.0	2	1080		2	1080		2	1080		2	1080		2	1080] [10	5,400.0	1	10	11.1%
A1 AD	541.5	2	1083		2	1083		2	1083		2	1083		2	1083	1 [10	5,415.0	1	10	11.1%
A2	645.9	5	3229.3		5	3229.3		5	3229.5		5	3229.3		5	3229.3	1 [25	16,146.7	1	25	27.8%
A2 AD	646.2	1	646.2		1	646.2		1	646.2		1	646.2		1	646.2	1 [5	3,231.0	1	5	5.6%
A3	586.9	1	586.9		1	586.9		1	586.9		1	586.9		1	586.9	1 [5	2,934.5	1	5	5.6%
A4	645.8	1	645.8		1	645.8	1	1	645.8		1	645.8		1	645.8	1 [5	3,229.0	1	5	5.6%
В	807.9	1	807.9		1	807.9		1	807.9		1	807.9		1	807.9	1 [5	4,039.5	2	10	5.6%
B1	796.6	1	796.6		1	796.6	1	1	796.6		1	796.6		1	796.6	1 [5	3,983.0	2	10	5.6%
B2	850.2	2	1700.4		2	1700.4	1	2	1700.4		2	1700.4		2	1700.4	1 [10	8,502.0	2	20	11.1%
B3 AD	830.8	1	830.8		1	830.8	1	1	830.8		1	830.8		1	830.8	1 [5	4,154.0	2	10	5.6%
B4 AD	866.5	1	866.5		1	866.5		1	866.5		1	866.5		1	866.5] [5	4,332.5	2	10	5.6%
		18	11406.9	0	18	11406.9	0	18	11407.1	0	18	11406.9	0	18	11406.9	0	90	61,367.2	16	120	100.0%

PROJECT TOTALS

	UNIT	L2	AREA	L3	AREA		L4	AREA		L5	AREA		L6	AREA		TOTAL
Studio	('S' Types)	0	0	0	0		0	0		0	0		0	0		
One Bed	('A' Types)	12	7,271.2	12	7,271.2		12	7,271.4]	12	7,271.2		12	7,271.2		60
Two Bed	('B' Types)	6	5,002.2	6	5,002.2		6	5,002.2]	6	5,002.2		6	5,002.2		30
Three Bed	('C' Types)	0	0.0	0	0.0		0	0.0]	0	0.0		0	0.0		
		18	12,273.4 (0 18	12,273.4	0	18	12,273.6	0	18	12,273.4	0	18	12,273.4	0	90

UNIT COUNT AND AREAS PER FLOOR

MARINE & 15th

820 W 15th, North Vancouver BC

DRAWING LIST

A0.00 A0.01a A0.03a A0.03b A0.04a A0.04b A0.05 A0.05 A0.05 A0.05 A0.06 A1.00 A2.01 A2.02 A2.03 A2.04 A2.05 A2.09 A2.20 A5.01 A5.02	COVER SHEET DESIGN RATIONALE SITE CONTEXT CONTEXT IMAGES PERSPECTIVES PERSPECTIVES SHADOW STUDIES AERIAL VIEVVS UNIT AREAS SITE PLAN LEVEL P2 PLAN LEVEL P1 PLAN LEVEL 1 PLAN LEVEL 2 PLAN LEVEL 2 PLAN LEVEL 3 PLAN - TYPICAL ROOF PLAN PARKING SECTIONS ELEVATIONS
A6.00	SITE SECTIONS BUILDING SECTIONS
A6.01 A6.02 A6.03	BUILDING SECTIONS
Grand total: 3	

Ρ	R	0	J	E	C	Г	T	E	A	N

OWNER/DEVELOPER

SHIFT ARCHITECTURE INC.

CERTIFIED PROFESSIONAL LMDG CODE CONSULTANTS LTD.

(604) 877.1131

ARCHITECT

(604) 988.7501

(604) 682.7146

(604) 739.7707

(604) 873.1768

(778) 752.5834

(604) 736.6562

NEMETZ

CIVIL ENGINEER

INTERCAD SERVICES LTD.

STRUCTURAL ENGINEER

MECHANICAL ENGINEER STRAITON ENGINEERING LTD.

ELECTRICAL ENGINEER

LANDSCAPE ARCHITECT

(604) 681.3303 ext 224

POLYGON DEVELOPMENT 237 LTD.

Suite 900- 1333 W Broadway, Vancouver BC V6H 4C2

Suite 200 - 1000 W 3 Street, North Vancouver BC V7P 3J6

4th Floor, 780 Beatty Street, Vancouver BC V6B 2M1

1111 West 8th Avenue, Vancouver BC V6H 1C5

121 West 6th Avenue, Vancouver BC V5Y 1K3

THOMAS LEUNG STRUCTURAL ENGINEERING INC.

203- 33386 South Fraser Way, Abbotsford BC V2S 2B5

2009 West 4th Avenue, Vancouver BC V6J 1N3

CONNECT LANDSCAPE ARCHITECTURE 2305 Hemlock Street, Vancouver BC V6H 2V1

BUILDING ENVELOPE CONSULTANT

	Over / Under	-87.3	sq. ft.
54.18	sq.m	81,313.2	sq. ft.
55.71	sq.m	70,565.7	sq. ft.
90.36	sq.m	10,660.2	sq. ft.
46.07	sq.m.	81,225.9	sq.ft.
90	Units	23	Units
		25	Units
	-		

215- 1200 West 73rd Avenue, Vancouver BC V6P 6G5 (604) 439.0922 SURVEYOR

GEOTECHNICAL ENGINEER

GEOPACIFIC CONSULTANTS LTD.

BUTLER SUNDVICK 4- 19089 94th Avenue, Surrey BC V4N 3S4 (604) 513.9611

ACOUSTIC CONSULTANT

DIAMOND HEAD CONSULTING

TRAFFIC CONSULTANT

3559 Commercial Street, Vancouver BC V5B 4E8

202- 8525 Baxter Place, Burnaby BC V5A 4V7

GREAT NORTHERN ENGINEERING CONSULTANTS (GNEC)

ARBORIST

(604) 733.4886

(778) 827.1062

Bicycle - Short Term Required Provided 9 9 6 6

2 2

17 17

SUMMARY	Beds	Total Beds	Unit Ratio
5,400.0	1	10	11.1%
5,415.0	1	10	11.1%
16,146.7	1	25	27.8%
3,231.0	1	5	5.6%
2,934.5	1	5	5.6%
3,229.0	1	5	5.6%
4,039.5	2	10	5.6%
3,983.0	2	10	5.6%
8,502.0	2	20	11.1%
4,154.0	2	10	5.6%
4,332.5	2	10	5.6%

AREA	
36,356.2	
25,011.0	
61,367.2	





200,1000 West 3rd Street North Vancouver, BC V7P 3J6 T 604.988.7501 | shiftarchitecture.ca

This drawing is an instrument of service and the property of Shift Architecture Inc. and shall remain their property. The use of this drawing shall be restricted to the original site for which it was prepared and publication thereof is expressly limited to such use. Reuse, reproduction or publication by any method in whole or in part is prohibited without their written consent.

No.	Date	Revision Notes
A	26/01/22	ISSUED FOR RZ/DP
No.	Date	Revision Notes









DESIGN RATIONALE

Relationship to context

The mixed-use residential/ commercial proposal will replace the former low-density service commercial within the Marine Drive Frequent Transit Development Area. The proposed development provides lot-line to lot-line commercial units, a community amenity in the form of a daycare, and new opportunities for home ownership along the Marine Drive corridor with access to public transit. Redevelopment of this site will play a vital role in enhancing the pedestrian-friendly, and streetscape within a transit-supportive environment.

<u> Building Massing / Materials</u>

Building on previous successful collaborations between Polygon Homes and Shift Architecture, the proposed development seeks to enrich the community by supporting and enhancing the existing urban fabric. The architecture of the development intentionally seeks to create forms which embody a strong base, middle and top. Given the overall scale of the project, the architectural massing of the project also seeks to reduce the scale of the project into smaller, more easily understood components that serve to enliven the existing urban composition. This approach is consistent on all facades of the development.

Cladding is chosen to enhance the massing: the commercial base of the development is rendered in a rich ironspot brick. A filagree of decorative painted structural columns serve to define individual storefronts, while supporting complementary opportunities for signage above the continuous glazing of the commercial frontage.

The lighter, painted cementitious cladding of the residential levels counters the deeper brick base of the commercial level. The middle or "body" of the architecture is defined by frames and shrouds which gather balconies while subdividing and articulating the massing. The exterior faces of these frames and shrouds are clad in a prefinished metal while their interior faces feature wood-like cladding. The soffits of the balconies are gathered by frames also clad in wood-like material as are the soffits of the shroud elements, creating a cohesive element to the project.

A decorative perforated metal screen on the South elevation reinforces the datum line created at the upper level and further defines the head of the building. Glass and aluminum guards are utilized for most balconies while perforated metal screen is utilized within the guards at level five, to the West of the residential entry. The resulting architecture of the project is well-defined, current, and significant.

Amenities

A diverse array of public amenities surround the site and are accessible to future residents and business owners of the development. Mosquito Creek Park, Haywood Park, and Spirit trail leading to Lonsdale Quay to the East and Ambleside to West are at walking and cycling distance. Shopping, restaurants, cafes, outdoor events, galleries, farmers markets, walk-in clinics encircle the site and create a healthy, vibrant and sustainable neighborhood. The commercial amenities of the development will provide commercial services, local employment and a community hub.


Crime prevention through environmental design

The mixed-use function of the building inherently facilitates crime prevention, adding eyes on the street at different times of the day. Light fixtures through out the landscaping, particularly at the lane, create a safer environment at night.

The combination of daycare and landscaped area to the North activates the laneway while still maintaining privacy and security. The open concept of the commercial platform in the front and the secured underground parkade meet CPTED requirements by maximizing openness and visibility through the floor area.

Open space and Landscape treatment

The open area in front of the CRUs is set back from 15th street west. The border of the CRU platform gradually steps up with a few low rising stairs and is accentuated with different paving materials, planters and linear stepped seating and benches. This differentiation is soft and gradual and designed to create an inviting and vibrant podium for pedestrian, shoppers and local community to rest, sit, eat, relax, shop and enjoy the local businesses.

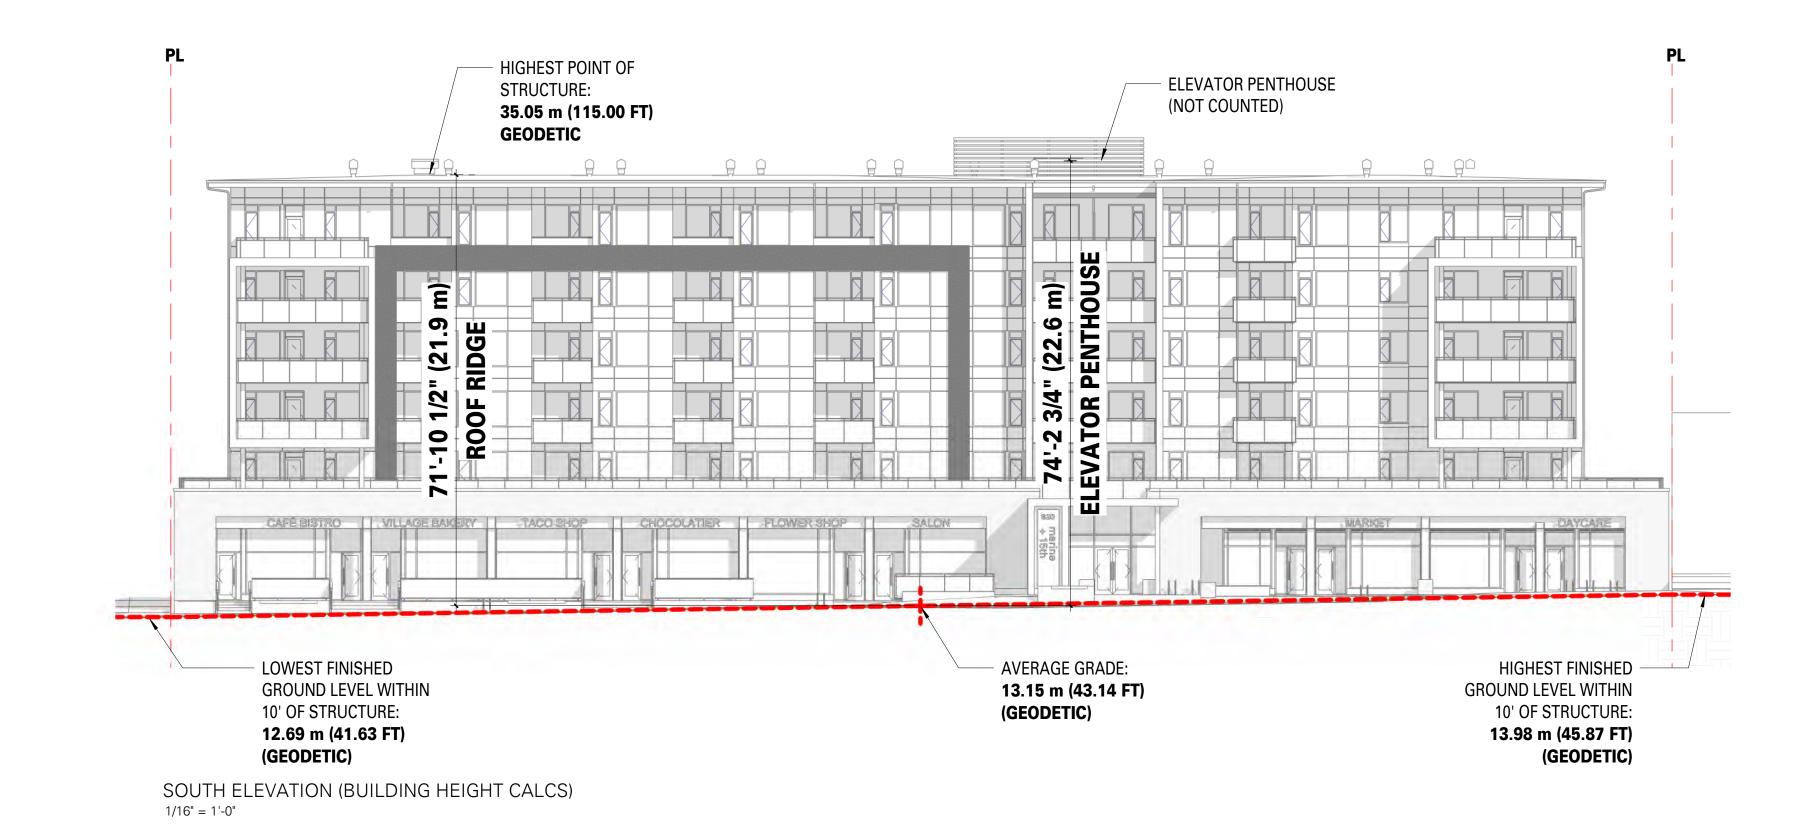



This drawing is an instrument of service and the property of Shift Architecture Inc. and shall remain their property. The use of this drawing shall be restricted to the original site for which it was prepared and publication thereof is expressly

T 604.988.7501 | shiftarchitecture.ca

use of this drawing shall be restricted to the original site for which it was prepared and publication thereof is expressly limited to such use. Reuse, reproduction or publication by any method in whole or in part is prohibited without their written consent.

No.	Date	Revision Notes
A	26/01/22	ISSUED FOR RZ/DP
No.	Date	Revision Notes



 820 W 15th St, North Vancouver BC V7P 1M6

 Image: Polygon poly

2021/01/22 Scale 1/16" = 1'-0"

Sheet Number

Plot Date

Issue Date 26/01/22 Issue/Revision

ue/Revision







This drawing is an instrument of service and the property of Shift Architecture Inc. and shall remain their property. The use of this drawing shall be restricted to the original site for which it was prepared and publication thereof is expressly limited to such use. Reuse, reproduction or publication by any method in whole or in part is prohibited without their written consent.

No.	Date	Revision Notes
A	26/01/22	ISSUED FOR RZ/DP
No.	Date	Revision Notes





 820 W 15th St, North Vancouver BC V7P 1M6

 Image: Client/Owner

 Polygon Development 237 Ltd.

 Sheet Title

 Street Title

 Drawn By
 Author

 Reviewed by
 Author

 Project Number

 2003

Plot Date 2021/01/22 Scale

Sheet Number

Issue Date 26/01/22

Issue/Revision

A0.03a



1. 15TH STREET W, LOOKING NORTH - PROJECT SIDE OF STREET



2. 15TH STREET W, LOOKING SOUTH



3. LOOKING EAST AT SITE





5. AT LANE LOOKING SOUTH - PROJECT SIDE OF LANE



This drawing is an instrument of service and the property of Shift Architecture Inc. and shall remain their property. The use of this drawing shall be restricted to the original site for which it was prepared and publication thereof is expressly limited to such use. Reuse, reproduction or publication by any method in whole or in part is prohibited without their written consent.

No.	Date	Revision Notes
		1
А	26/01/22	ISSUED FOR RZ/DP
No.	Date	Revision Notes



820 W 15th St, North Vancouver BC V7P 1M6



Client/Owner Polygon Development 237 Ltd.

Sheet Title **CONTEXT IMAGES**

Drawn By Reviewed by

Project Number **2003**

Plot Date 2021/01/22 Scale

Sheet Number

Approve

Issue Date 26/01/22

Issue/Revisio





VIEW FROM SOUTH- 15TH STREET



VIEW FROM SW CORNER- 15TH STREET



PERSPECTIVE VIEW FROM SE- 15TH STREET



This drawing is an instrument of service and the property of Shift Architecture Inc. and shall remain their property. The use of this drawing shall be restricted to the original site for

which it was prepared and publication thereof is expressly limited to such use. Reuse, reproduction or publication by any method in whole or in part is prohibited without their written consent.

No.	Date	Revision Notes
А	26/01/22	ISSUED FOR RZ/DP
No.	Date	Revision Notes



820 W 15th St, North Vancouver BC V7P 1M6 仮感 POLYGON Client/Owner Polygon Development 237 Ltd. Sheet Title PERSPECTIVES Drawn By Reviewed by Approve Project Number **2003** Plot Date 2021/01/22 Issue Date 26/01/22

Sheet Number

Scale

Issue/Revision

A0.04a



PERSPECTIVE VIEW FROM SOUTH- 15TH STREET



PERSPECTIVE VIEW- CRUs



This drawing is an instrument of service and the property of Shift Architecture Inc. and shall remain their property. The use of this drawing shall be restricted to the original site for which it was prepared and publication thereof is expressly limited to such use. Reuse, reproduction or publication by any method in whole or in part is prohibited without their written consent.

No.	Date	Revision Notes
А	26/01/22	ISSUED FOR RZ/DP
No.	Date	Revision Notes



820 W 15th St, North Vancouver BC V7P 1M6 POLYGON Client/Owner Polygon Development 237 Ltd. Sheet Title PERSPECTIVES

Drawn By Reviewed by

Project Number **2003**

Plot Date 2021/01/22 Scale


Sheet Number

Autho Approver


Issue Date 26/01/22

Issue/Revision Α


A0.04b

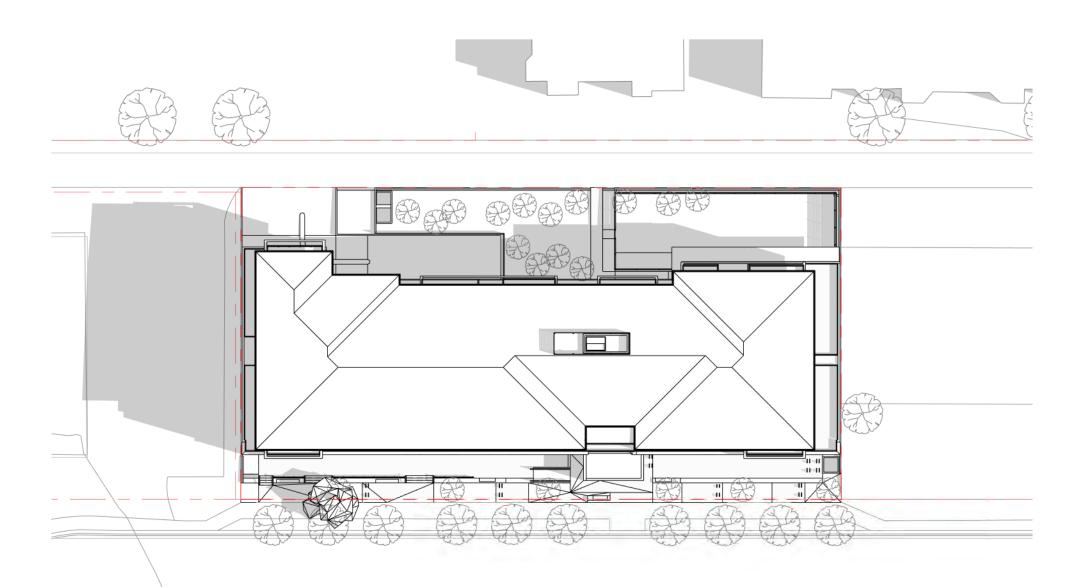


SHADOW STUDY - JUNE 21st (10am)

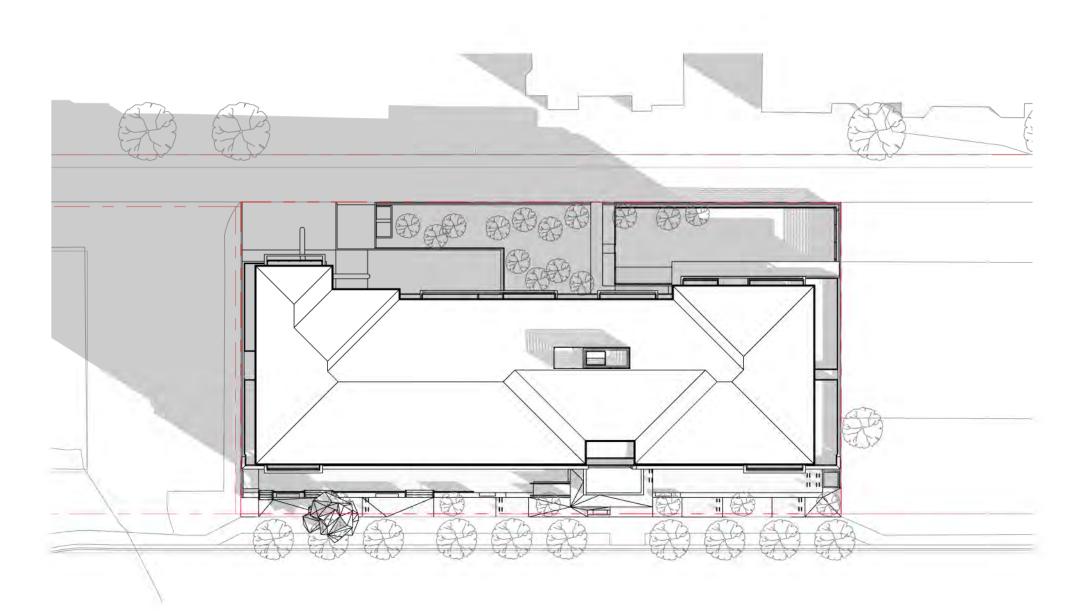


SHADOW STUDY - SEPT / MARCH 21st (10am)

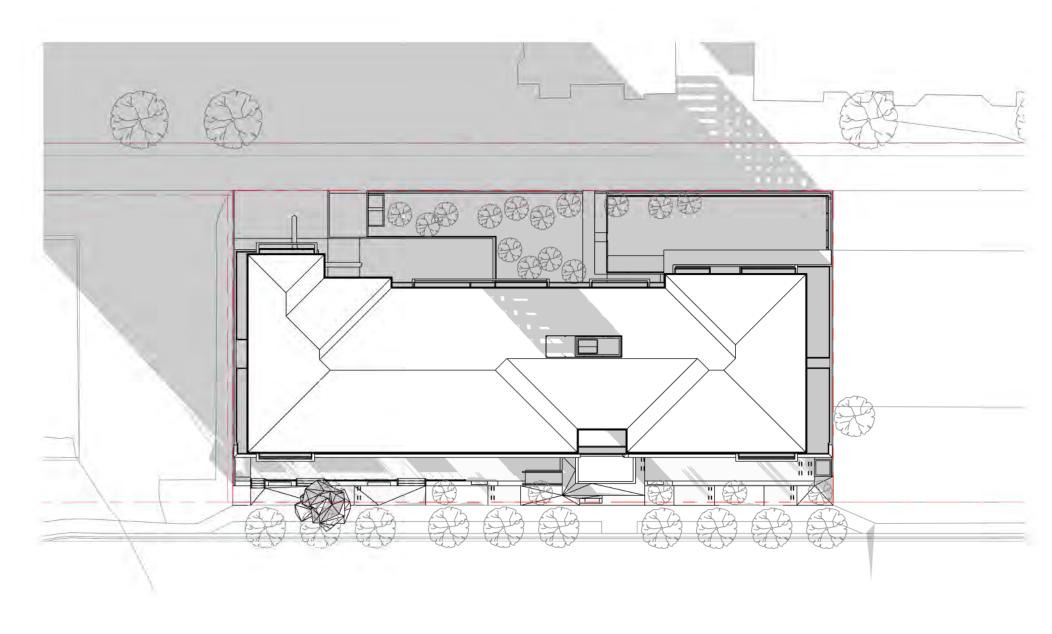


SHADOW STUDY - DECEMBER 21st (10am)

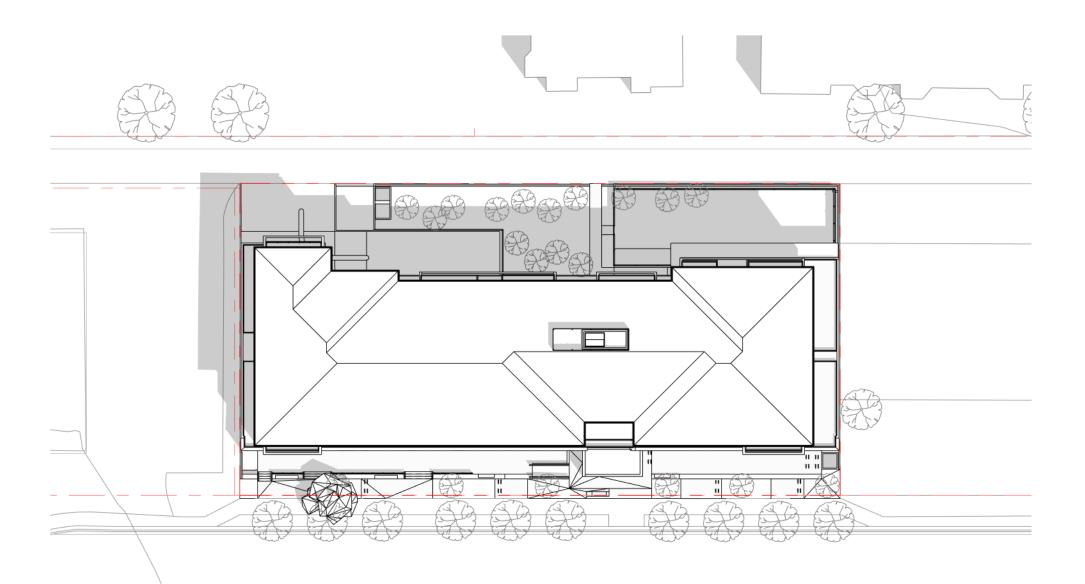


SHADOW STUDY - JUNE 21st (12pm)

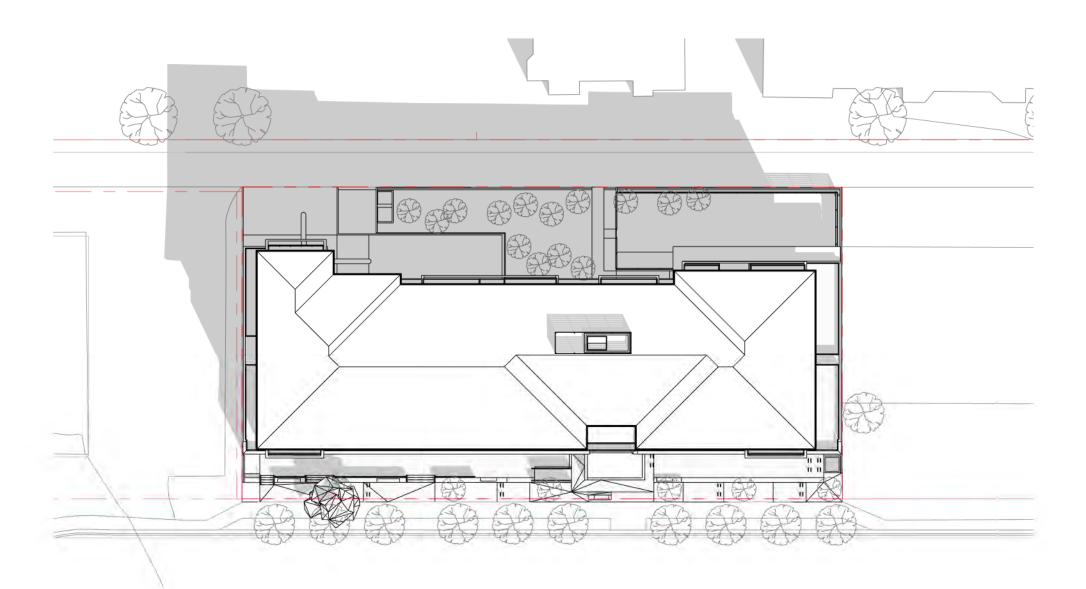


SHADOW STUDY - SEPT / MARCH 21st (12pm)

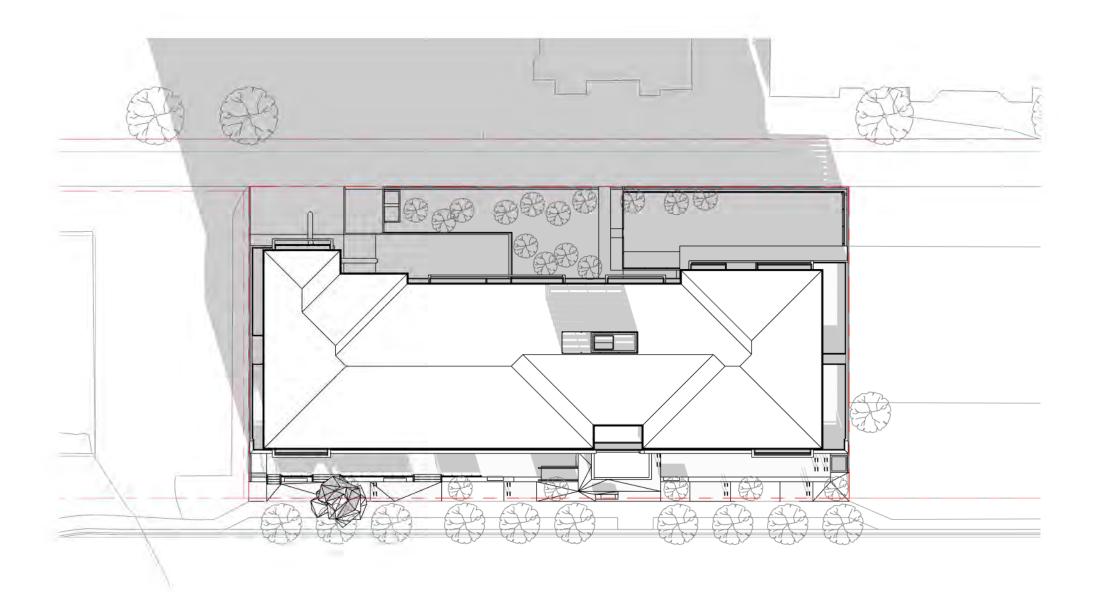


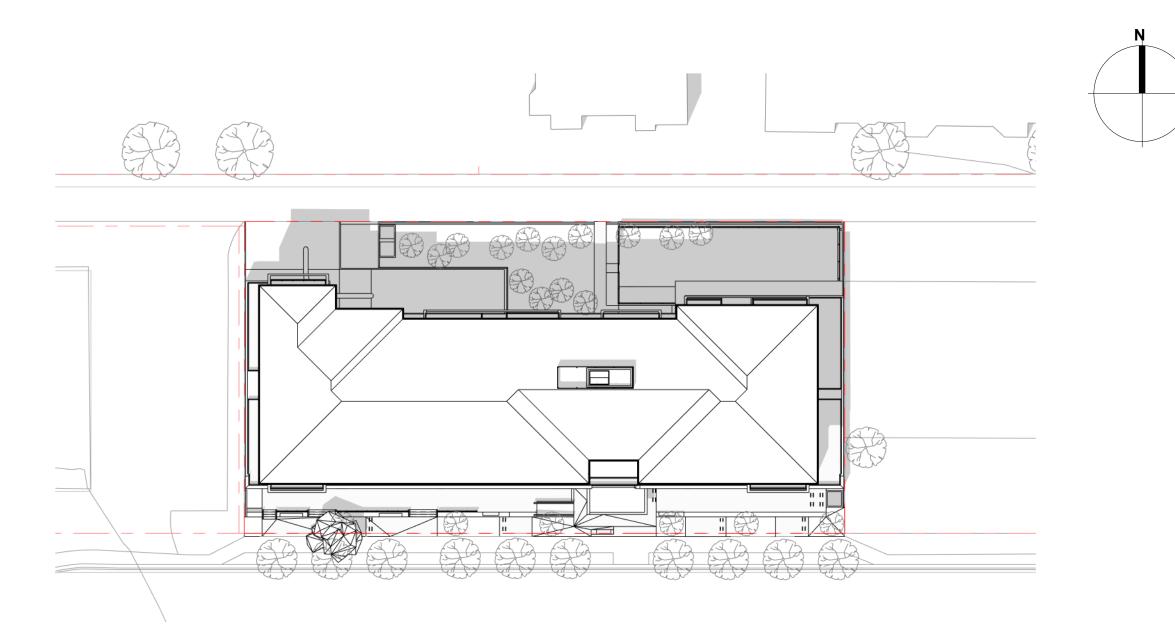

SHADOW STUDY - JUNE 21st (2pm)

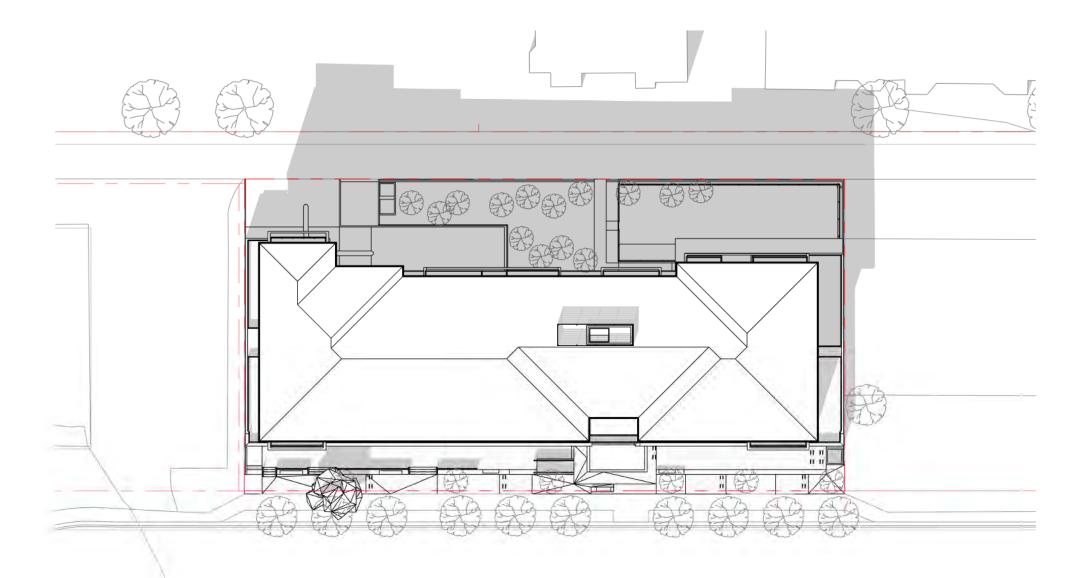

SHADOW STUDY - SEPT / MARCH 21st (2pm)

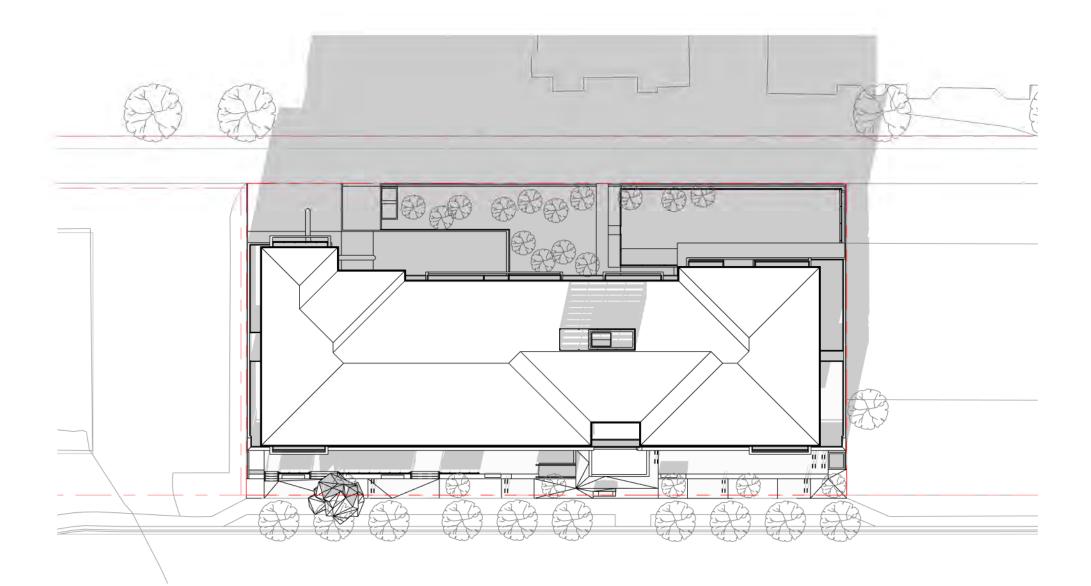



200,1000 West 3rd Street North Vancouver, BC V7P 3J6 **T** 604.988.7501 | shiftarchitecture.ca

This drawing is an instrument of service and the property of Shift Architecture Inc. and shall remain their property. The use of this drawing shall be restricted to the original site for which it was prepared and publication thereof is expressly limited to such use. Reuse, reproduction or publication by any method in whole or in part is prohibited without their written consent.

No.	Date	Revision Notes
A	26/01/22	ISSUED FOR RZ/DP
No.	Date	Revision Notes





2003

Scale

Plot Date

2021/01/22

1" = 40'-0"

Sheet Number

820 W 15th St, North Vancouver BC V7P 1M6 **POLYGON** Client/Owner Polygon Development 237 Ltd. Sheet Title SHADOW STUDIES Drawn By LC Reviewed by Approver Project Number

> lssue Date 26/01/22

Issue/Revision









2 AERIAL FROM NW





4 AERIAL FROM SW



This drawing is an instrument of service and the property of Shift Architecture Inc. and shall remain their property. The use of this drawing shall be restricted to the original site for which it was prepared and publication thereof is expressly limited to such use. Reuse, reproduction or publication by any method in whole or in part is prohibited without their written consent.


No.	Date	Revision Notes
A	26/01/22	ISSUED FOR RZ/DP
No.	Date	Revision Notes






Sheet Number




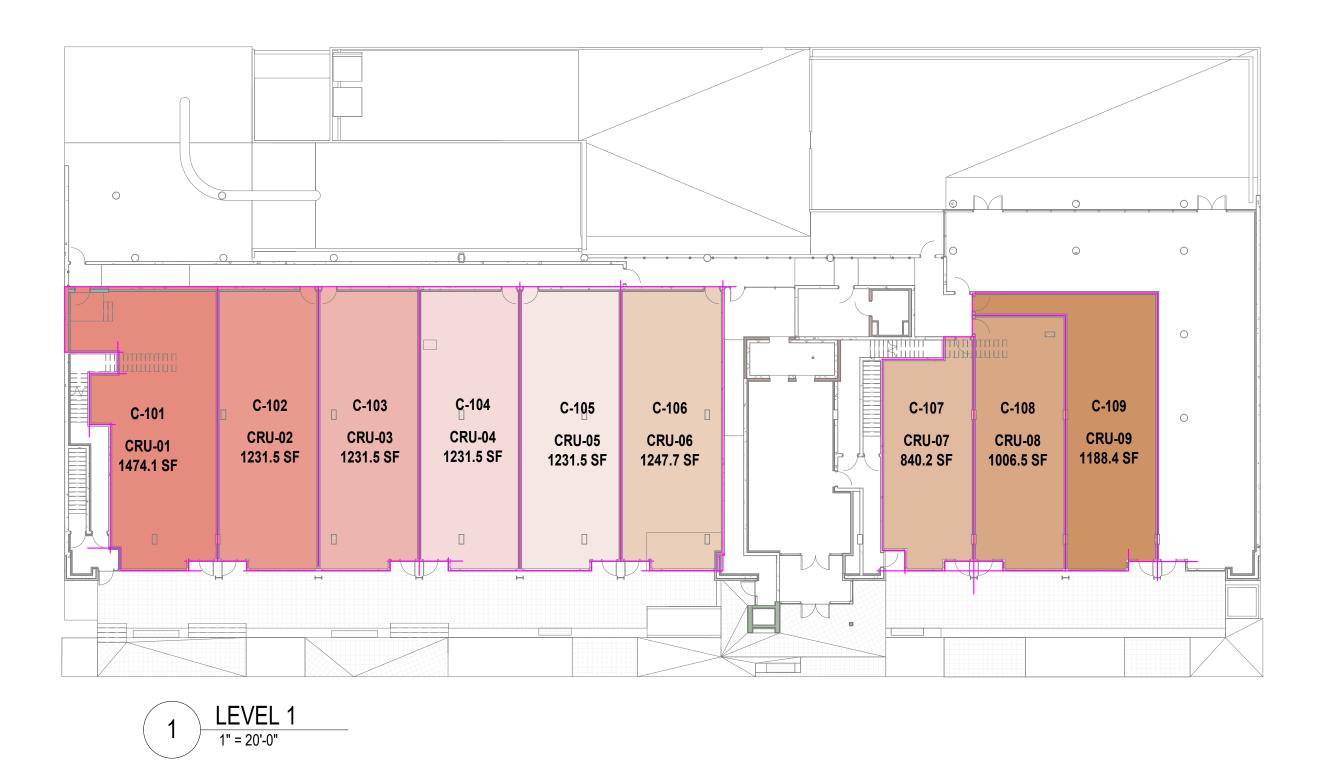



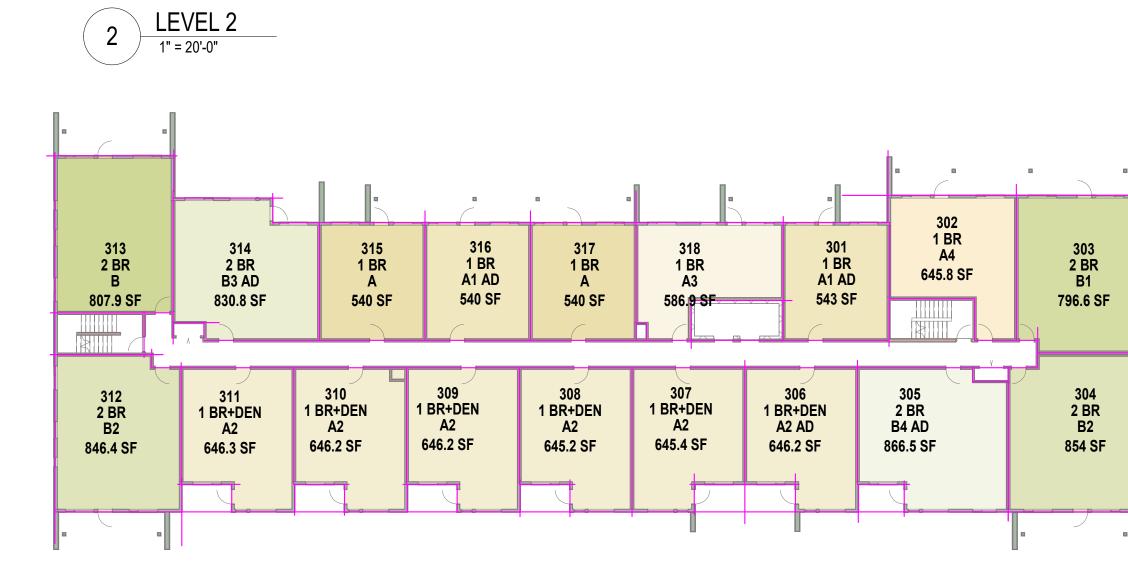



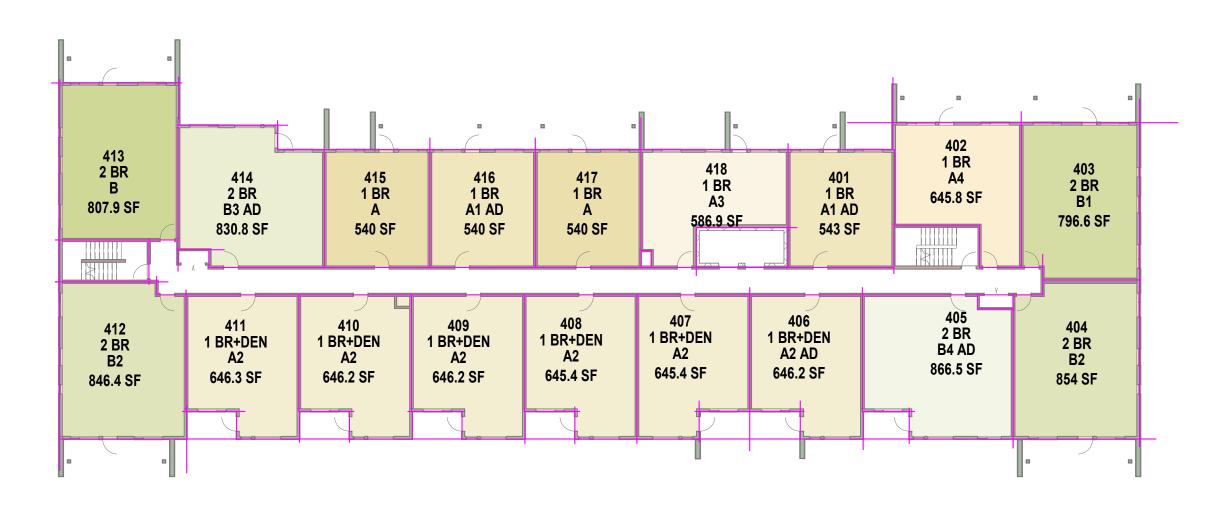



•


203


2 BR


204 2 BR B2

854 SF

B1

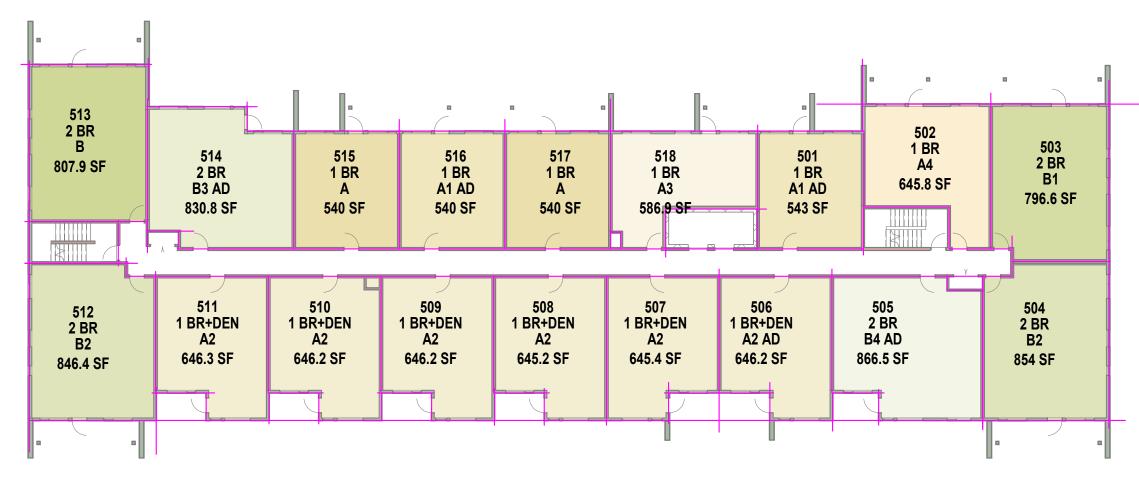

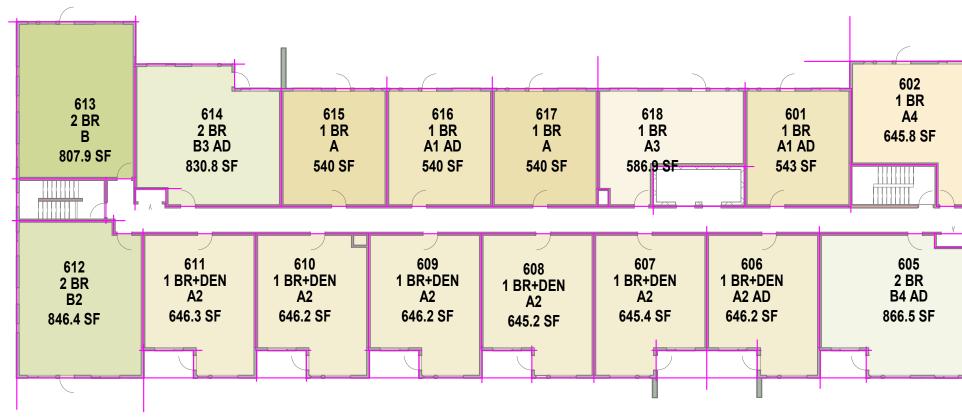

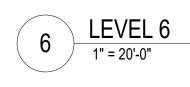

| – | | chedule (Commo |

 | | | | | | | | | | | | | |
 | | | | | | | | | | | | | |
 | | | | | | | |
 | | | | | | | |
 | | | | | | | | |
 | | | | | | | | | | |
 | | | | | | | | | | |
 | | | | | | | | | |
|---|--|---
--
--
--
--
--
--|---|---|---|--|--|---
---|--|---|---|---|---|--|--|--|---|---|--|---
---	--	---	--	---	--	---	---	--
--	---	---	--	---	---			
---	--	--	--	---	--	---		
---	--	---	---	---	--	--	--	---
---	--	---	--	--	--	--	---	--
--	---	--	---	--	--	---	---	--
Туре	Name	Area	Floor					

 | s TOTA | | | | | | | | | | | | |
 | | | | | | | | | | | | | |
 | | | | | | | |
 | | | | | | | |
 | | | | | | | | |
 | | | | | | | | | | |
 | | | | | | | | | | |
 | | | | | | | | | |
| LEVEL 1 | | 44744.05 |

 | 1.171.1.0 | | | | | | | | | | | | |
 | | | | | | | | | | | | | |
 | | | | | | | |
 | | | | | | | |
 | | | | | | | | |
 | | | | | | | | | | |
 | | | | | | | | | | |
 | | | | | | | | | |
| CRU-01
CRU-02 | CRU-01
CRU-02 | 1474.1 SF
1231.5 SF | 1

 | 1474.1 S
1231.5 S | | | | | | | | | | | | |
 | | | | | | | | | | | | | |
 | | | | | | | |
 | | | | | | | |
 | | | | | | | | |
 | | | | | | | | | | |
 | | | | | | | | | | |
 | | | | | | | | | |
| CRU-03 | CRU-03 | 1231.5 SF | 1

 | 1231.5 S | | | | | | | | | | | | |
 | | | | | | | | | | | | | |
 | | | | | | | |
 | | | | | | | |
 | | | | | | | | |
 | | | | | | | | | | |
 | | | | | | | | | | |
 | | | | | | | | | |
| CRU-04 | CRU-04 | 1231.5 SF | 1

 | 1231.5 S | | | | | | | | | | | | |
 | | | | | | | | | | | | | |
 | | | | | | | |
 | | | | | | | |
 | | | | | | | | |
 | | | | | | | | | | |
 | | | | | | | | | | |
 | | | | | | | | | |
| CRU-05
CRU-06 | CRU-05
CRU-06 | 1231.5 SF
1247.7 SF | 1

 | 1231.5 S
1247.7 S | | | | | | | | | | | | |
 | | | | | | | | | | | | | |
 | | | | | | | |
 | | | | | | | |
 | | | | | | | | |
 | | | | | | | | | | |
 | | | | | | | | | | |
 | | | | | | | | | |
| CRU-06 | CRU-06 | 840.2 SF | 1

 | 840.2 SF | | | | | | | | | | | | |
 | | | | | | | | | | | | | |
 | | | | | | | |
 | | | | | | | |
 | | | | | | | | |
 | | | | | | | | | | |
 | | | | | | | | | | |
 | | | | | | | | | |
| CRU-08 | CRU-08 | 1006.5 SF | 1

 | 1006.5 S | | | | | | | | | | | | |
 | | | | | | | | | | | | | |
 | | | | | | | |
 | | | | | | | |
 | | | | | | | | |
 | | | | | | | | | | |
 | | | | | | | | | | |
 | | | | | | | | | |
| CRU-09 | CRU-09 | 1188.4 SF | 1

 | 1188.4 S | | | | | | | | | | | | |
 | | | | | | | | | | | | | |
 | | | | | | | |
 | | | | | | | |
 | | | | | | | | |
 | | | | | | | | | | |
 | | | | | | | | | | |
 | | | | | | | | | |
| TOTAL: | | 10682.9 SF
10682.9 SF | 9
9

 | 10682.9
10682.9 | | | | | | | | | | | | |
 | | | | | | | | | | | | | |
 | | | | | | | |
 | | | | | | | |
 | | | | | | | | |
 | | | | | | | | | | |
 | | | | | | | | | | |
 | | | | | | | | | |
| | | |

 | | | | | | | | | | | | | |
 | | | | | | | | | | | | | |
 | | | | | | | |
 | | | | | | | |
 | | | | | | | | |
 | | | | | | | | | | |
 | | | | | | | | | | |
 | | | | | | | | | |
| Туре | Are
Name | a Schedule (Uni | ts)
Floor

 | s TOTA | | | | | | | | | | | | |
 | | | | | | | | | | | | | |
 | | | | | | | |
 | | | | | | | |
 | | | | | | | | |
 | | | | | | | | | | |
 | | | | | | | | | | |
 | | | | | | | | | |
| LEVEL 2 | Hamo | 71100 | 11001

 | | | | | | | | | | | | | |
 | | | | | | | | | | | | | |
 | | | | | | | |
 | | | | | | | |
 | | | | | | | | |
 | | | | | | | | | | |
 | | | | | | | | | | |
 | | | | | | | | | |
| A
A | 1 BR | 540 SF
540 SF | 1

 | 540 SF | | | | | | | | | | | | |
 | | | | | | | | | | | | | |
 | | | | | | | |
 | | | | | | | |
 | | | | | | | | |
 | | | | | | | | | | |
 | | | | | | | | | | |
 | | | | | | | | | |
| A
A1 AD | 1 BR
1 BR | 540 SF | 1

 | 540 SF
540 SF | | | | | | | | | | | | |
 | | | | | | | | | | | | | |
 | | | | | | | |
 | | | | | | | |
 | | | | | | | | |
 | | | | | | | | | | |
 | | | | | | | | | | |
 | | | | | | | | | |
| A1 AD | 1 BR | 543 SF | 1

 | 543 SF | | | | | | | | | | | | |
 | | | | | | | | | | | | | |
 | | | | | | | |
 | | | | | | | |
 | | | | | | | | |
 | | | | | | | | | | |
 | | | | | | | | | | |
 | | | | | | | | | |
| A2 | 1 BR+DEN | 646.2 SF | 1

 | 646.2 SF | | | | | | | | | | | | |
 | | | | | | | | | | | | | |
 | | | | | | | |
 | | | | | | | |
 | | | | | | | | |
 | | | | | | | | | | |
 | | | | | | | | | | |
 | | | | | | | | | |
| A2 | 1 BR+DEN | 646.2 SF | 1

 | 646.2 SF | | | | | | | | | | | | |
 | | | | | | | | | | | | | |
 | | | | | | | |
 | | | | | | | |
 | | | | | | | | |
 | | | | | | | | | | |
 | | | | | | | | | | |
 | | | | | | | | | |
| A2
A2 | 1 BR+DEN
1 BR+DEN | 645.2 SF
645.4 SF | 1

 | 645.2 SF
645.4 SF | | | | | | | | | | | | |
 | | | | | | | | | | | | | |
 | | | | | | | |
 | | | | | | | |
 | | | | | | | | |
 | | | | | | | | | | |
 | | | | | | | | | | |
 | | | | | | | | | |
| A2
A2 | 1 BR+DEN | 646.3 SF | 1

 | 646.3 SF | | | | | | | | | | | | |
 | | | | | | | | | | | | | |
 | | | | | | | |
 | | | | | | | |
 | | | | | | | | |
 | | | | | | | | | | |
 | | | | | | | | | | |
 | | | | | | | | | |
| A2 AD | 1 BR+DEN | 646.2 SF | 1

 | 646.2 SF | | | | | | | | | | | | |
 | | | | | | | | | | | | | |
 | | | | | | | |
 | | | | | | | |
 | | | | | | | | |
 | | | | | | | | | | |
 | | | | | | | | | | |
 | | | | | | | | | |
| A3 | 1 BR | 586.9 SF | 1

 | 586.9 SF | | | | | | | | | | | | |
 | | | | | | | | | | | | | |
 | | | | | | | |
 | | | | | | | |
 | | | | | | | | |
 | | | | | | | | | | |
 | | | | | | | | | | |
 | | | | | | | | | |
| A4 | 1 BR
2 BR | 645.8 SF | 1

 | 645.8 SF | | | | | | | | | | | | |
 | | | | | | | | | | | | | |
 | | | | | | | |
 | | | | | | | |
 | | | | | | | | |
 | | | | | | | | | | |
 | | | | | | | | | | |
 | | | | | | | | | |
| B
B1 | 2 BR
2 BR | 807.9 SF
796.6 SF | 1

 | 807.9 SF
796.6 SF | | | | | | | | | | | | |
 | | | | | | | | | | | | | |
 | | | | | | | |
 | | | | | | | |
 | | | | | | | | |
 | | | | | | | | | | |
 | | | | | | | | | | |
 | | | | | | | | | |
| B1
B2 | 2 BR | 846.4 SF | 1

 | 846.4 SF | | | | | | | | | | | | |
 | | | | | | | | | | | | | |
 | | | | | | | |
 | | | | | | | |
 | | | | | | | | |
 | | | | | | | | | | |
 | | | | | | | | | | |
 | | | | | | | | | |
| B2 | 2 BR | 854 SF | 1

 | 854 SF | | | | | | | | | | | | |
 | | | | | | | | | | | | | |
 | | | | | | | |
 | | | | | | | |
 | | | | | | | | |
 | | | | | | | | | | |
 | | | | | | | | | | |
 | | | | | | | | | |
| B3 AD | 2 BR | 830.8 SF | 1

 | 830.8 SF | | | | | | | | | | | | |
 | | | | | | | | | | | | | |
 | | | | | | | |
 | | | | | | | |
 | | | | | | | | |
 | | | | | | | | | | |
 | | | | | | | | | | |
 | | | | | | | | | |
| B4 AD | 2 BR | 866.5 SF
12273.4 SF | 1
18

 | 866.5 SF
12273.4 | | | | | | | | | | | | |
 | | | | | | | | | | | | | |
 | | | | | | | |
 | | | | | | | |
 | | | | | | | | |
 | | | | | | | | | | |
 | | | | | | | | | | |
 | | | | | | | | | |
| LEVEL 3 | | |

 | | | | | | | | | | | | | |
 | | | | | | | | | | | | | |
 | | | | | | | |
 | | | | | | | |
 | | | | | | | | |
 | | | | | | | | | | |
 | | | | | | | | | | |
 | | | | | | | | | |
| А | 1 BR | 540 SF
540 SF | 1

 | 540 SF
540 SF | | | | | | | | | | | | |
 | | | | | | | | | | | | | |
 | | | | | | | |
 | | | | | | | |
 | | | | | | | | |
 | | | | | | | | | | |
 | | | | | | | | | | |
 | | | | | | | | | |
| A
A1 AD | 1 BR
1 BR | 540 SF
540 SF | 1

 | 540 SF
540 SF | | | | | | | | | | | | |
 | | | | | | | | | | | | | |
 | | | | | | | |
 | | | | | | | |
 | | | | | | | | |
 | | | | | | | | | | |
 | | | | | | | | | | |
 | | | | | | | | | |
| A1 AD | 1 BR | 543 SF | 1

 | 543 SF | | | | | | | | | | | | |
 | | | | | | | | | | | | | |
 | | | | | | | |
 | | | | | | | |
 | | | | | | | | |
 | | | | | | | | | | |
 | | | | | | | | | | |
 | | | | | | | | | |
| A2 | 1 BR+DEN | 646.2 SF | 1

 | 646.2 SF | | | | | | | | | | | | |
 | | | | | | | | | | | | | |
 | | | | | | | |
 | | | | | | | |
 | | | | | | | | |
 | | | | | | | | | | |
 | | | | | | | | | | |
 | | | | | | | | | |
| A2 | 1 BR+DEN | 646.2 SF | 1

 | 646.2 SF | | | | | | | | | | | | |
 | | | | | | | | | | | | | |
 | | | | | | | |
 | | | | | | | |
 | | | | | | | | |
 | | | | | | | | | | |
 | | | | | | | | | | |
 | | | | | | | | | |
| A2
A2 | 1 BR+DEN
1 BR+DEN | 645.2 SF
646.3 SF | 1

 | 645.2 SF
646.3 SF | | | | | | | | | | | | |
 | | | | | | | | | | | | | |
 | | | | | | | |
 | | | | | | | |
 | | | | | | | | |
 | | | | | | | | | | |
 | | | | | | | | | | |
 | | | | | | | | | |
| A2
A2 | 1 BR+DEN | 646.3 SF
645.4 SF | 1

 | 646.3 SF
645.4 SF | | | | | | | | | | | | |
 | | | | | | | | | | | | | |
 | | | | | | | |
 | | | | | | | |
 | | | | | | | | |
 | | | | | | | | | | |
 | | | | | | | | | | |
 | | | | | | | | | |
| A2 AD | 1 BR+DEN | 646.2 SF | 1

 | 646.2 SF | | | | | | | | | | | | |
 | | | | | | | | | | | | | |
 | | | | | | | |
 | | | | | | | |
 | | | | | | | | |
 | | | | | | | | | | |
 | | | | | | | | | | |
 | | | | | | | | | |
| A3 | 1 BR | 586.9 SF | 1

 | 586.9 SF | | | | | | | | | | | | |
 | | | | | | | | | | | | | |
 | | | | | | | |
 | | | | | | | |
 | | | | | | | | |
 | | | | | | | | | | |
 | | | | | | | | | | |
 | | | | | | | | | |
| A4 | 1 BR | 645.8 SF | 1

 | 645.8 SF | | | | | | | | | | | | |
 | | | | | | | | | | | | | |
 | | | | | | | |
 | | | | | | | |
 | | | | | | | | |
 | | | | | | | | | | |
 | | | | | | | | | | |
 | | | | | | | | | |
| B
B1 | 2 BR | 807.9 SF | 1

 | 807.9 SF | | | | | | | | | | | | |
 | | | | | | | | | | | | | |
 | | | | | | | |
 | | | | | | | |
 | | | | | | | | |
 | | | | | | | | | | |
 | | | | | | | | | | |
 | | | | | | | | | |
| B1
B2 | 2 BR
2 BR | 796.6 SF
846.4 SF | 1

 | 796.6 SF
846.4 SF | | | | | | | | | | | | |
 | | | | | | | | | | | | | |
 | | | | | | | |
 | | | | | | | |
 | | | | | | | | |
 | | | | | | | | | | |
 | | | | | | | | | | |
 | | | | | | | | | |
| B2
B2 | 2 BR | 854 SF | 1

 | 840.4 Si
854 SF | | | | | | | | | | | | |
 | | | | | | | | | | | | | |
 | | | | | | | |
 | | | | | | | |
 | | | | | | | | |
 | | | | | | | | | | |
 | | | | | | | | | | |
 | | | | | | | | | |
| B3 AD | 2 BR | 830.8 SF | 1

 | 830.8 SF | | | | | | | | | | | | |
 | | | | | | | | | | | | | |
 | | | | | | | |
 | | | | | | | |
 | | | | | | | | |
 | | | | | | | | | | |
 | | | | | | | | | | |
 | | | | | | | | | |
| B4 AD | 2 BR | 866.5 SF
12273.4 SF | 1
18

 | 866.5 SF
12273.4 | | | | | | | | | | | | |
 | | | | | | | | | | | | | |
 | | | | | | | |
 | | | | | | | |
 | | | | | | | | |
 | | | | | | | | | | |
 | | | | | | | | | | |
 | | | | | | | | | |
| LEVEL 4 | | |

 | | | | | | | | | | | | | |
 | | | | | | | | | | | | | |
 | | | | | | | |
 | | | | | | | |
 | | | | | | | | |
 | | | | | | | | | | |
 | | | | | | | | | | |
 | | | | | | | | | |
| A
A | 1 BR
1 BR | 540 SF
540 SF | 1

 | 540 SF
540 SF | | | | | | | | | | | | |
 | | | | | | | | | | | | | |
 | | | | | | | |
 | | | | | | | |
 | | | | | | | | |
 | | | | | | | | | | |
 | | | | | | | | | | |
 | | | | | | | | | |
| A1 AD | 1 BR | 540 SF | 1

 | 540 SF | | | | | | | | | | | | |
 | | | | | | | | | | | | | |
 | | | | | | | |
 | | | | | | | |
 | | | | | | | | |
 | | | | | | | | | | |
 | | | | | | | | | | |
 | | | | | | | | | |
| A1 AD | 1 BR | 543 SF | 1

 | 543 SF | | | | | | | | | | | | |
 | | | | | | | | | | | | | |
 | | | | | | | |
 | | | | | | | |
 | | | | | | | | |
 | | | | | | | | | | |
 | | | | | | | | | | |
 | | | | | | | | | |
| | 1 | 646.2 SF | 1

 | 646.2 SF | | | | | | | | | | | | |
 | | | | | | | | | | | | | |
 | | | | | | | |
 | | | | | | | |
 | | | | | | | | |
 | | | | | | | | | | |
 | | | | | | | | | | |
 | | | | | | | | | |
| A2 | 1 BR+DEN | 0.00 |

 | | | | | | | | | | | | | |
 | | | | | | | | | | | | | |
 | | | | | | | |
 | | | | | | | |
 | | | | | | | | |
 | | | | | | | | | | |
 | | | | | | | | | | |
 | | | | | | | | | |
| A2
A2 | 1 BR+DEN | 646.2 SF | 1

 | 646.2 SF | | | | | | | | | | | | |
 | | | | | | | | | | | | | |
 | | | | | | | |
 | | | | | | | |
 | | | | | | | | |
 | | | | | | | | | | |
 | | | | | | | | | | |
 | | | | | | | | | |
| A2 | | 646.2 SF
645.4 SF
646.3 SF | 1
1
1

 | 645.4 SF
646.3 SF | | | | | | | | | | | | |
 | | | | | | | | | | | | | |
 | | | | | | | |
 | | | | | | | |
 | | | | | | | | |
 | | | | | | | | | | |
 | | | | | | | | | | |
 | | | | | | | | | |
| A2
A2
A2
A2
A2
A2 | 1 BR+DEN
1 BR+DEN
1 BR+DEN
1 BR+DEN | 645.4 SF
646.3 SF
645.4 SF | 1

 | 645.4 SF
646.3 SF
645.4 SF | | | | | | | | | | | | |
 | | | | | | | | | | | | | |
 | | | | | | | |
 | | | | | | | |
 | | | | | | | | |
 | | | | | | | | | | |
 | | | | | | | | | | |
 | | | | | | | | | |
| A2
A2
A2
A2
A2
A2
A2
A2
A2 | 1 BR+DEN
1 BR+DEN
1 BR+DEN
1 BR+DEN
1 BR+DEN | 645.4 SF
646.3 SF
645.4 SF
646.2 SF | 1
1
1
1
1

 | 645.4 SF
646.3 SF
645.4 SF
646.2 SF | | | | | | | | | | | | |
 | | | | | | | | | | | | | |
 | | | | | | | |
 | | | | | | | |
 | | | | | | | | |
 | | | | | | | | | | |
 | | | | | | | | | | |
 | | | | | | | | | |
| A2
A2
A2
A2
A2
A2
A2
A2
A3 | 1 BR+DEN
1 BR+DEN
1 BR+DEN
1 BR+DEN
1 BR+DEN
1 BR | 645.4 SF
646.3 SF
645.4 SF
646.2 SF
586.9 SF | 1
1
1
1
1
1
1

 | 645.4 SF
646.3 SF
645.4 SF
646.2 SF
586.9 SF | | | | | | | | | | | | |
 | | | | | | | | | | | | | |
 | | | | | | | |
 | | | | | | | |
 | | | | | | | | |
 | | | | | | | | | | |
 | | | | | | | | | | |
 | | | | | | | | | |
| A2
A2
A2
A2
A2
A2
A2
A2
A3
A4 | 1 BR+DEN
1 BR+DEN
1 BR+DEN
1 BR+DEN
1 BR+DEN
1 BR
1 BR
1 BR | 645.4 SF
646.3 SF
645.4 SF
646.2 SF
586.9 SF
645.8 SF | 1
1
1
1
1
1
1
1

 | 645.4 SF
646.3 SF
645.4 SF
646.2 SF
586.9 SF
645.8 SF | | | | | | | | | | | | |
 | | | | | | | | | | | | | |
 | | | | | | | |
 | | | | | | | |
 | | | | | | | | |
 | | | | | | | | | | |
 | | | | | | | | | | |
 | | | | | | | | | |
| A2
A2
A2
A2
A2
A2
A2
A2
A2
A3
A3
A4
B | 1 BR+DEN
1 BR+DEN
1 BR+DEN
1 BR+DEN
1 BR+DEN
1 BR
1 BR
2 BR | 645.4 SF
646.3 SF
645.4 SF
646.2 SF
586.9 SF
645.8 SF
807.9 SF | 1
1
1
 | 645.4 SF
646.3 SF
645.4 SF
646.2 SF
586.9 SF
645.8 SF
807.9 SF | | | | | | | | | | | | |
 | | | | | | | | | | | | | |
 | | | | | | | |
 | | | | | | | |
 | | | | | | | | |
 | | | | | | | | | | |
 | | | | | | | | | | |
 | | | | | | | | | |
| A2
A2
A2
A2
A2
A2
A2
A2
A3
A4 | 1 BR+DEN
1 BR+DEN
1 BR+DEN
1 BR+DEN
1 BR+DEN
1 BR
1 BR
1 BR | 645.4 SF
646.3 SF
645.4 SF
646.2 SF
586.9 SF
645.8 SF | 1
1
1
1
1
1
1
1

 | 645.4 SF
646.3 SF
645.4 SF
646.2 SF
586.9 SF
645.8 SF | | | | | | | | | | | | |
 | | | | | | | | | | | | | |
 | | | | | | | |
 | | | | | | | |
 | | | | | | | | |
 | | | | | | | | | | |
 | | | | | | | | | | |
 | | | | | | | | | |
| A2
A2
A2
A2
A2
A2
A2
A2
A3
A3
A4
B
B1 | 1 BR+DEN
1 BR+DEN
1 BR+DEN
1 BR+DEN
1 BR+DEN
1 BR
1 BR
2 BR
2 BR
2 BR
2 BR
2 BR | 645.4 SF
646.3 SF
645.4 SF
646.2 SF
586.9 SF
645.8 SF
807.9 SF
796.6 SF | 1
1
1
 | 645.4 SF
646.3 SF
645.4 SF
646.2 SF
586.9 SF
645.8 SF
807.9 SF
796.6 SF | | | | | | | | | | | | |
 | | | | | | | | | | | | | |
 | | | | | | | |
 | | | | | | | |
 | | | | | | | | |
 | | | | | | | | | | |
 | | | | | | | | | | |
 | | | | | | | | | |
| A2
A2
A2
A2
A2
A2
A2
A3
A4
B
B1
B2 | 1 BR+DEN
1 BR+DEN
1 BR+DEN
1 BR+DEN
1 BR+DEN
1 BR
1 BR
2 BR
2 BR
2 BR
2 BR | 645.4 SF
646.3 SF
645.4 SF
646.2 SF
586.9 SF
645.8 SF
807.9 SF
796.6 SF
846.4 SF | 1
1
1
 | 645.4 SF
646.3 SF
645.4 SF
646.2 SF
586.9 SF
645.8 SF
807.9 SF
796.6 SF
846.4 SF | | | | | | | | | | | | |
 | | | | | | | | | | | | | |
 | | | | | | | |
 | | | | | | | |
 | | | | | | | | |
 | | | | | | | | | | |
 | | | | | | | | | | |
 | | | | | | | | | |
| A2
A2
A2
A2
A2
A2
A2
A2
A2
A3
A3
A4
B
B1
B2
B2
B2
B3
AD | 1 BR+DEN
1 BR+DEN
1 BR+DEN
1 BR+DEN
1 BR+DEN
1 BR
2 BR
2 BR
2 BR
2 BR
2 BR
2 BR
2 BR
2 BR | 645.4 SF
646.3 SF
645.4 SF
646.2 SF
586.9 SF
645.8 SF
807.9 SF
796.6 SF
846.4 SF
854 SF
830.8 SF | 1

 | 645.4 SF
646.3 SF
645.4 SF
646.2 SF
586.9 SF
645.8 SF
807.9 SF
796.6 SF
846.4 SF
854 SF
830.8 SF | | | | | | | | | | | | |
 | | | | | | | | | | | | | |
 | | | | | | | |
 | | | | | | | |
 | | | | | | | | |
 | | | | | | | | | | |
 | | | | | | | | | | |
 | | | | | | | | | |
| A2
A2
A2
A2
A2
A2
A2
A3
A4
B
B1
B2
B3
AD
B4
AD
B4
AD | 1 BR+DEN
1 BR+DEN
1 BR+DEN
1 BR+DEN
1 BR+DEN
1 BR
2 BR
2 BR
2 BR
2 BR
2 BR
2 BR
2 BR
2 BR | 645.4 SF
646.3 SF
645.4 SF
646.2 SF
586.9 SF
645.8 SF
807.9 SF
796.6 SF
846.4 SF
854 SF
830.8 SF
866.5 SF
12273.5 SF | 1 18

 | 645.4 SF
646.3 SF
645.4 SF
646.2 SF
586.9 SF
645.8 SF
807.9 SF
796.6 SF
846.4 SF
854 SF
830.8 SF
866.5 SF
12273.5 SF | | | | | | | | | | | | |
 | | | | | | | | | | | | | |
 | | | | | | | |
 | | | | | | | |
 | | | | | | | | |
 | | | | | | | | | | |
 | | | | | | | | | | |
 | | | | | | | | | |
| A2
A2
A2
A | 1 BR+DEN
1 BR+DEN
1 BR+DEN
1 BR+DEN
1 BR
1 BR
2 BR
2 BR
2 BR
2 BR
2 BR
2 BR
2 BR
2 BR
1 BR
1 BR
1 BR | 645.4 SF
646.3 SF
646.2 SF
586.9 SF
645.8 SF
807.9 SF
796.6 SF
846.4 SF
854 SF
830.8 SF
866.5 SF
12273.5 SF
540 SF | 1

 | 645.4 SF
646.3 SF
645.4 SF
646.2 SF
586.9 SF
645.8 SF
807.9 SF
796.6 SF
846.4 SF
854 SF
830.8 SF
866.5 SF
12273.5 S
540 SF
540 SF | | | | | | | | | | | | |
 | | | | | | | | | | | | | |
 | | | | | | | |
 | | | | | | | |
 | | | | | | | | |
 | | | | | | | | | | |
 | | | | | | | | | | |
 | | | | | | | | | |
| A2
A2
A2
A2
A2
A2
A2
A3
A3
A4
B
B1
B2
B3
AD
B2
B3
AD
B4
AD
EVEL 5
A
A
A1
AD | 1 BR+DEN 1 BR+DEN 1 BR+DEN 1 BR+DEN 1 BR 2 BR 1 BR | 645.4 SF
646.3 SF
646.3 SF
646.2 SF
586.9 SF
645.8 SF
807.9 SF
796.6 SF
846.4 SF
854 SF
830.8 SF
866.5 SF
12273.5 SF
540 SF
540 SF | 1

 | 645.4 SF
646.3 SF
645.4 SF
646.2 SF
586.9 SF
645.8 SF
807.9 SF
796.6 SF
846.4 SF
854 SF
830.8 SF
866.5 SF
12273.5 SF
540 SF
540 SF | | | | | | | | | | | | |
 | | | | | | | | | | | | | |
 | | | | | | | | |
 | | | | | | |
 | | | | | | | | |
 | | | | | | | | | | |
 | | | | | | | | | | |
 | | | | | | | | | |
| A2
A2
A2
A2
A2
A2
A2
A3
A3
A4
B
B1
B2
B3
A0
B4
AD
EVEL 5
A
A
A1
AD
A1
AD | 1 BR+DEN 1 BR+DEN 1 BR+DEN 1 BR+DEN 1 BR 2 BR 1 BR | 645.4 SF
646.3 SF
645.4 SF
646.2 SF
586.9 SF
645.8 SF
807.9 SF
796.6 SF
846.4 SF
854 SF
830.8 SF
866.5 SF
12273.5 SF
540 SF
540 SF
540 SF
543 SF | 1

 | 645.4 SF
646.3 SF
645.4 SF
646.2 SF
586.9 SF
645.8 SF
807.9 SF
796.6 SF
846.4 SF
854 SF
830.8 SF
866.5 SF
12273.5 S
540 SF
540 SF
540 SF
543 SF | | | | | | | | | | | | |
 | | | | | | | | | | | | | |
 | | | | | | | | |
 | | | | | | |
 | | | | | | | | |
 | | | | | | | | | | |
 | | | | | | | | | | |
 | | | | | | | | | |
| A2
A2
A2
A2
A2
A2
A2
A3
A4
B
B1
B2
B2
B3
AD
B4
AD
LEVEL 5
A
A
A1
AD
A1
AD
A2 | 1 BR+DEN 1 BR+DEN 1 BR+DEN 1 BR+DEN 1 BR 2 BR 1 BR | 645.4 SF
646.3 SF
646.3 SF
646.2 SF
586.9 SF
645.8 SF
807.9 SF
796.6 SF
846.4 SF
854 SF
830.8 SF
866.5 SF
12273.5 SF
540 SF
540 SF | 1

 | 645.4 SF
646.3 SF
645.4 SF
646.2 SF
586.9 SF
645.8 SF
807.9 SF
796.6 SF
846.4 SF
854 SF
830.8 SF
866.5 SF
12273.5 SF
540 SF
540 SF | | | | | | | | | | | | |
 | | | | | | | | | | | | | |
 | | | | | | | | |
 | | | | | | |
 | | | | | | | | |
 | | | | | | | | | | |
 | | | | | | | | | | |
 | | | | | | | | | |
| A2
A2
A2
A2
A2
A2
A2
A3
A3
A4
B
B1
B2
B3
AD
B2
B3
AD
B4
AD
EVEL 5
A
A
A1
AD | 1 BR+DEN 1 BR+DEN 1 BR+DEN 1 BR+DEN 1 BR 1 BR 2 BR 1 BR | 645.4 SF
646.3 SF
646.2 SF
586.9 SF
645.8 SF
807.9 SF
796.6 SF
846.4 SF
854 SF
830.8 SF
830.8 SF
12273.5 SF
540 SF
540 SF
540 SF
543 SF
646.2 SF | 1

 | 645.4 SF
646.3 SF
645.4 SF
646.2 SF
645.8 SF
807.9 SF
796.6 SF
846.4 SF
854 SF
830.8 SF
866.5 SF
12273.5 SF
540 SF
540 SF
540 SF
543 SF
646.2 SF | | | | | | | | | | | | |
 | | | | | | | | | | | | | |
 | | | | | | | | |
 | | | | | | |
 | | | | | | | | |
 | | | | | | | | | | |
 | | | | | | | | | | | |
 | | | | | | | | |
| A2
A2
A2
A2
A2
A2
A2
A3
A3
A4
B
B1
B2
B3
A0
B4
A0
B4
AD
B2
B3
AD
B4
AD
A1
AD
A1
AD
A1
AD
A2
A2
A2
A2 | 1 BR+DEN 1 BR+DEN 1 BR+DEN 1 BR+DEN 1 BR 1 BR 2 BR 1 BR+DEN 1 BR+DEN 1 BR+DEN 1 BR+DEN | 645.4 SF
646.3 SF
646.3 SF
645.4 SF
586.9 SF
645.8 SF
807.9 SF
796.6 SF
846.4 SF
854 SF
830.8 SF
866.5 SF
12273.5 SF
540 SF
540 SF
540 SF
540 SF
543 SF
646.2 SF
646.2 SF
646.3 SF | 1

 | 645.4 SF
646.3 SF
645.4 SF
646.2 SF
645.8 SF
807.9 SF
796.6 SF
846.4 SF
854 SF
830.8 SF
866.5 SF
12273.5
540 SF
540 SF
540 SF
540 SF
646.2 SF
646.2 SF
646.3 SF | | | | | | | | | | | | |
 | | | | | | | | | | | | | |
 | | | | | | | | |
 | | | | | | |
 | | | | | | | | |
 | | | | | | | | | | |
 | | | | | | | | | | |
 | | | | | | | | | |
| A2
A2
A2
A2
A2
A2
A2
A2
A2
A3
A4
B
B
B | 1 BR+DEN 1 BR+DEN 1 BR+DEN 1 BR+DEN 1 BR 1 BR 2 BR 1 BR+DEN | 645.4 SF
646.3 SF
646.2 SF
586.9 SF
645.8 SF
807.9 SF
796.6 SF
846.4 SF
854 SF
830.8 SF
830.8 SF
12273.5 SF
540 SF
540 SF
540 SF
543 SF
646.2 SF
646.2 SF
646.3 SF
645.4 SF | 1

 | 645.4 SF
646.3 SF
645.4 SF
646.2 SF
645.8 SF
807.9 SF
796.6 SF
846.4 SF
854 SF
830.8 SF
866.5 SF
12273.5 SF
540 SF
540 SF
540 SF
543 SF
646.2 SF
646.2 SF
646.3 SF
645.4 SF | | | | | | | | | | | | | |
 | | | | | | | | | | | | | | |
 | | | | | | | |
 | | | | | | |
 | | | | | | | | |
 | | | | | | | | | | |
 | | | | | | | | | | | |
 | | | | | | | | |
| A2
A2
A2
A2
A2
A2
A2
A2
A2
A0
A3
A4
B
B
B | 1 BR+DEN 1 BR+DEN 1 BR+DEN 1 BR+DEN 1 BR 1 BR 2 BR 1 BR+DEN | 645.4 SF
646.3 SF
646.2 SF
586.9 SF
645.8 SF
807.9 SF
796.6 SF
846.4 SF
854 SF
830.8 SF
830.8 SF
866.5 SF
12273.5 SF
540 SF
540 SF
540 SF
543 SF
646.2 SF
646.2 SF
646.3 SF
645.4 SF | 1

 | 645.4 SF
646.3 SF
645.4 SF
645.2 SF
645.8 SF
807.9 SF
796.6 SF
846.4 SF
854 SF
830.8 SF
866.5 SF
12273.5 S
540 SF
540 SF
540 SF
540 SF
646.2 SF
646.2 SF
645.2 SF
645.4 SF | | | | | | | | | | | | | |
 | | | | | | | | | | | | | | |
 | | | | | | | |
 | | | | | | |
 | | | | | | | | |
 | | | | | | | | | | |
 | | | | | | | | | | | |
 | | | | | | | | |
| A2
A2
A2
A2
A2
A2
A2
A2
A2
A3
A4
B
B
B | 1 BR+DEN 1 BR+DEN 1 BR+DEN 1 BR+DEN 1 BR 1 BR 2 BR 1 BR+DEN | 645.4 SF
646.3 SF
646.2 SF
586.9 SF
645.8 SF
807.9 SF
796.6 SF
846.4 SF
854 SF
830.8 SF
830.8 SF
12273.5 SF
540 SF
540 SF
540 SF
543 SF
646.2 SF
646.2 SF
646.3 SF
645.4 SF | 1

 | 645.4 SF
646.3 SF
645.4 SF
646.2 SF
586.9 SF
645.8 SF
807.9 SF
796.6 SF
846.4 SF
854 SF
830.8 SF
866.5 SF
12273.5
540 SF
540 SF
540 SF
540 SF
646.2 SF
646.2 SF
646.3 SF
646.3 SF
646.2 SF
646.3 SF | | | | | | | | | | | | | |
 | | | | | | | | | | | | | | |
 | | | | | | | |
 | | | | | | |
 | | | | | | | | |
 | | | | | | | | | | |
 | | | | | | | | | | | |
 | | | | | | | | |
| A2
A2
A2
A2
A2
A2
A2
A2
A2
A0
A3
A3
A4
B
B
B | 1 BR+DEN 1 BR+DEN 1 BR+DEN 1 BR+DEN 1 BR 1 BR 2 BR 1 BR+DEN 1 BR 1 BR 1 BR | 645.4 SF
646.3 SF
646.3 SF
645.4 SF
646.2 SF
586.9 SF
645.8 SF
807.9 SF
796.6 SF
846.4 SF
854 SF
830.8 SF
866.5 SF
12273.5 SF
540 SF
540 SF
540 SF
540 SF
543 SF
646.2 SF
646.2 SF
645.2 SF
645.2 SF
645.2 SF | 1

 | 645.4 SF
646.3 SF
645.4 SF
645.2 SF
645.8 SF
807.9 SF
796.6 SF
846.4 SF
854 SF
830.8 SF
866.5 SF
12273.5 S
540 SF
540 SF
540 SF
540 SF
646.2 SF
646.2 SF
645.2 SF
645.4 SF | | | | | | | | | | | | | |
 | | | | | | | | | | | | | | |
 | | | | | | | |
 | | | | | | |
 | | | | | | | | |
 | | | | | | | | | | |
 | | | | | | | | | | | |
 | | | | | | | | |
| A2
A2
A2
A3
A4
B
B1
B2
B3
A0
B1
B2
B3
A0
B3
A0
A1
A0
A1
A0
A2
A2
A3
A4
B
B
B1 | 1 BR+DEN
1 BR+DEN
1 BR+DEN
1 BR+DEN
1 BR+DEN
1 BR
2 BR
1 BR | 645.4 SF
646.3 SF
646.2 SF
586.9 SF
645.8 SF
807.9 SF
796.6 SF
846.4 SF
830.8 SF
830.8 SF
866.5 SF
12273.5 SF
540 SF
540 SF
540 SF
540 SF
543 SF
646.2 SF
646.2 SF
646.2 SF
645.2 SF
645.2 SF
645.2 SF
645.3 SF
645.4 SF
586.9 SF
586.9 SF
586.9 SF | 1 1 1 1 <td>645.4 SF
646.3 SF
645.4 SF
645.2 SF
645.8 SF
807.9 SF
796.6 SF
846.4 SF
830.8 SF
866.5 SF
12273.5 S
540 SF
540 SF
540 SF
540 SF
646.2 SF
646.2 SF
645.2 SF
645.3 SF
645.3 SF
645.4 SF
807.9 SF
586.9 SF</td>

 | 645.4 SF
646.3 SF
645.4 SF
645.2 SF
645.8 SF
807.9 SF
796.6 SF
846.4 SF
830.8 SF
866.5 SF
12273.5 S
540 SF
540 SF
540 SF
540 SF
646.2 SF
646.2 SF
645.2 SF
645.3 SF
645.3 SF
645.4 SF
807.9 SF
586.9 SF
 | | | | | | | | | | | | | |
 | | | | | | | | | | | | |
 | | | | | | | |
 | | | | | | | |
 | | | | | | | | |
 | | | | | | | | | | |
 | | | | | | | | | | |
 | | | | | | |
| A2
A2
A2
A0
A3
A4
B
B
B
B
B
B
B
C
B
C
B
C
C
C
C
C
C
C
C | 1 BR+DEN 1 BR+DEN 1 BR+DEN 1 BR+DEN 1 BR 1 BR 1 BR 2 BR 1 BR+DEN 1 BR+DEN 1 BR+DEN 1 BR+DEN 1 BR+DEN 1 BR+DEN 1 BR 2 BR | 645.4 SF
646.3 SF
646.2 SF
586.9 SF
645.8 SF
807.9 SF
796.6 SF
846.4 SF
830.8 SF
830.8 SF
866.5 SF
12273.5 SF
540 SF
540 SF
540 SF
540 SF
540 SF
646.2 SF
646.2 SF
646.2 SF
645.2 SF
645.3 SF
645.3 SF
645.4 SF
586.9 SF
586.9 SF
807.9 SF
796.6 SF
846.4 SF | 1 1 1

 | 645.4 SF
646.3 SF
645.4 SF
646.2 SF
586.9 SF
645.8 SF
807.9 SF
796.6 SF
846.4 SF
830.8 SF
866.5 SF
12273.5 S
540 SF
540 SF
540 SF
540 SF
646.2 SF
646.2 SF
646.2 SF
646.3 SF
645.4 SF
645.4 SF
645.8 SF
807.9 SF
796.6 SF
846.4 SF | | | | | | | | | | | | | |
 | | | | | | | | | | | | | | |
 | | | | | | | |
 | | | | | | |
 | | | | | | | | |
 | | | | | | | | | | |
 | | | | | | | | | | | |
 | | | | | | | | |
| A2
A2
A2
A2
A2
A2
A2
A2
A3
A3
A4
B
B
C
C
C
C
C
C
C
C
C | 1 BR+DEN 1 BR+DEN 1 BR+DEN 1 BR+DEN 1 BR 1 BR 2 BR 1 BR+DEN 1 BR+DEN 1 BR+DEN 1 BR+DEN 1 BR+DEN 1 BR 2 BR | 645.4 SF
646.3 SF
645.4 SF
646.2 SF
586.9 SF
645.8 SF
807.9 SF
796.6 SF
846.4 SF
830.8 SF
830.8 SF
866.5 SF
12273.5 SF
540 SF
540 SF
540 SF
540 SF
540 SF
646.2 SF
646.2 SF
646.2 SF
646.3 SF
646.3 SF
645.4 SF
646.3 SF
645.8 SF
807.9 SF
796.6 SF
846.4 SF | 1 1 1 1 <td>645.4 SF
646.3 SF
645.4 SF
646.2 SF
586.9 SF
645.8 SF
807.9 SF
796.6 SF
846.4 SF
830.8 SF
866.5 SF
12273.5 S
540 SF
540 SF
540 SF
540 SF
646.2 SF
646.2 SF
646.3 SF
645.2 SF
645.4 SF
645.8 SF
807.9 SF
796.6 SF
846.4 SF</td>

 | 645.4 SF
646.3 SF
645.4 SF
646.2 SF
586.9 SF
645.8 SF
807.9 SF
796.6 SF
846.4 SF
830.8 SF
866.5 SF
12273.5 S
540 SF
540 SF
540 SF
540 SF
646.2 SF
646.2 SF
646.3 SF
645.2 SF
645.4 SF
645.8 SF
807.9 SF
796.6 SF
846.4 SF | | | | | | | | | | | | |
 | | | | | | | | | | | | | |
 | | | | | | | |
 | | | | | | |
 | | | | | | | | |
 | | | | | | | | | | |
 | | | | | | | | | | | |
 | | | | | | | | |
| A2
A2
A2
A3
A4
B
B1
B2
B2
B3
AD
B4
AD
B2
B3
AD
A1
AD
A1
AD
A1
AD
A2
A2
A2 | 1 BR+DEN 1 BR+DEN 1 BR+DEN 1 BR+DEN 1 BR 1 BR 1 BR 2 BR 1 BR+DEN 1 BR+DEN 1 BR+DEN 1 BR+DEN 1 BR+DEN 1 BR+DEN 1 BR 2 BR | 645.4 SF
646.3 SF
646.2 SF
586.9 SF
645.8 SF
807.9 SF
796.6 SF
846.4 SF
830.8 SF
830.8 SF
866.5 SF
12273.5 SF
540 SF
540 SF
540 SF
540 SF
540 SF
646.2 SF
646.2 SF
646.2 SF
645.2 SF
645.3 SF
645.3 SF
645.4 SF
586.9 SF
586.9 SF
807.9 SF
796.6 SF
846.4 SF | 1 1 1

 | 645.4 SF
646.3 SF
645.4 SF
646.2 SF
586.9 SF
645.8 SF
807.9 SF
796.6 SF
846.4 SF
830.8 SF
866.5 SF
12273.5 S
540 SF
540 SF
540 SF
540 SF
646.2 SF
646.2 SF
646.2 SF
646.3 SF
645.4 SF
645.4 SF
645.8 SF
807.9 SF
796.6 SF
846.4 SF | | | | | | | | | | | | | |
 | | | | | | | | | | | | | | |
 | | | | | | | |
 | | | | | | |
 | | | | | | | | |
 | | | | | | | | | | |
 | | | | | | | | | | | |
 | | | | | | | | |
| A2
A2
A2
A0
A3
A4
B
B
B
B
B
B
B
C
B
C
B
C
C
C
C
C
C
C
C | 1 BR+DEN 1 BR+DEN 1 BR+DEN 1 BR+DEN 1 BR 1 BR 2 BR 1 BR 1 BR 1 BR 1 BR 1 BR 1 BR+DEN 1 BR+DEN 1 BR+DEN 1 BR+DEN 1 BR+DEN 1 BR 2 BR | 645.4 SF 646.3 SF 646.2 SF 586.9 SF 645.8 SF 807.9 SF 796.6 SF 846.4 SF 830.8 SF 866.5 SF 12273.5 SF 540 SF 540 SF 543 SF 646.2 SF 646.2 SF 646.2 SF 646.2 SF 646.2 SF 646.2 SF 646.3 SF 645.4 SF 646.3 SF 645.4 SF 646.5 SF 540 SF | 1 1 <tr td=""> <!--</td--><td>645.4 SF
646.3 SF
645.4 SF
646.2 SF
586.9 SF
645.8 SF
807.9 SF
796.6 SF
846.4 SF
830.8 SF
866.5 SF
12273.5 S
540 SF
540 SF
540 SF
540 SF
646.2 SF
646.2 SF
646.2 SF
645.2 SF
645.3 SF
645.4 SF
807.9 SF
796.6 SF
846.4 SF
854 SF
830.8 SF</td></tr> <tr><td>A2
A2
A2
A2
A2
A2
A2
A2
A2
A3
A3
A4
B
B
B
B
B
B
C
B
C
C
C</td><td>1 BR+DEN 1 BR+DEN 1 BR+DEN 1 BR+DEN 1 BR 1 BR 2 BR 1 BR 1 BR 1 BR 1 BR 1 BR+DEN 1 BR+DEN 1 BR+DEN 1 BR+DEN 1 BR+DEN 1 BR 2 BR</td><td>645.4 SF 646.3 SF 646.4 SF 646.2 SF 586.9 SF 645.8 SF 807.9 SF 796.6 SF 846.4 SF 854 SF 830.8 SF 866.5 SF 12273.5 SF 540 SF 540 SF 540 SF 540 SF 646.2 SF 646.2 SF 646.2 SF 646.2 SF 646.3 SF 645.4 SF 807.9 SF 796.6 SF 846.4 SF 846.3 SF 645.2 SF 645.2 SF 645.3 SF 807.9 SF 796.6 SF 807.9 SF 796.6 SF 846.4 SF 830.8 SF 830.8 SF 866.5 SF 12273.4 SF</td><td>1 <td< td=""><td>645.4 SF
646.3 SF
645.4 SF
646.2 SF
586.9 SF
645.8 SF
807.9 SF
796.6 SF
846.4 SF
830.8 SF
866.5 SF
12273.5 S
540 SF
540 SF
540 SF
540 SF
646.2 SF
646.2 SF
646.2 SF
645.2 SF
645.2 SF
645.3 SF
645.3 SF
645.4 SF
807.9 SF
796.6 SF
846.4 SF
830.8 SF
830.8 SF
830.8 SF
830.8 SF
866.5 SF</td></td<></td></tr>
<tr><td>A2
A2
A2
A2
A2
A2
A2
A2
A2
A3
A4
B
B1
B2
B3
A0
B3
A0
A1
A0
A1
A1
A0
A1
A1
A0
A1
A1
A0
A1
A1
A0
A1
A1
A1</td><td>1 BR+DEN 1 BR+DEN 1 BR+DEN 1 BR+DEN 1 BR 1 BR 2 BR 1 BR 1 BR 1 BR 1 BR 1 BR 1 BR+DEN 1 BR+DEN 1 BR+DEN 1 BR+DEN 1 BR+DEN 1 BR 2 BR</td><td>645.4 SF 646.3 SF 646.2 SF 586.9 SF 645.8 SF 807.9 SF 796.6 SF 846.4 SF 830.8 SF 866.5 SF 12273.5 SF 540 SF 543 SF 646.2 SF 646.2 SF 645.2 SF 645.2 SF 645.2 SF 645.3 SF 645.4 SF 807.9 SF 796.6 SF 807.9 SF 796.6 SF 846.4 SF 830.8 SF 807.9 SF 796.6 SF 846.4 SF 854 SF 830.8 SF 866.5 SF 12273.4 SF</td><td>1 <td< td=""><td>645.4 SF 646.3 SF 645.4 SF 646.2 SF 586.9 SF 645.8 SF 807.9 SF 796.6 SF 846.4 SF 830.8 SF 866.5 SF 12273.5 S 540 SF 540 SF 540 SF 646.2 SF 646.2 SF 646.2 SF 646.2 SF 646.2 SF 646.2 SF 646.3 SF 645.4 SF 646.3 SF 645.4 SF 645.5 SF 796.6 SF 807.9 SF 796.6 SF 807.9 SF 796.6 SF 830.8 SF 830.8 SF 846.4 SF 854 SF 830.8 SF 866.5 SF 12273.4 S</td></td<></td></tr> <tr><td>A2
A2
A2
A2
A2
A2
A2
A2
A2
A3
A4
B
B
B
B
B
B
C
B
C
C
C</td><td>1 BR+DEN 1 BR+DEN 1 BR+DEN 1 BR+DEN 1 BR 1 BR 2 BR 1 BR+DEN 1 BR+DEN 1 BR+DEN 1 BR+DEN 1 BR 2 BR</td><td>645.4 SF 646.3 SF 646.4 SF 646.2 SF 586.9 SF 645.8 SF 807.9 SF 796.6 SF 846.4 SF 854 SF 830.8 SF 866.5 SF 12273.5 SF 540 SF 540 SF 540 SF 540 SF 646.2 SF 646.2 SF 646.2 SF 646.2 SF 646.3 SF 645.4 SF 807.9 SF 796.6 SF 846.4 SF 846.3 SF 645.2 SF 645.2 SF 645.3 SF 807.9 SF 796.6 SF 807.9 SF 796.6 SF 846.4 SF 830.8 SF 830.8 SF 866.5 SF 12273.4 SF</td><td>1 <td< td=""><td>645.4 SF
646.3 SF
645.4 SF
646.2 SF
586.9 SF
645.8 SF
807.9 SF
796.6 SF
846.4 SF
830.8 SF
866.5 SF
12273.5 S
540 SF
540 SF
540 SF
540 SF
646.2 SF
646.2 SF
646.2 SF
645.2 SF
645.2 SF
645.3 SF
645.3 SF
645.4 SF
807.9 SF
796.6 SF
846.4 SF
830.8 SF
830.8 SF
830.8 SF
830.8 SF
866.5 SF</td></td<></td></tr> <tr><td>A2
A2
A2
A3
A4
B
B
B
B
B
B
B
C
B
C
C
C</td><td>1 BR+DEN 1 BR+DEN 1 BR+DEN 1 BR+DEN 1 BR 1 BR 2 BR 1 BR 1 BR 1 BR 1 BR 1 BR 1 BR+DEN 1 BR+DEN 1 BR+DEN 1 BR+DEN 1 BR 2 BR 1 BR</td><td>645.4 SF 646.3 SF 646.2 SF 586.9 SF 645.8 SF 807.9 SF 796.6 SF 846.4 SF 854 SF 830.8 SF 866.5 SF 12273.5 SF 540 SF 540 SF 540 SF 540 SF 645.2 SF 646.2 SF 646.2 SF 646.2 SF 646.2 SF 646.3 SF 645.4 SF 807.9 SF 646.3 SF 645.4 SF 807.9 SF 796.6 SF 846.4 SF 807.9 SF 796.6 SF 846.4 SF 807.9 SF 796.6 SF 846.4 SF 830.8 SF 803.8 SF 866.5 SF 12273.4 SF 540 SF</td><td>1 <td< td=""><td>645.4 SF 646.3 SF 645.4 SF 646.2 SF 586.9 SF 645.8 SF 807.9 SF 796.6 SF 846.4 SF 830.8 SF 830.8 SF 846.4 SF 854 SF 830.8 SF 646.2 SF 540 SF 540 SF 540 SF 646.2 SF 646.2 SF 646.3 SF 645.4 SF 646.3 SF 645.4 SF 646.3 SF 645.4 SF 846.4 SF 846.4 SF 846.4 SF 830.8 SF 846.4 SF 830.8 SF 846.4 SF 830.8 SF 830.8 SF 846.4 SF 830.8 SF 846.5 SF 12273.4 S 540 SF 540 SF 540 SF 540 SF 540 SF 540 SF 540 SF <</td></td<></td></tr> <tr><td>A2
A2
A2
A3
A4
B
B1
B2
B3
A0
B1
B2
B3
A0
A1
A0
A1
A0
A1
A0
A1
A0
A2
A2
A2</td><td>1 BR+DEN 1 BR+DEN 1 BR+DEN 1 BR+DEN 1 BR 1 BR 2 BR 1 BR 1 BR 1 BR 1 BR 1 BR 1 BR+DEN 1 BR+DEN 1 BR+DEN 1 BR+DEN 1 BR 2 BR 1 BR</td><td>645.4 SF 646.3 SF 646.2 SF 586.9 SF 645.8 SF 807.9 SF 796.6 SF 846.4 SF 830.8 SF 866.5 SF 12273.5 SF 540 SF 543 SF 646.2 SF 645.2 SF 645.2 SF 645.3 SF 645.4 SF 807.9 SF 796.6 SF 846.4 SF 807.9 SF 796.6 SF 846.4 SF 830.8 SF 807.9 SF 796.6 SF 846.4 SF 830.8 SF 830.8 SF 830.8 SF 840.4 SF 840.4 SF 854 SF 830.8 SF 846.5 SF 12273.4 SF 540 SF 540 SF 540 SF</td><td>1 1 1 1 1 1 1 1 1 1 1
 1 <td< td=""><td>645.4 SF 646.3 SF 645.4 SF 646.2 SF 586.9 SF 645.8 SF 807.9 SF 796.6 SF 846.4 SF 830.8 SF 866.5 SF 12273.5 540 SF 540 SF 540 SF 540 SF 645.2 SF 646.2 SF 646.2 SF 646.2 SF 646.3 SF 646.3 SF 645.4 SF 645.3 SF 645.4 SF 645.5 SF 796.6 SF 807.9 SF 796.6 SF 830.8 SF 846.4 SF 854 SF 830.8 SF 846.4 SF 854 SF 830.8 SF 846.4 SF 854 SF 830.8 SF 846.5 SF 12273.4 S 540 SF 540 SF 540 SF 540 SF 540 SF </td></td<></td></tr> <tr><td>A2
A2
A2
A3
A4
B
B
B
B
B
C
B
C
C
C</td><td>1 BR+DEN 1 BR+DEN 1 BR+DEN 1 BR+DEN 1 BR 1 BR 2 BR 1 BR+DEN 1 BR+DEN 1 BR+DEN 1 BR 1 BR 2 BR 1 BR <t< td=""><td>645.4 SF 646.3 SF 646.2 SF 586.9 SF 645.8 SF 807.9 SF 796.6 SF 846.4 SF 830.8 SF 866.5 SF 12273.5 SF 540 SF 646.2 SF 646.2 SF 646.2 SF 646.3 SF 645.4 SF 646.3 SF 645.4 SF 645.4 SF 645.3 SF 645.4 SF 807.9 SF 796.6 SF 807.9 SF 796.6 SF 807.9 SF 796.6 SF 807.9 SF 796.6 SF 830.8 SF 830.8 SF 830.8 SF 846.4 SF 854 SF 830.8 SF 540 SF 540 SF 540 SF 540 SF 540 SF 540 SF <!--</td--><td>1 <td< td=""><td>645.4 SF 646.3 SF 645.4 SF 646.2 SF 586.9 SF 645.8 SF 807.9 SF 796.6 SF 846.4 SF 830.8 SF 830.8 SF 846.4 SF 846.4 SF 846.4 SF 846.4 SF 846.5 SF 12273.5 S 540 SF 540 SF 540 SF 646.2 SF 646.2 SF 646.3 SF 646.2 SF 646.3 SF 645.4 SF 846.4 SF 846.4 SF 846.4 SF 846.4 SF 830.8 SF 846.4 SF 854 SF 830.8 SF 846.4 SF 854 SF 830.8 SF 846.4 SF 854 SF 830.8 SF 540 SF 540 SF 540 SF 540 SF 540 SF 540 SF </td></td<></td></td></t<></td></tr> <tr><td>A2 A2 A2 A2 A2 A2 A2 A2 A2 A3 A4 B B1 B2 B3 A0 A1 A1 A2 A2 A2 A2 A1 A2 A3 A4 B B1 B2 B3 B4 A0 LEVEL A A1 A0 A1 A1 A2 <tr td=""> <tr td=""></tr></tr></td><td>1 BR+DEN 1 BR+DEN 1 BR+DEN 1 BR+DEN 1 BR 1 BR 2 BR 1 BR+DEN 1 BR+DEN 1 BR 1 BR 1 BR 2 BR 1 BR 1 BR 1</td><td>645.4 SF 646.3 SF 646.2 SF 586.9 SF 645.8 SF 807.9 SF 796.6 SF 846.4 SF 830.8 SF 866.5 SF 12273.5 SF 540 SF 540 SF 540 SF 540 SF 646.2 SF 646.2 SF 646.3 SF 646.2 SF 646.2 SF 646.2 SF 646.2 SF 646.3 SF 646.3 SF 646.3 SF 646.3 SF 646.3 SF 646.3 SF 645.4 SF 807.9 SF 645.8 SF 807.9 SF 645.8 SF 807.9 SF 645.8 SF 807.9 SF 796.6 SF 830.8 SF 866.5 SF 12273.4 SF 540 SF</td><td>1 <td< td=""><td>645.4 SF 646.3 SF 645.4 SF 646.2 SF 586.9 SF 645.8 SF 807.9 SF 796.6 SF 846.4 SF 830.8 SF 866.5 SF 12273.5 540 SF 540 SF 540 SF 540 SF 646.2 SF 646.2 SF 646.2 SF 646.2 SF 646.3 SF 646.3 SF 646.3 SF 646.3 SF 645.4 SF 846.4 SF 846.4 SF 846.5 SF 12273.4 S 540 SF 540 SF 645.2 SF 645.3 SF 807.9 SF 796.6 SF 846.4 SF 854 SF 830.8 SF 846.4 SF 846.5 SF 12273.4 S 540 SF 540 SF 540 SF 540 SF 540 SF </td></td<></td></tr> <tr><td>A2
A2
A2
A3
A4
B
B
B
B
B
C
B
C
C
C</td><td>1 BR+DEN 1 BR+DEN 1 BR+DEN 1 BR+DEN 1 BR 1 BR 2 BR 1 BR+DEN 1 BR+DEN 1 BR+DEN 1 BR 1 BR 2 BR 1 BR <t< td=""><td>645.4 SF 646.3 SF 646.2 SF 586.9 SF 645.8 SF 807.9 SF 796.6 SF 846.4 SF 830.8 SF 866.5 SF 12273.5 SF 540 SF 646.2 SF 646.2 SF 646.2 SF 646.3 SF 645.4 SF 646.3 SF 645.4 SF 645.4 SF 645.3 SF 645.4 SF 807.9 SF 796.6 SF 807.9 SF 796.6 SF 807.9 SF 796.6 SF 807.9 SF 796.6 SF 830.8 SF 830.8 SF 830.8 SF 846.4 SF 854 SF 830.8 SF 540 SF 540 SF 540 SF 540 SF 540 SF 540 SF <!--</td--><td>1 <td< td=""><td>645.4 SF 646.3 SF 645.4 SF 646.2 SF 586.9 SF 645.8 SF 807.9 SF 796.6 SF 846.4 SF 830.8 SF 830.8 SF 846.4 SF 854 SF 830.8 SF 646.2 SF 540 SF 540 SF 540 SF 646.2 SF 646.2 SF 646.3 SF 645.4 SF 646.3 SF 646.3 SF 645.4 SF 846.4 SF 846.4 SF 846.5 SF 807.9 SF 645.8 SF 807.9 SF 645.8 SF 830.8 SF 830.8 SF 846.4 SF 830.8 SF 846.5 SF 12273.4 S 540 SF 540 SF </td></td<></td></td></t<></td></tr> <tr><td>A2
A2
A2
A3
A4
B
B
B
B
B
B
B
C
C
C</td><td>1 BR+DEN 1 BR+DEN 1 BR+DEN 1 BR+DEN 1 BR 1 BR 2 BR 1 BR+DEN 1 BR+DEN 1 BR+DEN 1 BR+DEN 1 BR 2 BR 1 BR+DEN 1 BR+DEN <</td><td>645.4 SF 646.3 SF 646.2 SF 586.9 SF 645.8 SF 807.9 SF 796.6 SF 846.4 SF 854 SF 830.8 SF 866.5 SF 12273.5 SF 540 SF 540 SF 540 SF 646.2 SF 646.2 SF
 646.2 SF 646.2 SF 646.2 SF 646.2 SF 646.3 SF 646.3 SF 646.3 SF 646.3 SF 646.3 SF 646.5 SF 12273.4 SF 540 SF 540 SF 540 SF 540 SF 645.2 SF 646.2 SF 646.3 SF 807.9 SF 796.6 SF 830.8 SF 830.8 SF 830.8 SF 846.4 SF 830.8 SF 846.5 SF 12273.4 SF 540 SF 540 SF 540 SF 540 SF<td>1 <td< td=""><td>645.4 SF 646.3 SF 645.4 SF 646.2 SF 586.9 SF 645.8 SF 807.9 SF 796.6 SF 846.4 SF 830.8 SF 830.8 SF 846.4 SF 846.5 SF 12273.5 S 540 SF 540 SF 645.2 SF 646.2 SF 646.2 SF 646.3 SF 645.4 SF 807.9 SF 796.6 SF 846.4 SF 846.4 SF 830.8 SF 830.8 SF 830.8 SF 846.4 SF 846.4 SF 846.4 SF 846.4 SF 846.5 SF 12273.4 S 846.5 SF 540 SF 540 SF 540</td></td<></td></td></tr> <tr><td>A2 A2 A2 A2 A2 A2 A2 A2 A2 A3 A4 B B1 B2 B3 B4 A0 A1 A2 A2 A2 A1 A2 B B1 B2 B3 B2 B3 B4 A0 A1 A2 A2 A2 A2 A2 A2 A2</td><td>1 BR+DEN 1 BR+DEN 1 BR+DEN 1 BR+DEN 1 BR 1 BR 2 BR 1 BR+DEN 1 BR+DEN 1 BR+DEN 1 BR 2 BR 1 BR 1 BR 1 BR 1 BR 1 BR 1 BR+DEN 1 BR+DEN 1 BR+DEN <</td><td>645.4 SF 646.3 SF 646.2 SF 586.9 SF 645.8 SF 807.9 SF 796.6 SF 846.4 SF 830.8 SF 866.5 SF 12273.5 SF 540 SF 540 SF 540 SF 540 SF 646.2 SF 646.2 SF 646.3 SF 646.2 SF 646.2 SF 646.2 SF 646.3 SF 646.3 SF 646.3 SF 646.3 SF 646.4 SF 807.9 SF 796.6 SF 807.9 SF 645.8 SF 807.9 SF 645.8 SF 807.9 SF 796.6 SF 807.9 SF 796.6 SF 803.8 SF 866.5 SF 12273.4 SF 646.2 SF 640 SF 540 SF 540 SF 540 SF 540 SF 540 SF 540 SF 646.2 SF<td>1 <td< td=""><td>645.4 SF 646.3 SF 645.4 SF 646.2 SF 586.9 SF 645.8 SF 807.9 SF 796.6 SF 846.4 SF 830.8 SF 830.8 SF 846.4 SF 854 SF 830.8 SF 846.4 SF 846.4 SF 854 SF 846.4 SF 846.5 SF 12273.5 S 540 SF 540 SF 540 SF 646.2 SF 646.2 SF 646.2 SF 646.3 SF 646.3 SF 646.3 SF 645.4 SF 807.9 SF 645.8 SF 807.9 SF 645.8 SF 830.8 SF 846.4 SF 854 SF 830.8 SF 846.4 SF 846.5 SF 12273.4 S 540 SF 540 SF 540 SF 540 SF 540 SF</td></td<></td></td></tr> <tr><td>A2 A2 A2 A2 A2 A2 A2 A2 A2 A3 A4 B B1 B2 B3 B4 A0 A1 A2 A3 A4 B B1 B2 B3 B2 B3 A1 A2 A2 A2 A2 A2 A2 A2 A2</td><td>1 BR+DEN 1 BR+DEN 1 BR+DEN 1 BR+DEN 1 BR 1 BR 2 BR 1 BR+DEN 1 BR+DEN 1 BR+DEN 1 BR 1 BR 1 BR 1 BR 1 BR 2 BR 1 BR 1 BR 1 BR 1 BR 1 BR 1 BR+DEN 1 BR+DEN 1 BR+DEN <</td><td>645.4 SF 646.3 SF 646.2 SF 586.9 SF 645.8 SF 807.9 SF 796.6 SF 846.4 SF 830.8 SF 866.5 SF 12273.5 SF 540 SF 540 SF 540 SF 646.2 SF 646.2 SF 646.3 SF 646.2 SF 646.2 SF 646.2 SF 646.2 SF 646.3 SF 646.3 SF 646.3 SF 646.4 SF 807.9 SF 796.6 SF 846.4 SF 807.9 SF 796.6 SF 846.4 SF 807.9 SF 796.6 SF 846.4 SF 830.8 SF 866.5 SF 12273.4 SF 540 SF</td><td>1 <td< td=""><td>645.4 SF 646.3 SF 645.4 SF 646.2 SF 586.9 SF 645.8 SF 807.9 SF 796.6 SF 846.4 SF 830.8 SF 830.8 SF 846.4 SF 540 SF 540 SF 540 SF 645.2 SF 645.2 SF 646.2 SF 645.4 SF 645.3 SF 645.4 SF 807.9 SF 796.6 SF 846.4 SF 830.8 SF 830.8 SF 846.4 SF 846.5 SF 12273.4 S 540 SF 540 SF </td></td<></td></tr> <tr><td>A2 A2 A2 A2 A2 A2 A2 A2 A2 A3 A4 B B1 B2 B3 B4 A0 A1 A2 B B1 B2 B2 B3 B2 B2</td><td>1 BR+DEN 1 BR+DEN 1 BR+DEN 1 BR+DEN 1 BR 1 BR 2 BR 1 BR 1 BR 1 BR 1 BR 1 BR 1 BR+DEN 1 BR+DEN 1 BR+DEN 1 BR 1 BR 2 BR 1 BR+DEN 1 BR+DEN 1 BR+DEN 1 BR+DEN</td><td>645.4 SF 646.3 SF 645.4 SF 646.2 SF 586.9 SF 645.8 SF 807.9 SF 796.6 SF 846.4 SF 830.8 SF 866.5 SF 12273.5 SF 540 SF 540 SF 540 SF 540 SF 645.2 SF 646.2 SF 646.2 SF 646.2 SF 646.3 SF 646.2 SF 646.3 SF 645.4 SF 807.9 SF 796.6 SF 846.4 SF 846.3 SF 645.2 SF 645.3 SF 645.4 SF 807.9 SF 796.6 SF 846.4 SF 830.8 SF 866.5 SF 12273.4 SF 645.2 SF 640.5 SF 540 SF 540 SF 540 SF 540 SF 540 SF 540 SF 646.2 SF</td><td>1 <td< td=""><td>645.4 SF 646.3 SF 645.4 SF 646.2 SF 586.9 SF 645.8 SF 807.9 SF 796.6 SF 846.4 SF 830.8 SF 830.8 SF 846.4 SF 846.4 SF 830.8 SF 846.4 SF 846.4 SF 846.4 SF 846.4 SF 846.4 SF 846.4 SF 540 SF 540 SF 645.2 SF 646.2 SF 646.3 SF 646.2 SF 645.4 SF 846.4 SF 846.5 SF 12273.4 S
846.5 SF 540 SF 540 SF 540 SF 540 SF<</td></td<></td></tr> <tr><td>A2 A2 A2 A2 A2 A2 A2 A2 A2 A3 A4 B B1 B2 B3 B4 B2 B3 A1 A2 B1 B2 B3 B2 B3 B2 B3 A1 A2 A2 A2 A2 A2 A2 A2 A2 A2</td><td>1 BR+DEN 1 BR+DEN 1 BR+DEN 1 BR+DEN 1 BR 1 BR 2 BR 1 BR 1 BR 1 BR 1 BR 1 BR 1 BR+DEN 1 BR+DEN 1 BR+DEN 1 BR+DEN 1 BR 2 BR 1 BR+DEN 1 BR 1 BR 1 BR 1 BR 1 BR 1 BR+DEN 1 BR+DEN 1 BR+DEN 1 BR+DEN 1 BR+DEN</td><td>645.4 SF 646.3 SF 646.2 SF 586.9 SF 645.8 SF 807.9 SF 796.6 SF 846.4 SF 830.8 SF 866.5 SF 12273.5 SF 540 SF 540 SF 540 SF 540 SF 540 SF 645.2 SF 646.2 SF 646.2 SF 646.2 SF 646.3 SF 646.2 SF 645.4 SF 646.3 SF 645.4 SF 807.9 SF 645.4 SF 807.9 SF 645.8 SF 807.9 SF 645.8 SF 807.9 SF 796.6 SF 830.8 SF 830.8 SF 846.4 SF 854 SF 830.8 SF 645.2 SF 645.2 SF 646.2 SF 540 SF 540 SF 540 SF 540 SF 540 SF</td><td>1 <td< td=""><td>645.4 SF 646.3 SF 645.4 SF 646.2 SF 586.9 SF 645.8 SF 807.9 SF 796.6 SF 846.4 SF 830.8 SF 830.8 SF 846.4 SF 846.4 SF 846.4 SF 846.4 SF 846.5 SF 12273.5 S 540 SF 540 SF 540 SF 646.2 SF 646.2 SF 646.3 SF 646.2 SF 646.3 SF 646.2 SF 646.3 SF 645.4 SF 8807.9 SF 796.6 SF 846.4 SF 854 SF 830.8 SF 846.4 SF 846.4 SF 846.4 SF 846.4 SF 846.4 SF 846.5 SF 12273.4 S 540 SF 540 SF 540 SF 540 SF 540 SF 540 SF</td></td<></td></tr> <tr><td>A2 A2 A2 A2 A2 A2 A2 A2 A2 A3 A4 B B1 B2 B3 B4 A0 A1 A2 B B1 B2 B2 B3 B2 B2</td><td>1 BR+DEN 1 BR+DEN 1 BR+DEN 1 BR+DEN 1 BR 1 BR 2 BR 1 BR 1 BR 1 BR 1 BR 1 BR 1 BR+DEN 1 BR+DEN 1 BR+DEN 1 BR+DEN 1 BR 2 BR 1 BR+DEN 1 BR+DEN 1 BR+DEN 1 BR+DEN 1 BR+DEN</td><td>645.4 SF 646.3 SF 645.4 SF 646.2 SF 586.9 SF 645.8 SF 807.9 SF 796.6 SF 846.4 SF 830.8 SF 866.5 SF 12273.5 SF 540 SF 540 SF 540 SF 540 SF 645.2 SF 646.2 SF 646.2 SF 646.2 SF 646.3 SF 646.2 SF 646.3 SF 645.4 SF 807.9 SF 796.6 SF 846.4 SF 846.3 SF 645.2 SF 645.3 SF 645.4 SF 807.9 SF 796.6 SF 846.4 SF 830.8 SF 866.5 SF 12273.4 SF 645.2 SF 640.5 SF 540 SF 540 SF 540 SF 540 SF 540 SF 540 SF 646.2 SF</td><td>1 <td< td=""><td>645.4 SF 646.3 SF 645.4 SF 646.2 SF 586.9 SF 645.8 SF 807.9 SF 796.6 SF 846.4 SF 830.8 SF 830.8 SF 846.4 SF 846.4 SF 830.8 SF 846.4 SF 846.4 SF 846.4 SF 846.4 SF 846.4 SF 846.4 SF 540 SF 540 SF 645.2 SF 646.2 SF 646.3 SF 646.2 SF 645.4 SF 846.4 SF 846.5 SF 12273.4 S 846.5 SF 540 SF 540 SF 540 SF 540 SF<</td></td<></td></tr> <tr><td>A2 A2 A1 A0 A1 A2 A3 A4 B B1 B2 B3 A1 A2 A2 A2 A2 A2 A2 A2 A2 A2 A2</td><td>1 BR+DEN 1 BR+DEN 1 BR+DEN 1 BR+DEN 1 BR 1 BR 2 BR 1 BR+DEN 1 BR+DEN 1 BR+DEN 1 BR+DEN 1 BR 2 BR 1 BR</td><td>645.4 SF 646.3 SF 646.2 SF 586.9 SF 645.8 SF 807.9 SF 796.6 SF 846.4 SF 830.8 SF 866.5 SF 12273.5 SF 540 SF 540 SF 540 SF 540 SF 540 SF 646.2 SF 646.2 SF 646.2 SF 646.2 SF 646.2 SF 646.2 SF 646.3 SF 646.3 SF 646.4 SF 807.9 SF 646.3 SF 645.4 SF 807.9 SF 645.8 SF 807.9 SF 645.8 SF 807.9 SF 796.6 SF 830.8 SF 846.4 SF 854 SF 830.8 SF 846.5 SF 12273.4 SF 646.2 SF 540 SF 540 SF 540 SF 540 SF 540 SF</td><td>1 <td< td=""><td>645.4 SF 646.3 SF 645.4 SF 646.2 SF 586.9 SF 645.8 SF 807.9 SF 796.6 SF 846.4 SF 830.8 SF 830.8 SF 846.4 SF 854 SF 830.8 SF 866.5 SF 12273.5 S 540 SF 540 SF 540 SF 646.2 SF 646.2 SF 646.2 SF 646.3 SF 646.3 SF 645.4 SF 846.4 SF 846.5 SF 12273.4 S 540 SF 540 SF </td></td<></td></tr> <tr><td>A2 A2 A3 A4 B B1 B2 B3 B4 A0 A1 A2 B B1 B2 B3 A1 A2 A2</td><td>1 BR+DEN 1 BR+DEN 1 BR+DEN 1 BR+DEN 1 BR 1 BR 2 BR 1 BR+DEN 1 BR+DEN 1 BR+DEN 1 BR+DEN 1 BR 2 BR 1 BR</td><td>645.4 SF 646.3 SF 645.4 SF 645.8 SF 807.9 SF 796.6 SF 846.4 SF 830.8 SF 866.5 SF 12273.5 SF 540 SF 540 SF 540 SF 540 SF 540 SF 646.2 SF 646.2 SF 646.2 SF 646.2 SF 646.2 SF 646.3 SF 646.2 SF 646.3 SF 646.3 SF 646.4 SF 807.9 SF 796.6 SF 846.4 SF 807.9 SF 796.6 SF 846.4 SF 807.9 SF 796.6 SF 846.4 SF 830.8 SF 866.5 SF 12273.4 SF 646.2 SF 646.2 SF 646.2 SF 646.2 SF 646.2 SF 646.3 SF 646.2 SF 646.2 SF 646.</td><td>1 1
 1 <td< td=""><td>645.4 SF 646.3 SF 645.4 SF 646.2 SF 645.8 SF 807.9 SF 796.6 SF 846.4 SF 830.8 SF 830.8 SF 846.4 SF 846.4 SF 830.8 SF 846.4 SF 846.4 SF 846.4 SF 846.4 SF 846.4 SF 846.5 SF 12273.5 S 540 SF 540 SF 540 SF 645.2 SF 646.2 SF 645.2 SF 645.3 SF 645.4 SF 807.9 SF 796.6 SF 846.4 SF 830.8 SF 830.8 SF 846.4 SF 830.8 SF 846.5 SF 12273.4 S 540 SF 540 SF <!--</td--></td></td<></td></tr> | 645.4 SF
646.3 SF
645.4 SF
646.2 SF
586.9 SF
645.8 SF
807.9 SF
796.6 SF
846.4 SF
830.8 SF
866.5 SF
12273.5 S
540 SF
540 SF
540 SF
540 SF
646.2 SF
646.2 SF
646.2 SF
645.2 SF
645.3 SF
645.4 SF
807.9 SF
796.6 SF
846.4 SF
854 SF
830.8 SF | A2
A2
A2
A2
A2
A2
A2
A2
A2
A3
A3
A4
B
B
B
B
B
B
C
B
C
C
C | 1 BR+DEN 1 BR+DEN 1 BR+DEN 1 BR+DEN 1 BR 1 BR 2 BR 1 BR 1 BR 1 BR 1 BR 1 BR+DEN 1 BR+DEN 1 BR+DEN 1 BR+DEN 1 BR+DEN 1 BR 2 BR | 645.4 SF 646.3 SF 646.4 SF 646.2 SF 586.9 SF 645.8 SF 807.9 SF 796.6 SF 846.4 SF 854 SF 830.8 SF 866.5 SF 12273.5 SF 540 SF 540 SF 540 SF 540 SF 646.2 SF 646.2 SF 646.2 SF 646.2 SF 646.3 SF 645.4 SF 807.9 SF 796.6 SF 846.4 SF 846.3 SF 645.2 SF 645.2 SF 645.3 SF 807.9 SF 796.6 SF 807.9 SF 796.6 SF 846.4 SF 830.8 SF 830.8 SF 866.5 SF 12273.4 SF | 1 1 <td< td=""><td>645.4 SF
646.3 SF
645.4 SF
646.2 SF
586.9 SF
645.8 SF
807.9 SF
796.6 SF
846.4 SF
830.8 SF
866.5 SF
12273.5 S
540 SF
540 SF
540 SF
540 SF
646.2 SF
646.2 SF
646.2 SF
645.2 SF
645.2 SF
645.3 SF
645.3 SF
645.4 SF
807.9 SF
796.6 SF
846.4 SF
830.8 SF
830.8 SF
830.8 SF
830.8 SF
866.5 SF</td></td<> | 645.4 SF
646.3 SF
645.4 SF
646.2 SF
586.9 SF
645.8 SF
807.9 SF
796.6 SF
846.4 SF
830.8 SF
866.5 SF
12273.5 S
540 SF
540 SF
540 SF
540 SF
646.2 SF
646.2 SF
646.2 SF
645.2 SF
645.2 SF
645.3 SF
645.3 SF
645.4 SF
807.9 SF
796.6 SF
846.4 SF
830.8 SF
830.8 SF
830.8 SF
830.8 SF
866.5 SF | A2
A2
A2
A2
A2
A2
A2
A2
A2
A3
A4
B
B1
B2
B3
A0
B3
A0
A1
A0
A1
A1
A0
A1
A1
A0
A1
A1
A0
A1
A1
A0
A1
A1
A1 | 1 BR+DEN 1 BR+DEN 1 BR+DEN 1 BR+DEN 1 BR 1 BR 2 BR 1 BR 1 BR 1 BR 1 BR 1 BR 1 BR+DEN 1 BR+DEN 1 BR+DEN 1 BR+DEN 1 BR+DEN 1 BR 2 BR | 645.4 SF 646.3 SF 646.2 SF 586.9 SF 645.8 SF 807.9 SF 796.6 SF 846.4 SF 830.8 SF 866.5 SF 12273.5 SF 540 SF 543 SF 646.2 SF 646.2 SF 645.2 SF 645.2 SF 645.2 SF 645.3 SF 645.4 SF 807.9 SF 796.6 SF 807.9 SF 796.6 SF 846.4 SF 830.8 SF 807.9 SF 796.6 SF 846.4 SF 854 SF 830.8 SF 866.5 SF 12273.4 SF | 1 1 <td< td=""><td>645.4 SF 646.3 SF 645.4 SF 646.2 SF 586.9 SF 645.8 SF 807.9 SF 796.6 SF 846.4 SF 830.8 SF 866.5 SF 12273.5 S 540 SF 540 SF 540 SF 646.2 SF 646.2 SF 646.2 SF 646.2 SF 646.2 SF 646.2 SF 646.3 SF 645.4 SF 646.3 SF 645.4 SF 645.5 SF 796.6 SF 807.9 SF 796.6 SF 807.9 SF 796.6 SF 830.8 SF 830.8 SF 846.4 SF 854 SF 830.8 SF 866.5 SF 12273.4 S</td></td<> | 645.4 SF 646.3 SF 645.4 SF 646.2 SF 586.9 SF 645.8 SF 807.9 SF 796.6 SF 846.4 SF 830.8 SF 866.5 SF 12273.5 S 540 SF 540 SF 540 SF 646.2 SF 646.2 SF 646.2 SF 646.2 SF 646.2 SF 646.2 SF 646.3 SF 645.4 SF 646.3 SF 645.4 SF 645.5 SF 796.6 SF 807.9 SF 796.6 SF 807.9 SF 796.6 SF 830.8 SF 830.8 SF 846.4 SF 854 SF 830.8 SF 866.5 SF 12273.4 S | A2
A2
A2
A2
A2
A2
A2
A2
A2
A3
A4
B
B
B
B
B
B
C
B
C
C
C | 1 BR+DEN 1 BR+DEN 1 BR+DEN 1 BR+DEN 1 BR 1 BR 2 BR 1 BR+DEN 1 BR+DEN 1 BR+DEN 1 BR+DEN 1 BR 2 BR | 645.4 SF 646.3 SF 646.4 SF 646.2 SF 586.9 SF 645.8 SF 807.9 SF 796.6 SF 846.4 SF 854 SF 830.8 SF 866.5 SF 12273.5 SF 540 SF 540 SF 540 SF 540 SF 646.2 SF 646.2 SF 646.2 SF 646.2 SF 646.3 SF 645.4 SF 807.9 SF 796.6 SF 846.4 SF 846.3 SF 645.2 SF 645.2 SF 645.3 SF 807.9 SF 796.6 SF 807.9 SF 796.6 SF 846.4 SF 830.8 SF 830.8 SF 866.5 SF 12273.4 SF | 1 1
 1 1 <td< td=""><td>645.4 SF
646.3 SF
645.4 SF
646.2 SF
586.9 SF
645.8 SF
807.9 SF
796.6 SF
846.4 SF
830.8 SF
866.5 SF
12273.5 S
540 SF
540 SF
540 SF
540 SF
646.2 SF
646.2 SF
646.2 SF
645.2 SF
645.2 SF
645.3 SF
645.3 SF
645.4 SF
807.9 SF
796.6 SF
846.4 SF
830.8 SF
830.8 SF
830.8 SF
830.8 SF
866.5 SF</td></td<> | 645.4 SF
646.3 SF
645.4 SF
646.2 SF
586.9 SF
645.8 SF
807.9 SF
796.6 SF
846.4 SF
830.8 SF
866.5 SF
12273.5 S
540 SF
540 SF
540 SF
540 SF
646.2 SF
646.2 SF
646.2 SF
645.2 SF
645.2 SF
645.3 SF
645.3 SF
645.4 SF
807.9 SF
796.6 SF
846.4 SF
830.8 SF
830.8 SF
830.8 SF
830.8 SF
866.5 SF | A2
A2
A2
A3
A4
B
B
B
B
B
B
B
C
B
C
C
C | 1 BR+DEN 1 BR+DEN 1 BR+DEN 1 BR+DEN 1 BR 1 BR 2 BR 1 BR 1 BR 1 BR 1 BR 1 BR 1 BR+DEN 1 BR+DEN 1 BR+DEN 1 BR+DEN 1 BR 2 BR 1 BR | 645.4 SF 646.3 SF 646.2 SF 586.9 SF 645.8 SF 807.9 SF 796.6 SF 846.4 SF 854 SF 830.8 SF 866.5 SF 12273.5 SF 540 SF 540 SF 540 SF 540 SF 645.2 SF 646.2 SF 646.2 SF 646.2 SF 646.2 SF 646.3 SF 645.4 SF 807.9 SF 646.3 SF 645.4 SF 807.9 SF 796.6 SF 846.4 SF 807.9 SF 796.6 SF 846.4 SF 807.9 SF 796.6 SF 846.4 SF 830.8 SF 803.8 SF 866.5 SF 12273.4 SF 540 SF | 1 1 <td< td=""><td>645.4 SF 646.3 SF 645.4 SF 646.2 SF 586.9 SF 645.8 SF 807.9 SF 796.6 SF 846.4 SF 830.8 SF 830.8 SF 846.4 SF 854 SF 830.8 SF 646.2 SF 540 SF 540 SF 540 SF 646.2 SF 646.2 SF 646.3 SF 645.4 SF 646.3 SF 645.4 SF 646.3 SF 645.4 SF 846.4 SF 846.4 SF 846.4 SF 830.8 SF 846.4 SF 830.8 SF 846.4 SF 830.8 SF 830.8 SF 846.4 SF 830.8 SF 846.5 SF 12273.4 S 540 SF 540 SF 540 SF 540 SF 540 SF 540 SF 540 SF <</td></td<> | 645.4 SF 646.3 SF 645.4 SF 646.2 SF 586.9 SF 645.8 SF 807.9 SF 796.6 SF 846.4 SF 830.8 SF 830.8 SF 846.4 SF 854 SF 830.8 SF 646.2 SF 540 SF 540 SF 540 SF 646.2 SF 646.2 SF 646.3 SF 645.4 SF 646.3 SF 645.4 SF 646.3 SF 645.4 SF 846.4 SF 846.4 SF 846.4 SF 830.8 SF 846.4 SF 830.8 SF 846.4 SF 830.8 SF 830.8 SF 846.4 SF 830.8 SF 846.5 SF 12273.4 S 540 SF 540 SF 540 SF 540 SF 540 SF 540 SF 540 SF < | A2
A2
A2
A3
A4
B
B1
B2
B3
A0
B1
B2
B3
A0
A1
A0
A1
A0
A1
A0
A1
A0
A2
A2
A2 | 1 BR+DEN 1 BR+DEN 1 BR+DEN 1 BR+DEN 1 BR 1 BR 2 BR 1 BR 1 BR 1 BR 1 BR 1 BR 1 BR+DEN 1 BR+DEN 1 BR+DEN 1 BR+DEN 1 BR 2 BR 1 BR | 645.4 SF 646.3 SF 646.2 SF 586.9 SF 645.8 SF 807.9 SF 796.6 SF 846.4 SF 830.8 SF 866.5 SF 12273.5 SF 540 SF 543 SF 646.2 SF 645.2 SF 645.2 SF 645.3 SF 645.4 SF 807.9 SF 796.6 SF 846.4 SF 807.9 SF 796.6 SF 846.4 SF 830.8 SF 807.9 SF 796.6 SF 846.4 SF 830.8 SF 830.8 SF 830.8 SF 840.4 SF 840.4 SF 854 SF 830.8 SF 846.5 SF 12273.4 SF 540 SF 540 SF 540 SF | 1 1 <td< td=""><td>645.4 SF 646.3 SF 645.4 SF 646.2 SF 586.9 SF 645.8 SF 807.9 SF 796.6 SF 846.4 SF 830.8 SF 866.5 SF 12273.5 540 SF 540 SF 540 SF 540 SF 645.2 SF 646.2 SF 646.2 SF 646.2 SF 646.3 SF 646.3 SF 645.4 SF 645.3 SF 645.4 SF 645.5 SF 796.6 SF 807.9 SF 796.6 SF 830.8 SF 846.4 SF 854 SF 830.8 SF 846.4 SF 854 SF 830.8 SF 846.4 SF 854 SF 830.8 SF 846.5 SF 12273.4 S 540 SF 540 SF 540 SF 540 SF 540 SF </td></td<> | 645.4 SF 646.3 SF 645.4 SF 646.2 SF 586.9 SF 645.8 SF 807.9 SF 796.6 SF 846.4 SF 830.8 SF 866.5 SF 12273.5 540 SF 540 SF 540 SF 540 SF 645.2 SF 646.2 SF 646.2 SF 646.2 SF 646.3 SF 646.3 SF 645.4 SF 645.3 SF 645.4 SF 645.5 SF 796.6 SF 807.9 SF 796.6 SF 830.8 SF 846.4 SF 854 SF 830.8 SF 846.4 SF 854 SF 830.8 SF 846.4 SF 854 SF 830.8 SF 846.5 SF 12273.4 S 540 SF 540 SF 540 SF 540 SF 540 SF | A2
A2
A2
A3
A4
B
B
B
B
B
C
B
C
C
C | 1 BR+DEN 1 BR+DEN 1 BR+DEN 1 BR+DEN 1 BR 1 BR 2 BR 1 BR+DEN 1 BR+DEN 1 BR+DEN 1 BR 1 BR 2 BR 1 BR <t< td=""><td>645.4 SF 646.3 SF 646.2 SF 586.9 SF 645.8 SF 807.9 SF 796.6 SF 846.4 SF 830.8 SF 866.5 SF 12273.5 SF 540 SF 646.2 SF 646.2 SF 646.2 SF 646.3 SF 645.4 SF 646.3 SF 645.4 SF 645.4 SF 645.3 SF 645.4 SF 807.9 SF 796.6 SF 807.9 SF 796.6 SF 807.9 SF 796.6 SF 807.9 SF 796.6 SF 830.8 SF 830.8 SF 830.8 SF 846.4 SF 854 SF 830.8 SF 540 SF 540 SF 540 SF 540 SF 540 SF 540 SF <!--</td--><td>1 <td< td=""><td>645.4 SF 646.3 SF 645.4 SF 646.2 SF 586.9 SF 645.8 SF 807.9 SF 796.6 SF 846.4 SF 830.8 SF 830.8 SF 846.4 SF 846.4 SF 846.4 SF 846.4 SF 846.5 SF 12273.5 S 540 SF 540 SF 540 SF 646.2 SF 646.2 SF 646.3 SF 646.2 SF
 646.3 SF 645.4 SF 846.4 SF 846.4 SF 846.4 SF 846.4 SF 830.8 SF 846.4 SF 854 SF 830.8 SF 846.4 SF 854 SF 830.8 SF 846.4 SF 854 SF 830.8 SF 540 SF 540 SF 540 SF 540 SF 540 SF 540 SF </td></td<></td></td></t<> | 645.4 SF 646.3 SF 646.2 SF 586.9 SF 645.8 SF 807.9 SF 796.6 SF 846.4 SF 830.8 SF 866.5 SF 12273.5 SF 540 SF 646.2 SF 646.2 SF 646.2 SF 646.3 SF 645.4 SF 646.3 SF 645.4 SF 645.4 SF 645.3 SF 645.4 SF 807.9 SF 796.6 SF 807.9 SF 796.6 SF 807.9 SF 796.6 SF 807.9 SF 796.6 SF 830.8 SF 830.8 SF 830.8 SF 846.4 SF 854 SF 830.8 SF 540 SF 540 SF 540 SF 540 SF 540 SF 540 SF </td <td>1 <td< td=""><td>645.4 SF 646.3 SF 645.4 SF 646.2 SF 586.9 SF 645.8 SF 807.9 SF 796.6 SF 846.4 SF 830.8 SF 830.8 SF 846.4 SF 846.4 SF 846.4 SF 846.4 SF 846.5 SF 12273.5 S 540 SF 540 SF 540 SF 646.2 SF 646.2 SF 646.3 SF 646.2 SF 646.3 SF 645.4 SF 846.4 SF 846.4 SF 846.4 SF 846.4 SF 830.8 SF 846.4 SF 854 SF 830.8 SF 846.4 SF 854 SF 830.8 SF 846.4 SF 854 SF 830.8 SF 540 SF 540 SF 540 SF 540 SF 540 SF 540 SF </td></td<></td> | 1 1 <td< td=""><td>645.4 SF 646.3 SF 645.4 SF 646.2 SF 586.9 SF 645.8 SF 807.9 SF 796.6 SF 846.4 SF 830.8 SF 830.8 SF 846.4 SF 846.4 SF 846.4 SF 846.4 SF 846.5 SF 12273.5 S 540 SF 540 SF 540 SF 646.2 SF 646.2 SF 646.3 SF 646.2 SF 646.3 SF 645.4 SF 846.4 SF 846.4 SF 846.4 SF 846.4 SF 830.8 SF 846.4 SF 854 SF 830.8 SF 846.4 SF 854 SF 830.8 SF 846.4 SF 854 SF 830.8 SF 540 SF 540 SF 540 SF 540 SF 540 SF 540 SF </td></td<> | 645.4 SF 646.3 SF 645.4 SF 646.2 SF 586.9 SF 645.8 SF 807.9 SF 796.6 SF 846.4 SF 830.8 SF 830.8 SF 846.4 SF 846.4 SF 846.4 SF 846.4 SF 846.5 SF 12273.5 S 540 SF 540 SF 540 SF 646.2 SF 646.2 SF 646.3 SF 646.2 SF 646.3 SF 645.4 SF 846.4 SF 846.4 SF 846.4 SF 846.4 SF 830.8 SF 846.4 SF 854 SF 830.8 SF 846.4 SF 854 SF 830.8 SF 846.4 SF 854 SF 830.8 SF 540 SF 540 SF 540 SF 540 SF 540 SF 540 SF | A2 A2 A2 A2 A2 A2 A2 A2 A2 A3 A4 B B1 B2 B3 A0 A1 A1 A2 A2 A2 A2 A1 A2 A3 A4 B B1 B2 B3 B4 A0 LEVEL A A1 A0 A1 A1 A2 <tr td=""> <tr td=""></tr></tr> | 1 BR+DEN 1 BR+DEN 1 BR+DEN 1 BR+DEN 1 BR 1 BR 2 BR 1 BR+DEN 1 BR+DEN 1 BR 1 BR 1 BR 2 BR 1 BR 1 BR 1 | 645.4 SF 646.3 SF 646.2 SF 586.9 SF 645.8 SF 807.9 SF 796.6 SF 846.4 SF 830.8 SF 866.5 SF 12273.5 SF 540 SF 540 SF 540 SF 540 SF 646.2 SF 646.2 SF 646.3 SF 646.2 SF 646.2 SF 646.2 SF 646.2 SF 646.3 SF 646.3 SF 646.3 SF 646.3 SF 646.3 SF 646.3 SF 645.4 SF 807.9 SF 645.8 SF 807.9 SF 645.8 SF 807.9 SF 645.8 SF 807.9 SF 796.6 SF 830.8 SF 866.5 SF 12273.4 SF 540 SF | 1 1 <td< td=""><td>645.4 SF 646.3 SF 645.4 SF 646.2 SF 586.9 SF 645.8 SF 807.9 SF 796.6 SF 846.4 SF 830.8 SF 866.5 SF 12273.5 540 SF 540 SF 540 SF 540 SF 646.2 SF 646.2 SF 646.2 SF 646.2 SF 646.3 SF 646.3 SF 646.3 SF 646.3 SF 645.4 SF 846.4 SF 846.4 SF 846.5 SF 12273.4 S 540 SF 540 SF 645.2 SF 645.3 SF 807.9 SF 796.6 SF 846.4 SF 854 SF 830.8 SF 846.4 SF 846.5 SF 12273.4 S 540 SF 540 SF 540 SF 540 SF 540 SF </td></td<> | 645.4 SF 646.3 SF 645.4 SF 646.2 SF 586.9 SF 645.8 SF 807.9 SF 796.6 SF 846.4 SF 830.8 SF 866.5 SF 12273.5 540 SF 540 SF 540 SF 540 SF 646.2 SF 646.2 SF 646.2 SF 646.2 SF 646.3 SF 646.3 SF 646.3 SF 646.3 SF 645.4 SF 846.4 SF 846.4 SF 846.5 SF 12273.4 S 540 SF 540 SF 645.2 SF 645.3 SF 807.9 SF 796.6 SF 846.4 SF 854 SF 830.8 SF 846.4 SF 846.5 SF 12273.4 S 540 SF 540 SF 540 SF 540 SF 540 SF | A2
A2
A2
A3
A4
B
B
B
B
B
C
B
C
C
C | 1 BR+DEN 1 BR+DEN 1 BR+DEN 1 BR+DEN 1 BR 1 BR 2 BR 1 BR+DEN 1 BR+DEN 1 BR+DEN 1 BR 1 BR 2 BR 1 BR <t< td=""><td>645.4 SF 646.3 SF 646.2 SF 586.9 SF 645.8 SF 807.9 SF 796.6 SF 846.4 SF 830.8 SF 866.5 SF 12273.5 SF 540 SF 646.2 SF 646.2 SF 646.2 SF 646.3 SF 645.4 SF 646.3 SF 645.4 SF 645.4 SF 645.3 SF 645.4 SF 807.9 SF 796.6 SF 807.9 SF 796.6 SF 807.9 SF 796.6 SF 807.9 SF 796.6 SF 830.8 SF 830.8 SF 830.8 SF 846.4 SF 854 SF 830.8 SF 540 SF 540 SF 540 SF 540 SF 540 SF 540 SF <!--</td--><td>1 1
 1 1 1 1 1 1 1 1 1 1 1 1 <td< td=""><td>645.4 SF 646.3 SF 645.4 SF 646.2 SF 586.9 SF 645.8 SF 807.9 SF 796.6 SF 846.4 SF 830.8 SF 830.8 SF 846.4 SF 854 SF 830.8 SF 646.2 SF 540 SF 540 SF 540 SF 646.2 SF 646.2 SF 646.3 SF 645.4 SF 646.3 SF 646.3 SF 645.4 SF 846.4 SF 846.4 SF 846.5 SF 807.9 SF 645.8 SF 807.9 SF 645.8 SF 830.8 SF 830.8 SF 846.4 SF 830.8 SF 846.5 SF 12273.4 S 540 SF 540 SF </td></td<></td></td></t<> | 645.4 SF 646.3 SF 646.2 SF 586.9 SF 645.8 SF 807.9 SF 796.6 SF 846.4 SF 830.8 SF 866.5 SF 12273.5 SF 540 SF 646.2 SF 646.2 SF 646.2 SF 646.3 SF 645.4 SF 646.3 SF 645.4 SF 645.4 SF 645.3 SF 645.4 SF 807.9 SF 796.6 SF 807.9 SF 796.6 SF 807.9 SF 796.6 SF 807.9 SF 796.6 SF 830.8 SF 830.8 SF 830.8 SF 846.4 SF 854 SF 830.8 SF 540 SF 540 SF 540 SF 540 SF 540 SF 540 SF </td <td>1 <td< td=""><td>645.4 SF 646.3 SF 645.4 SF 646.2 SF 586.9 SF 645.8 SF 807.9 SF 796.6 SF 846.4 SF 830.8 SF 830.8 SF 846.4 SF 854 SF 830.8 SF 646.2 SF 540 SF 540 SF 540 SF 646.2 SF 646.2 SF 646.3 SF 645.4 SF 646.3 SF 646.3 SF 645.4 SF 846.4 SF 846.4 SF 846.5 SF 807.9 SF 645.8 SF 807.9 SF 645.8 SF 830.8 SF 830.8 SF 846.4 SF 830.8 SF 846.5 SF 12273.4 S 540 SF 540 SF </td></td<></td> | 1 1 <td< td=""><td>645.4 SF 646.3 SF 645.4 SF 646.2 SF 586.9 SF 645.8 SF 807.9 SF 796.6 SF 846.4 SF 830.8 SF 830.8 SF 846.4 SF 854 SF 830.8 SF 646.2 SF 540 SF 540 SF 540 SF 646.2 SF 646.2 SF 646.3 SF 645.4 SF 646.3 SF 646.3 SF 645.4 SF 846.4 SF 846.4 SF 846.5 SF 807.9 SF 645.8 SF 807.9 SF 645.8 SF 830.8 SF 830.8 SF 846.4 SF 830.8 SF 846.5 SF 12273.4 S 540 SF 540 SF </td></td<> | 645.4 SF 646.3 SF 645.4 SF 646.2 SF 586.9 SF 645.8 SF 807.9 SF 796.6 SF 846.4 SF 830.8 SF 830.8 SF 846.4 SF 854 SF 830.8 SF 646.2 SF 540 SF 540 SF 540 SF 646.2 SF 646.2 SF 646.3 SF 645.4 SF 646.3 SF 646.3 SF 645.4 SF 846.4 SF 846.4 SF 846.5 SF 807.9 SF 645.8 SF 807.9 SF 645.8 SF 830.8 SF 830.8 SF 846.4 SF 830.8 SF 846.5 SF 12273.4 S 540 SF 540 SF | A2
A2
A2
A3
A4
B
B
B
B
B
B
B
C
C
C | 1 BR+DEN 1 BR+DEN 1 BR+DEN 1 BR+DEN 1 BR 1 BR 2 BR 1 BR+DEN 1 BR+DEN 1 BR+DEN 1 BR+DEN 1 BR 2 BR 1 BR+DEN 1 BR+DEN < | 645.4 SF 646.3 SF 646.2 SF 586.9 SF 645.8 SF 807.9 SF 796.6 SF 846.4 SF 854 SF 830.8 SF 866.5 SF 12273.5 SF 540 SF 540 SF 540 SF 646.2 SF 646.2 SF 646.2 SF 646.2 SF 646.2 SF 646.2 SF 646.3 SF 646.3 SF 646.3 SF 646.3 SF 646.3 SF 646.5 SF 12273.4 SF 540 SF 540 SF 540 SF 540 SF 645.2 SF 646.2 SF 646.3 SF 807.9 SF 796.6 SF 830.8 SF 830.8 SF 830.8 SF 846.4 SF 830.8 SF 846.5 SF 12273.4 SF 540 SF 540 SF 540 SF 540 SF <td>1 <td< td=""><td>645.4 SF 646.3 SF 645.4 SF 646.2 SF 586.9 SF 645.8 SF 807.9 SF 796.6 SF 846.4 SF 830.8 SF 830.8 SF 846.4 SF 846.5 SF 12273.5 S 540 SF 540 SF 645.2 SF 646.2 SF 646.2 SF 646.3 SF 645.4 SF 807.9 SF 796.6 SF 846.4 SF 846.4 SF 830.8 SF 830.8 SF 830.8 SF 846.4 SF 846.4 SF 846.4 SF 846.4 SF 846.5 SF 12273.4 S 846.5 SF 540 SF 540 SF 540</td></td<></td> | 1 1 <td< td=""><td>645.4 SF 646.3 SF 645.4 SF 646.2 SF 586.9 SF 645.8 SF 807.9 SF 796.6 SF 846.4 SF 830.8 SF 830.8 SF 846.4 SF 846.5 SF 12273.5 S 540 SF 540 SF 645.2 SF 646.2 SF 646.2 SF 646.3 SF 645.4 SF 807.9 SF 796.6 SF 846.4 SF 846.4 SF 830.8 SF 830.8 SF 830.8 SF 846.4 SF 846.4 SF 846.4 SF 846.4 SF 846.5 SF 12273.4 S 846.5 SF 540 SF 540 SF 540</td></td<> | 645.4 SF 646.3 SF 645.4 SF 646.2 SF 586.9 SF 645.8 SF 807.9 SF 796.6 SF 846.4 SF 830.8 SF 830.8 SF 846.4 SF 846.5 SF 12273.5 S 540 SF 540 SF 645.2 SF 646.2 SF 646.2 SF 646.3 SF 645.4 SF 807.9 SF 796.6 SF 846.4 SF 846.4 SF 830.8 SF 830.8 SF 830.8 SF 846.4 SF 846.4 SF 846.4 SF 846.4 SF 846.5 SF 12273.4 S 846.5 SF 540 SF 540 SF 540 | A2 A2 A2 A2 A2 A2 A2 A2 A2 A3 A4 B B1 B2 B3 B4 A0 A1 A2 A2 A2 A1 A2 B B1 B2 B3 B2 B3 B4 A0 A1 A2 A2 A2 A2 A2 A2 A2 | 1 BR+DEN 1 BR+DEN 1 BR+DEN 1 BR+DEN 1 BR 1 BR
 2 BR 1 BR+DEN 1 BR+DEN 1 BR+DEN 1 BR 2 BR 1 BR 1 BR 1 BR 1 BR 1 BR 1 BR+DEN 1 BR+DEN 1 BR+DEN < | 645.4 SF 646.3 SF 646.2 SF 586.9 SF 645.8 SF 807.9 SF 796.6 SF 846.4 SF 830.8 SF 866.5 SF 12273.5 SF 540 SF 540 SF 540 SF 540 SF 646.2 SF 646.2 SF 646.3 SF 646.2 SF 646.2 SF 646.2 SF 646.3 SF 646.3 SF 646.3 SF 646.3 SF 646.4 SF 807.9 SF 796.6 SF 807.9 SF 645.8 SF 807.9 SF 645.8 SF 807.9 SF 796.6 SF 807.9 SF 796.6 SF 803.8 SF 866.5 SF 12273.4 SF 646.2 SF 640 SF 540 SF 540 SF 540 SF 540 SF 540 SF 540 SF 646.2 SF <td>1 <td< td=""><td>645.4 SF 646.3 SF 645.4 SF 646.2 SF 586.9 SF 645.8 SF 807.9 SF 796.6 SF 846.4 SF 830.8 SF 830.8 SF 846.4 SF 854 SF 830.8 SF 846.4 SF 846.4 SF 854 SF 846.4 SF 846.5 SF 12273.5 S 540 SF 540 SF 540 SF 646.2 SF 646.2 SF 646.2 SF 646.3 SF 646.3 SF 646.3 SF 645.4 SF 807.9 SF 645.8 SF 807.9 SF 645.8 SF 830.8 SF 846.4 SF 854 SF 830.8 SF 846.4 SF 846.5 SF 12273.4 S 540 SF 540 SF 540 SF 540 SF 540 SF</td></td<></td> | 1 1 <td< td=""><td>645.4 SF 646.3 SF 645.4 SF 646.2 SF 586.9 SF 645.8 SF 807.9 SF 796.6 SF 846.4 SF 830.8 SF 830.8 SF 846.4 SF 854 SF 830.8 SF 846.4 SF 846.4 SF 854 SF 846.4 SF 846.5 SF 12273.5 S 540 SF 540 SF 540 SF 646.2 SF 646.2 SF 646.2 SF 646.3 SF 646.3 SF 646.3 SF 645.4 SF 807.9 SF 645.8 SF 807.9 SF 645.8 SF 830.8 SF 846.4 SF 854 SF 830.8 SF 846.4 SF 846.5 SF 12273.4 S 540 SF 540 SF 540 SF 540 SF 540 SF</td></td<> | 645.4 SF 646.3 SF 645.4 SF 646.2 SF 586.9 SF 645.8 SF 807.9 SF 796.6 SF 846.4 SF 830.8 SF 830.8 SF 846.4 SF 854 SF 830.8 SF 846.4 SF 846.4 SF 854 SF 846.4 SF 846.5 SF 12273.5 S 540 SF 540 SF 540 SF 646.2 SF 646.2 SF 646.2 SF 646.3 SF 646.3 SF 646.3 SF 645.4 SF 807.9 SF 645.8 SF 807.9 SF 645.8 SF 830.8 SF 846.4 SF 854 SF 830.8 SF 846.4 SF 846.5 SF 12273.4 S 540 SF 540 SF 540 SF 540 SF 540 SF | A2 A2 A2 A2 A2 A2 A2 A2 A2 A3 A4 B B1 B2 B3 B4 A0 A1 A2 A3 A4 B B1 B2 B3 B2 B3 A1 A2 A2 A2 A2 A2 A2 A2 A2 | 1 BR+DEN 1 BR+DEN 1 BR+DEN 1 BR+DEN 1 BR 1 BR 2 BR 1 BR+DEN 1 BR+DEN 1 BR+DEN 1 BR 1 BR 1 BR 1 BR 1 BR 2 BR 1 BR 1 BR 1 BR 1 BR 1 BR 1 BR+DEN 1 BR+DEN 1 BR+DEN < | 645.4 SF 646.3 SF 646.2 SF 586.9 SF 645.8 SF 807.9 SF 796.6 SF 846.4 SF 830.8 SF 866.5 SF 12273.5 SF 540 SF 540 SF 540 SF 646.2 SF 646.2 SF 646.3 SF 646.2 SF 646.2 SF 646.2 SF 646.2 SF 646.3 SF 646.3 SF 646.3 SF 646.4 SF 807.9 SF 796.6 SF 846.4 SF 807.9 SF 796.6 SF 846.4 SF 807.9 SF 796.6 SF 846.4 SF 830.8 SF 866.5 SF 12273.4 SF 540 SF | 1 1 <td< td=""><td>645.4 SF 646.3 SF 645.4 SF 646.2 SF 586.9 SF 645.8 SF 807.9 SF 796.6 SF 846.4 SF 830.8 SF 830.8 SF 846.4 SF 540 SF 540 SF 540 SF 645.2 SF 645.2 SF 646.2 SF 645.4 SF 645.3 SF 645.4 SF 807.9 SF 796.6 SF 846.4 SF 830.8 SF 830.8 SF 846.4 SF 846.5 SF 12273.4 S 540 SF 540 SF </td></td<> | 645.4 SF 646.3 SF 645.4 SF 646.2 SF 586.9 SF 645.8 SF 807.9 SF 796.6 SF 846.4 SF 830.8 SF 830.8 SF 846.4 SF 540 SF 540 SF 540 SF 645.2 SF 645.2 SF 646.2 SF 645.4 SF 645.3 SF 645.4 SF 807.9 SF 796.6 SF 846.4 SF 830.8 SF 830.8 SF 846.4 SF 846.5 SF 12273.4 S 540 SF 540 SF | A2 A2 A2 A2 A2 A2 A2 A2 A2 A3 A4 B B1 B2 B3 B4 A0 A1 A2 B B1 B2 B2 B3 B2 B2 | 1 BR+DEN 1 BR+DEN 1 BR+DEN 1 BR+DEN 1 BR 1 BR 2 BR 1 BR 1 BR 1 BR 1 BR 1 BR 1 BR+DEN 1 BR+DEN 1 BR+DEN 1 BR 1 BR 2 BR 1 BR+DEN 1 BR+DEN 1 BR+DEN 1 BR+DEN | 645.4 SF 646.3 SF 645.4 SF 646.2 SF 586.9 SF 645.8 SF 807.9 SF 796.6 SF 846.4 SF 830.8 SF 866.5 SF 12273.5 SF 540 SF 540 SF 540 SF 540 SF 645.2 SF 646.2 SF 646.2 SF 646.2 SF 646.3 SF 646.2 SF 646.3 SF 645.4 SF 807.9 SF 796.6 SF 846.4 SF 846.3 SF 645.2 SF 645.3 SF 645.4 SF 807.9 SF 796.6 SF 846.4 SF 830.8 SF 866.5 SF 12273.4 SF 645.2 SF 640.5 SF 540 SF 540 SF 540 SF 540 SF 540 SF 540 SF 646.2 SF | 1 1 <td< td=""><td>645.4 SF 646.3 SF 645.4 SF 646.2 SF 586.9 SF 645.8 SF 807.9 SF 796.6 SF 846.4 SF
 830.8 SF 830.8 SF 846.4 SF 846.4 SF 830.8 SF 846.4 SF 846.4 SF 846.4 SF 846.4 SF 846.4 SF 846.4 SF 540 SF 540 SF 645.2 SF 646.2 SF 646.3 SF 646.2 SF 645.4 SF 846.4 SF 846.5 SF 12273.4 S 846.5 SF 540 SF 540 SF 540 SF 540 SF<</td></td<> | 645.4 SF 646.3 SF 645.4 SF 646.2 SF 586.9 SF 645.8 SF 807.9 SF 796.6 SF 846.4 SF 830.8 SF 830.8 SF 846.4 SF 846.4 SF 830.8 SF 846.4 SF 846.4 SF 846.4 SF 846.4 SF 846.4 SF 846.4 SF 540 SF 540 SF 645.2 SF 646.2 SF 646.3 SF 646.2 SF 645.4 SF 846.4 SF 846.5 SF 12273.4 S 846.5 SF 540 SF 540 SF 540 SF 540 SF< | A2 A2 A2 A2 A2 A2 A2 A2 A2 A3 A4 B B1 B2 B3 B4 B2 B3 A1 A2 B1 B2 B3 B2 B3 B2 B3 A1 A2 A2 A2 A2 A2 A2 A2 A2 A2 | 1 BR+DEN 1 BR+DEN 1 BR+DEN 1 BR+DEN 1 BR 1 BR 2 BR 1 BR 1 BR 1 BR 1 BR 1 BR 1 BR+DEN 1 BR+DEN 1 BR+DEN 1 BR+DEN 1 BR 2 BR 1 BR+DEN 1 BR 1 BR 1 BR 1 BR 1 BR 1 BR+DEN 1 BR+DEN 1 BR+DEN 1 BR+DEN 1 BR+DEN | 645.4 SF 646.3 SF 646.2 SF 586.9 SF 645.8 SF 807.9 SF 796.6 SF 846.4 SF 830.8 SF 866.5 SF 12273.5 SF 540 SF 540 SF 540 SF 540 SF 540 SF 645.2 SF 646.2 SF 646.2 SF 646.2 SF 646.3 SF 646.2 SF 645.4 SF 646.3 SF 645.4 SF 807.9 SF 645.4 SF 807.9 SF 645.8 SF 807.9 SF 645.8 SF 807.9 SF 796.6 SF 830.8 SF 830.8 SF 846.4 SF 854 SF 830.8 SF 645.2 SF 645.2 SF 646.2 SF 540 SF 540 SF 540 SF 540 SF 540 SF | 1 1 <td< td=""><td>645.4 SF 646.3 SF 645.4 SF 646.2 SF 586.9 SF 645.8 SF 807.9 SF 796.6 SF 846.4 SF 830.8 SF 830.8 SF 846.4 SF 846.4 SF 846.4 SF 846.4 SF 846.5 SF 12273.5 S 540 SF 540 SF 540 SF 646.2 SF 646.2 SF 646.3 SF 646.2 SF 646.3 SF 646.2 SF 646.3 SF 645.4 SF 8807.9 SF 796.6 SF 846.4 SF 854 SF 830.8 SF 846.4 SF 846.4 SF 846.4 SF 846.4 SF 846.4 SF 846.5 SF 12273.4 S 540 SF 540 SF 540 SF 540 SF 540 SF 540 SF</td></td<> | 645.4 SF 646.3 SF 645.4 SF 646.2 SF 586.9 SF 645.8 SF 807.9 SF 796.6 SF 846.4 SF 830.8 SF 830.8 SF 846.4 SF 846.4 SF 846.4 SF 846.4 SF 846.5 SF 12273.5 S 540 SF 540 SF 540 SF 646.2 SF 646.2 SF 646.3 SF 646.2 SF 646.3 SF 646.2 SF 646.3 SF 645.4 SF 8807.9 SF 796.6 SF 846.4 SF 854 SF 830.8 SF 846.4 SF 846.4 SF 846.4 SF 846.4 SF 846.4 SF 846.5 SF 12273.4 S 540 SF 540 SF 540 SF 540 SF 540 SF 540 SF | A2 A2 A2 A2 A2 A2 A2 A2 A2 A3 A4 B B1 B2 B3 B4 A0 A1 A2 B B1 B2 B2 B3 B2 B2 | 1 BR+DEN 1 BR+DEN 1 BR+DEN 1 BR+DEN 1 BR 1 BR 2 BR 1 BR 1 BR 1 BR 1 BR 1 BR 1 BR+DEN 1 BR+DEN 1 BR+DEN 1 BR+DEN 1 BR 2 BR 1 BR+DEN 1 BR+DEN 1 BR+DEN 1 BR+DEN 1 BR+DEN | 645.4 SF 646.3 SF 645.4 SF 646.2 SF 586.9 SF 645.8 SF 807.9 SF 796.6 SF 846.4 SF 830.8 SF 866.5 SF 12273.5 SF 540 SF 540 SF 540 SF 540 SF 645.2 SF 646.2 SF 646.2 SF 646.2 SF 646.3 SF 646.2 SF 646.3 SF 645.4 SF 807.9 SF 796.6 SF 846.4 SF 846.3 SF 645.2 SF 645.3 SF 645.4 SF 807.9 SF 796.6 SF 846.4 SF 830.8 SF 866.5 SF 12273.4 SF 645.2 SF 640.5 SF 540 SF 540 SF 540 SF 540 SF 540 SF 540 SF 646.2 SF | 1 1 <td< td=""><td>645.4 SF 646.3 SF 645.4 SF 646.2 SF 586.9 SF 645.8 SF 807.9 SF 796.6 SF 846.4 SF 830.8 SF 830.8 SF 846.4 SF 846.4 SF 830.8 SF 846.4 SF 846.4 SF 846.4 SF 846.4 SF 846.4 SF 846.4 SF 540 SF 540 SF 645.2 SF 646.2 SF 646.3 SF 646.2 SF 645.4 SF 846.4 SF 846.5 SF 12273.4 S 846.5 SF 540 SF 540 SF 540 SF 540 SF<</td></td<> | 645.4 SF 646.3 SF 645.4 SF 646.2 SF 586.9 SF 645.8 SF 807.9 SF 796.6 SF 846.4 SF 830.8 SF 830.8 SF 846.4 SF 846.4 SF 830.8 SF 846.4 SF 846.4 SF 846.4 SF 846.4 SF 846.4 SF 846.4 SF 540 SF 540 SF 645.2 SF 646.2 SF 646.3 SF 646.2 SF 645.4 SF 846.4 SF 846.5 SF 12273.4 S 846.5 SF 540 SF 540 SF 540 SF 540 SF< | A2 A1 A0 A1 A2 A3 A4 B B1 B2 B3 A1 A2 A2 A2 A2 A2 A2 A2 A2 A2 A2 | 1 BR+DEN 1 BR+DEN 1 BR+DEN 1 BR+DEN 1 BR 1 BR 2 BR 1 BR+DEN 1 BR+DEN 1 BR+DEN 1 BR+DEN 1 BR 2 BR 1 BR | 645.4 SF 646.3 SF 646.2 SF 586.9 SF 645.8 SF 807.9 SF 796.6 SF 846.4 SF 830.8 SF 866.5 SF 12273.5 SF 540 SF 540 SF 540 SF 540 SF 540 SF 646.2 SF 646.2 SF 646.2 SF 646.2 SF 646.2 SF 646.2 SF 646.3 SF 646.3 SF 646.4 SF 807.9 SF 646.3 SF 645.4 SF 807.9 SF 645.8 SF 807.9 SF 645.8 SF 807.9 SF 796.6 SF 830.8 SF 846.4 SF 854 SF 830.8 SF 846.5 SF 12273.4 SF 646.2 SF 540 SF 540 SF 540 SF 540 SF 540 SF | 1 1
 1 1 <td< td=""><td>645.4 SF 646.3 SF 645.4 SF 646.2 SF 586.9 SF 645.8 SF 807.9 SF 796.6 SF 846.4 SF 830.8 SF 830.8 SF 846.4 SF 854 SF 830.8 SF 866.5 SF 12273.5 S 540 SF 540 SF 540 SF 646.2 SF 646.2 SF 646.2 SF 646.3 SF 646.3 SF 645.4 SF 846.4 SF 846.5 SF 12273.4 S 540 SF 540 SF </td></td<> | 645.4 SF 646.3 SF 645.4 SF 646.2 SF 586.9 SF 645.8 SF 807.9 SF 796.6 SF 846.4 SF 830.8 SF 830.8 SF 846.4 SF 854 SF 830.8 SF 866.5 SF 12273.5 S 540 SF 540 SF 540 SF 646.2 SF 646.2 SF 646.2 SF 646.3 SF 646.3 SF 645.4 SF 846.4 SF 846.5 SF 12273.4 S 540 SF 540 SF | A2 A3 A4 B B1 B2 B3 B4 A0 A1 A2 B B1 B2 B3 A1 A2 A2 | 1 BR+DEN 1 BR+DEN 1 BR+DEN 1 BR+DEN 1 BR 1 BR 2 BR 1 BR+DEN 1 BR+DEN 1 BR+DEN 1 BR+DEN 1 BR 2 BR 1 BR | 645.4 SF 646.3 SF 645.4 SF 645.8 SF 807.9 SF 796.6 SF 846.4 SF 830.8 SF 866.5 SF 12273.5 SF 540 SF 540 SF 540 SF 540 SF 540 SF 646.2 SF 646.2 SF 646.2 SF 646.2 SF 646.2 SF 646.3 SF 646.2 SF 646.3 SF 646.3 SF 646.4 SF 807.9 SF 796.6 SF 846.4 SF 807.9 SF 796.6 SF 846.4 SF 807.9 SF 796.6 SF 846.4 SF 830.8 SF 866.5 SF 12273.4 SF 646.2 SF 646.2 SF 646.2 SF 646.2 SF 646.2 SF 646.3 SF 646.2 SF 646.2 SF 646. | 1 1 <td< td=""><td>645.4 SF 646.3 SF 645.4 SF 646.2 SF 645.8 SF 807.9 SF 796.6 SF 846.4 SF 830.8 SF 830.8 SF 846.4 SF 846.4 SF 830.8 SF 846.4 SF 846.4 SF 846.4 SF 846.4 SF 846.4 SF 846.5 SF 12273.5 S 540 SF 540 SF 540 SF 645.2 SF 646.2 SF 645.2 SF 645.3 SF 645.4 SF 807.9 SF 796.6 SF 846.4 SF 830.8 SF 830.8 SF 846.4 SF 830.8 SF 846.5 SF 12273.4 S 540 SF 540 SF <!--</td--></td></td<> | 645.4 SF 646.3 SF 645.4 SF 646.2 SF 645.8 SF 807.9 SF 796.6 SF 846.4 SF 830.8 SF 830.8 SF 846.4 SF 846.4 SF 830.8 SF 846.4 SF 846.4 SF 846.4 SF 846.4 SF 846.4 SF 846.5 SF 12273.5 S 540 SF 540 SF 540 SF 645.2 SF 646.2 SF 645.2 SF 645.3 SF 645.4 SF 807.9 SF 796.6 SF 846.4 SF 830.8 SF 830.8 SF 846.4 SF 830.8 SF 846.5 SF 12273.4 S 540 SF 540 SF </td |
| 645.4 SF
646.3 SF
645.4 SF
646.2 SF
586.9 SF
645.8 SF
807.9 SF
796.6 SF
846.4 SF
830.8 SF
866.5 SF
12273.5 S
540 SF
540 SF
540 SF
540 SF
646.2 SF
646.2 SF
646.2 SF
645.2 SF
645.3 SF
645.4 SF
807.9 SF
796.6 SF
846.4 SF
854 SF
830.8 SF | | |

 | | | | | | | | | | | | | |
 | | | | | | | | | | | | | |
 | | | | | | | |
 | | | | | | | |
 | | | | | | | | |
 | | | | | | | | | | |
 | | | | | | | | | | |
 | | | | | | | | | |
| A2
A2
A2
A2
A2
A2
A2
A2
A2
A3
A3
A4
B
B
B
B
B
B
C
B
C
C
C | 1 BR+DEN 1 BR+DEN 1 BR+DEN 1 BR+DEN 1 BR 1 BR 2 BR 1 BR 1 BR 1 BR 1 BR 1 BR+DEN 1 BR+DEN 1 BR+DEN 1 BR+DEN 1 BR+DEN 1 BR 2 BR | 645.4 SF 646.3 SF 646.4 SF 646.2 SF 586.9 SF 645.8 SF 807.9 SF 796.6 SF 846.4 SF 854 SF 830.8 SF 866.5 SF 12273.5 SF 540 SF 540 SF 540 SF 540 SF 646.2 SF 646.2 SF 646.2 SF 646.2 SF 646.3 SF 645.4 SF 807.9 SF 796.6 SF 846.4 SF 846.3 SF 645.2 SF 645.2 SF 645.3 SF 807.9 SF 796.6 SF 807.9 SF 796.6 SF 846.4 SF 830.8 SF 830.8 SF 866.5 SF 12273.4 SF | 1 1 <td< td=""><td>645.4 SF
646.3 SF
645.4 SF
646.2 SF
586.9 SF
645.8 SF
807.9 SF
796.6 SF
846.4 SF
830.8 SF
866.5 SF
12273.5 S
540 SF
540 SF
540 SF
540 SF
646.2 SF
646.2 SF
646.2 SF
645.2 SF
645.2 SF
645.3 SF
645.3 SF
645.4 SF
807.9 SF
796.6 SF
846.4 SF
830.8 SF
830.8 SF
830.8 SF
830.8 SF
866.5 SF</td></td<>

 | 645.4 SF
646.3 SF
645.4 SF
646.2 SF
586.9 SF
645.8 SF
807.9 SF
796.6 SF
846.4 SF
830.8 SF
866.5 SF
12273.5 S
540 SF
540 SF
540 SF
540 SF
646.2 SF
646.2 SF
646.2 SF
645.2 SF
645.2 SF
645.3 SF
645.3 SF
645.4 SF
807.9 SF
796.6 SF
846.4 SF
830.8 SF
830.8 SF
830.8 SF
830.8 SF
866.5 SF | | | | | | | | | | | | |
 | | | | | | | | | | | | | |
 | | | | | | | |
 | | | | | | |
 | | | | | | | | |
 | | | | | | | | | | |
 | | | | | | | | | | | |
 | | | | | | | | |
| A2
A2
A2
A2
A2
A2
A2
A2
A2
A3
A4
B
B1
B2
B3
A0
B3
A0
A1
A0
A1
A1
A0
A1
A1
A0
A1
A1
A0
A1
A1
A0
A1
A1
A1 | 1 BR+DEN 1 BR+DEN 1 BR+DEN 1 BR+DEN 1 BR 1 BR 2 BR 1 BR 1 BR 1 BR 1 BR 1 BR 1 BR+DEN 1 BR+DEN 1 BR+DEN 1 BR+DEN 1 BR+DEN 1 BR 2 BR | 645.4 SF 646.3 SF 646.2 SF 586.9 SF 645.8 SF 807.9 SF 796.6 SF 846.4 SF 830.8 SF 866.5 SF 12273.5 SF 540 SF 543 SF 646.2 SF 646.2 SF 645.2 SF 645.2 SF 645.2 SF 645.3 SF 645.4 SF 807.9 SF 796.6 SF 807.9 SF 796.6 SF 846.4 SF 830.8 SF 807.9 SF 796.6 SF 846.4 SF 854 SF 830.8 SF 866.5 SF 12273.4 SF | 1 1 <td< td=""><td>645.4 SF 646.3 SF 645.4 SF 646.2 SF 586.9 SF 645.8 SF 807.9 SF 796.6 SF 846.4 SF 830.8 SF 866.5 SF 12273.5 S 540 SF 540 SF 540 SF 646.2 SF 646.2 SF 646.2 SF 646.2 SF 646.2 SF 646.2 SF 646.3 SF 645.4 SF 646.3 SF 645.4 SF 645.5 SF 796.6 SF 807.9 SF 796.6 SF 807.9 SF 796.6 SF 830.8 SF 830.8 SF 846.4 SF 854 SF 830.8 SF 866.5 SF 12273.4 S</td></td<>

 | 645.4 SF 646.3 SF 645.4 SF 646.2 SF 586.9 SF 645.8 SF 807.9 SF 796.6 SF 846.4 SF 830.8 SF 866.5 SF 12273.5 S 540 SF 540 SF 540 SF 646.2 SF 646.2 SF 646.2 SF 646.2 SF 646.2 SF 646.2 SF 646.3 SF 645.4 SF 646.3 SF 645.4 SF 645.5 SF 796.6 SF 807.9 SF 796.6 SF 807.9 SF 796.6 SF 830.8 SF 830.8 SF 846.4 SF 854 SF 830.8 SF 866.5 SF 12273.4 S | | | | | | | | | | | | |
 | | | | | | | | | | | | | |
 | | | | | | | |
 | | | | | | |
 | | | | | | | | |
 | | | | | | | | | | |
 | | | | | | | | | | | |
 | | | | | | | | |
| A2
A2
A2
A2
A2
A2
A2
A2
A2
A3
A4
B
B
B
B
B
B
C
B
C
C
C | 1 BR+DEN 1 BR+DEN 1 BR+DEN 1 BR+DEN 1 BR 1 BR 2 BR 1 BR+DEN 1 BR+DEN 1 BR+DEN 1 BR+DEN 1 BR 2 BR | 645.4 SF 646.3 SF 646.4 SF 646.2 SF 586.9 SF 645.8 SF 807.9 SF 796.6 SF 846.4 SF 854 SF 830.8 SF 866.5 SF 12273.5 SF 540 SF 540 SF 540 SF 540 SF 646.2 SF 646.2 SF 646.2 SF 646.2 SF 646.3 SF 645.4 SF 807.9 SF 796.6 SF 846.4 SF 846.3 SF 645.2 SF 645.2 SF 645.3 SF 807.9 SF 796.6 SF 807.9 SF 796.6 SF 846.4 SF 830.8 SF 830.8 SF 866.5 SF 12273.4 SF | 1 1 <td< td=""><td>645.4 SF
646.3 SF
645.4 SF
646.2 SF
586.9 SF
645.8 SF
807.9 SF
796.6 SF
846.4 SF
830.8 SF
866.5 SF
12273.5 S
540 SF
540 SF
540 SF
540 SF
646.2 SF
646.2 SF
646.2 SF
645.2 SF
645.2 SF
645.3 SF
645.3 SF
645.4 SF
807.9 SF
796.6 SF
846.4 SF
830.8 SF
830.8 SF
830.8 SF
830.8 SF
866.5 SF</td></td<>

 | 645.4 SF
646.3 SF
645.4 SF
646.2 SF
586.9 SF
645.8 SF
807.9 SF
796.6 SF
846.4 SF
830.8 SF
866.5 SF
12273.5 S
540 SF
540 SF
540 SF
540 SF
646.2 SF
646.2 SF
646.2 SF
645.2 SF
645.2 SF
645.3 SF
645.3 SF
645.4 SF
807.9 SF
796.6 SF
846.4 SF
830.8 SF
830.8 SF
830.8 SF
830.8 SF
866.5 SF | | | | | | | | | | | | |
 | | | | | | | | | | | | | |
 | | | | | | | |
 | | | | | | |
 | | | | | | | | |
 | | | | | | | | | | |
 | | | | | | | | | | | |
 | | | | | | | | |
| A2
A2
A2
A3
A4
B
B
B
B
B
B
B
C
B
C
C
C | 1 BR+DEN 1 BR+DEN 1 BR+DEN 1 BR+DEN 1 BR 1 BR 2 BR 1 BR 1 BR 1 BR 1 BR 1 BR 1 BR+DEN 1 BR+DEN 1 BR+DEN 1 BR+DEN 1 BR 2 BR 1 BR | 645.4 SF 646.3 SF 646.2 SF 586.9 SF 645.8 SF 807.9 SF 796.6 SF 846.4 SF 854 SF 830.8 SF 866.5 SF 12273.5 SF 540 SF 540 SF 540 SF 540 SF 645.2 SF 646.2 SF 646.2 SF 646.2 SF 646.2 SF 646.3 SF 645.4 SF 807.9 SF 646.3 SF 645.4 SF 807.9 SF 796.6 SF 846.4 SF 807.9 SF 796.6 SF 846.4 SF 807.9 SF 796.6 SF 846.4 SF 830.8 SF 803.8 SF 866.5 SF 12273.4 SF 540 SF | 1 1 <td< td=""><td>645.4 SF 646.3 SF 645.4 SF 646.2 SF 586.9 SF 645.8 SF 807.9 SF 796.6 SF 846.4 SF 830.8 SF 830.8 SF 846.4 SF 854 SF 830.8 SF 646.2 SF 540 SF 540 SF 540 SF 646.2 SF 646.2 SF 646.3 SF 645.4 SF 646.3 SF 645.4 SF 646.3 SF 645.4 SF 846.4 SF 846.4 SF 846.4 SF 830.8 SF 846.4 SF 830.8 SF 846.4 SF 830.8 SF 830.8 SF 846.4 SF 830.8 SF 846.5 SF 12273.4 S 540 SF 540 SF 540 SF 540 SF 540 SF 540 SF 540 SF <</td></td<>

 | 645.4 SF 646.3 SF 645.4 SF 646.2 SF 586.9 SF 645.8 SF 807.9 SF 796.6 SF 846.4 SF 830.8 SF 830.8 SF 846.4 SF 854 SF 830.8 SF 646.2 SF 540 SF 540 SF 540 SF 646.2 SF 646.2 SF 646.3 SF 645.4 SF 646.3 SF 645.4 SF 646.3 SF 645.4 SF 846.4 SF 846.4 SF 846.4 SF 830.8 SF 846.4 SF 830.8 SF 846.4 SF 830.8 SF 830.8 SF 846.4 SF 830.8 SF 846.5 SF 12273.4 S 540 SF 540 SF 540 SF 540 SF 540 SF 540 SF 540 SF < | | | | | | | | | | | | |
 | | | | | | | | | | | | | |
 | | | | | | | |
 | | | | | | |
 | | | | | | | | |
 | | | | | | | | | | |
 | | | | | | | | | | | |
 | | | | | | | | |
| A2
A2
A2
A3
A4
B
B1
B2
B3
A0
B1
B2
B3
A0
A1
A0
A1
A0
A1
A0
A1
A0
A2
A2
A2 | 1 BR+DEN 1 BR+DEN 1 BR+DEN 1 BR+DEN 1 BR 1 BR 2 BR 1 BR 1 BR 1 BR 1 BR 1 BR 1 BR+DEN 1 BR+DEN 1 BR+DEN 1 BR+DEN 1 BR 2 BR 1 BR | 645.4 SF 646.3 SF 646.2 SF 586.9 SF 645.8 SF 807.9 SF 796.6 SF 846.4 SF 830.8 SF 866.5 SF 12273.5 SF 540 SF 543 SF 646.2 SF 645.2 SF 645.2 SF 645.3 SF 645.4 SF 807.9 SF 796.6 SF 846.4 SF 807.9 SF 796.6 SF 846.4 SF 830.8 SF 807.9 SF 796.6 SF 846.4 SF 830.8 SF 830.8 SF 830.8 SF 840.4 SF 840.4 SF 854 SF 830.8 SF 846.5 SF 12273.4 SF 540 SF 540 SF 540 SF | 1 1 <td< td=""><td>645.4 SF 646.3 SF 645.4 SF 646.2 SF 586.9 SF 645.8 SF 807.9 SF 796.6 SF 846.4 SF 830.8 SF 866.5 SF 12273.5 540 SF 540 SF 540 SF 540 SF 645.2 SF 646.2 SF 646.2 SF 646.2 SF 646.3 SF 646.3 SF 645.4 SF 645.3 SF 645.4 SF 645.5 SF 796.6 SF 807.9 SF 796.6 SF 830.8 SF 846.4 SF 854 SF 830.8 SF 846.4 SF 854 SF 830.8 SF 846.4 SF 854 SF 830.8 SF 846.5 SF 12273.4 S 540 SF 540 SF 540 SF 540 SF 540 SF </td></td<>

 | 645.4 SF 646.3 SF 645.4 SF 646.2 SF 586.9 SF 645.8 SF 807.9 SF 796.6 SF 846.4 SF 830.8 SF 866.5 SF 12273.5 540 SF 540 SF 540 SF 540 SF 645.2 SF 646.2 SF 646.2 SF 646.2 SF 646.3 SF 646.3 SF 645.4 SF 645.3 SF 645.4 SF 645.5 SF 796.6 SF 807.9 SF 796.6 SF 830.8 SF 846.4 SF 854 SF 830.8 SF 846.4 SF 854 SF 830.8 SF 846.4 SF 854 SF 830.8 SF 846.5 SF 12273.4 S 540 SF 540 SF 540 SF 540 SF 540 SF | | | | | | | | | | | | |
 | | | | | | | | | | | | | |
 | | | | | | | |
 | | | | | | |
 | | | | | | | | |
 | | | | | | | | | | |
 | | | | | | | | | | | |
 | | | | | | | | |
| A2
A2
A2
A3
A4
B
B
B
B
B
C
B
C
C
C | 1 BR+DEN 1 BR+DEN 1 BR+DEN 1 BR+DEN 1 BR 1 BR 2 BR 1 BR+DEN 1 BR+DEN 1 BR+DEN 1 BR 1 BR 2 BR 1 BR <t< td=""><td>645.4 SF 646.3 SF 646.2 SF 586.9 SF 645.8 SF 807.9 SF 796.6 SF 846.4 SF 830.8 SF 866.5 SF 12273.5 SF 540 SF 646.2 SF 646.2 SF 646.2 SF 646.3 SF 645.4 SF 646.3 SF 645.4 SF 645.4 SF 645.3 SF 645.4 SF 807.9 SF 796.6 SF 807.9 SF 796.6 SF 807.9 SF 796.6 SF 807.9 SF 796.6 SF 830.8 SF 830.8 SF 830.8 SF 846.4 SF 854 SF 830.8 SF 540 SF 540 SF 540 SF 540 SF 540 SF 540 SF <!--</td--><td>1 <td< td=""><td>645.4 SF 646.3 SF 645.4 SF 646.2 SF 586.9 SF 645.8 SF 807.9 SF 796.6 SF 846.4 SF 830.8 SF 830.8 SF 846.4 SF 846.4 SF 846.4 SF 846.4 SF 846.5 SF 12273.5 S 540 SF 540 SF 540 SF 646.2 SF 646.2 SF 646.3 SF 646.2 SF 646.3 SF 645.4 SF 846.4 SF 846.4 SF 846.4 SF 846.4 SF 830.8 SF 846.4 SF 854 SF 830.8 SF 846.4 SF 854 SF 830.8 SF 846.4 SF 854 SF 830.8 SF 540 SF 540 SF 540 SF 540 SF 540 SF 540 SF </td></td<></td></td></t<> | 645.4 SF 646.3 SF 646.2 SF 586.9 SF 645.8 SF 807.9 SF 796.6 SF 846.4 SF 830.8 SF 866.5 SF 12273.5 SF 540 SF 646.2 SF 646.2 SF 646.2 SF 646.3 SF 645.4 SF 646.3 SF 645.4 SF 645.4 SF 645.3 SF 645.4 SF 807.9 SF 796.6 SF 807.9 SF 796.6 SF 807.9 SF 796.6 SF 807.9 SF 796.6 SF 830.8 SF 830.8 SF 830.8 SF 846.4 SF 854 SF 830.8 SF 540 SF 540 SF 540 SF 540 SF 540 SF 540 SF </td <td>1 <td< td=""><td>645.4 SF 646.3 SF 645.4 SF 646.2 SF 586.9 SF 645.8 SF 807.9 SF 796.6 SF 846.4 SF 830.8 SF 830.8 SF 846.4 SF 846.4 SF 846.4 SF 846.4 SF 846.5 SF 12273.5 S 540 SF 540 SF 540 SF 646.2 SF 646.2 SF 646.3 SF 646.2 SF 646.3 SF 645.4 SF 846.4 SF 846.4 SF 846.4 SF 846.4 SF 830.8 SF 846.4 SF 854 SF 830.8 SF 846.4 SF 854 SF 830.8 SF 846.4 SF 854 SF 830.8 SF 540 SF 540 SF 540 SF 540 SF 540 SF 540 SF </td></td<></td> | 1 1 <td< td=""><td>645.4 SF 646.3 SF 645.4 SF 646.2 SF 586.9 SF 645.8 SF 807.9 SF 796.6 SF 846.4 SF 830.8 SF 830.8 SF 846.4 SF 846.4 SF 846.4 SF 846.4 SF 846.5 SF 12273.5 S 540 SF 540 SF 540 SF 646.2 SF 646.2 SF 646.3 SF 646.2 SF 646.3 SF 645.4 SF 846.4 SF 846.4 SF 846.4 SF 846.4 SF 830.8 SF 846.4 SF 854 SF 830.8 SF 846.4 SF 854 SF 830.8 SF 846.4 SF 854 SF 830.8 SF 540 SF 540 SF 540 SF 540 SF 540 SF 540 SF </td></td<>

 | 645.4 SF 646.3 SF 645.4 SF 646.2 SF 586.9 SF 645.8 SF 807.9 SF 796.6 SF 846.4 SF 830.8 SF 830.8 SF 846.4 SF 846.4 SF 846.4 SF 846.4 SF 846.5 SF 12273.5 S 540 SF 540 SF 540 SF 646.2 SF 646.2 SF 646.3 SF 646.2 SF 646.3 SF 645.4 SF 846.4 SF 846.4 SF 846.4 SF 846.4 SF 830.8 SF 846.4 SF 854 SF 830.8 SF 846.4 SF 854 SF 830.8 SF 846.4 SF 854 SF 830.8 SF 540 SF 540 SF 540 SF 540 SF 540 SF 540 SF | | | | | | | | | | | |
 | | | | | | | | | | | | |
 | | | | | | | |
 | | | | | | |
 | | | | | | | | |
 | | | | | | | | | | |
 | | | | | | | | | | | |
 | | | | | | | | |
| A2 A2 A2 A2 A2 A2 A2 A2 A2 A3 A4 B B1 B2 B3 A0 A1 A1 A2 A2 A2 A2 A1 A2 A3 A4 B B1 B2 B3 B4 A0 LEVEL A A1 A0 A1 A1 A2 <tr td=""> <tr td=""></tr></tr> | 1 BR+DEN 1 BR+DEN 1 BR+DEN 1 BR+DEN 1 BR 1 BR 2 BR 1 BR+DEN 1 BR+DEN 1 BR 1 BR 1 BR 2 BR 1 BR 1 BR 1 | 645.4 SF 646.3 SF 646.2 SF 586.9 SF 645.8 SF 807.9 SF 796.6 SF 846.4 SF 830.8 SF 866.5 SF 12273.5 SF 540 SF 540 SF 540 SF 540 SF 646.2 SF 646.2 SF 646.3 SF 646.2 SF 646.2 SF 646.2 SF 646.2 SF 646.3 SF 646.3 SF 646.3 SF 646.3 SF 646.3 SF 646.3 SF 645.4 SF 807.9 SF 645.8 SF 807.9 SF 645.8 SF 807.9 SF 645.8 SF 807.9 SF 796.6 SF 830.8 SF 866.5 SF 12273.4 SF 540 SF | 1 1 <td< td=""><td>645.4 SF 646.3 SF 645.4 SF 646.2 SF 586.9 SF 645.8 SF 807.9 SF 796.6 SF 846.4 SF 830.8 SF 866.5 SF 12273.5 540 SF 540 SF 540 SF 540 SF 646.2 SF 646.2 SF 646.2 SF 646.2 SF 646.3 SF 646.3 SF 646.3 SF 646.3 SF 645.4 SF 846.4 SF 846.4 SF 846.5 SF 12273.4 S 540 SF 540 SF 645.2 SF 645.3 SF 807.9 SF 796.6 SF 846.4 SF 854 SF 830.8 SF 846.4 SF 846.5 SF 12273.4 S 540 SF 540 SF 540 SF 540 SF 540 SF </td></td<>

 | 645.4 SF 646.3 SF 645.4 SF 646.2 SF 586.9 SF 645.8 SF 807.9 SF 796.6 SF 846.4 SF 830.8 SF 866.5 SF 12273.5 540 SF 540 SF 540 SF 540 SF 646.2 SF 646.2 SF 646.2 SF 646.2 SF 646.3 SF 646.3 SF 646.3 SF 646.3 SF 645.4 SF 846.4 SF 846.4 SF 846.5 SF 12273.4 S 540 SF 540 SF 645.2 SF 645.3 SF 807.9 SF 796.6 SF 846.4 SF 854 SF 830.8 SF 846.4 SF 846.5 SF 12273.4 S 540 SF 540 SF 540 SF 540 SF 540 SF | | | | | | | | | | | |
 | | | | | | | | | | | | |
 | | | | | | | |
 | | | | | | |
 | | | | | | | | |
 | | | | | | | | | | |
 | | | | | | | | | | | |
 | | | | | | | | |
| | | |

 | | | | | | | | | | | | | |
 | | | | | | | | | | | | | |
 | | | | | | | |
 | | | | | | | |
 | | | | | | | | |
 | | | | | | | | | | |
 | | | | | | | | | | |
 | | | | | | | | | |
| | | |

 | | | | | | | | | | | | | |
 | | | | | | | | | | | | | |
 | | | | | | | |
 | | | | | | | |
 | | | | | | | | |
 | | | | | | | | | | |
 | | | | | | | | | | |
 | | | | | | | | | |
| A2
A2
A2
A3
A4
B
B
B
B
B
C
B
C
C
C | 1 BR+DEN 1 BR+DEN 1 BR+DEN 1 BR+DEN 1 BR 1 BR 2 BR 1 BR+DEN 1 BR+DEN 1 BR+DEN 1 BR 1 BR 2 BR 1 BR <t< td=""><td>645.4 SF 646.3 SF 646.2 SF 586.9 SF 645.8 SF 807.9 SF 796.6 SF 846.4 SF 830.8 SF 866.5 SF 12273.5 SF 540 SF 646.2 SF 646.2 SF 646.2 SF 646.3 SF 645.4 SF 646.3 SF 645.4 SF 645.4 SF 645.3 SF 645.4 SF 807.9 SF 796.6 SF 807.9 SF 796.6 SF 807.9 SF 796.6 SF 807.9 SF 796.6 SF 830.8 SF 830.8 SF 830.8 SF 846.4 SF 854 SF 830.8 SF 540 SF 540 SF 540 SF 540 SF 540 SF 540 SF <!--</td--><td>1 <td< td=""><td>645.4 SF 646.3 SF 645.4 SF 646.2 SF 586.9 SF 645.8 SF 807.9 SF 796.6 SF 846.4 SF 830.8 SF 830.8 SF 846.4 SF 854 SF 830.8 SF 646.2 SF 540 SF 540 SF 540 SF 646.2 SF 646.2 SF 646.3 SF 645.4 SF 646.3 SF 646.3 SF 645.4 SF 846.4 SF 846.4 SF 846.5 SF 807.9 SF 645.8 SF 807.9 SF 645.8 SF 830.8 SF 830.8 SF 846.4 SF 830.8 SF 846.5 SF 12273.4 S 540 SF 540 SF </td></td<></td></td></t<> | 645.4 SF 646.3 SF 646.2 SF 586.9 SF 645.8 SF 807.9 SF 796.6 SF 846.4 SF 830.8 SF 866.5 SF 12273.5 SF 540 SF 646.2 SF 646.2 SF 646.2 SF 646.3 SF 645.4 SF 646.3 SF 645.4 SF 645.4 SF 645.3 SF 645.4 SF 807.9 SF 796.6 SF 807.9 SF 796.6 SF 807.9 SF 796.6 SF 807.9 SF 796.6 SF 830.8 SF 830.8 SF 830.8 SF 846.4 SF 854 SF 830.8 SF 540 SF 540 SF 540 SF 540 SF 540 SF 540 SF </td <td>1 <td< td=""><td>645.4 SF 646.3 SF 645.4 SF 646.2 SF 586.9 SF 645.8 SF 807.9 SF 796.6 SF 846.4 SF 830.8 SF 830.8 SF 846.4 SF 854 SF 830.8 SF 646.2 SF 540 SF 540 SF 540 SF 646.2 SF 646.2 SF 646.3 SF 645.4 SF 646.3 SF 646.3 SF 645.4 SF 846.4 SF 846.4 SF 846.5 SF 807.9 SF 645.8 SF 807.9 SF 645.8 SF 830.8 SF 830.8 SF 846.4 SF 830.8 SF 846.5 SF 12273.4 S 540 SF 540 SF </td></td<></td> | 1 1 <td< td=""><td>645.4 SF 646.3 SF 645.4 SF 646.2 SF 586.9 SF 645.8 SF 807.9 SF 796.6 SF 846.4 SF 830.8 SF 830.8 SF 846.4 SF 854 SF 830.8 SF 646.2 SF 540 SF 540 SF 540 SF 646.2 SF 646.2 SF 646.3 SF 645.4 SF 646.3 SF 646.3 SF 645.4 SF 846.4 SF 846.4 SF 846.5 SF 807.9 SF 645.8 SF 807.9 SF 645.8 SF 830.8 SF 830.8 SF 846.4 SF 830.8 SF 846.5 SF 12273.4 S 540 SF 540 SF </td></td<>

 | 645.4 SF 646.3 SF 645.4 SF 646.2 SF 586.9 SF 645.8 SF 807.9 SF 796.6 SF 846.4 SF 830.8 SF 830.8 SF 846.4 SF 854 SF 830.8 SF 646.2 SF 540 SF 540 SF 540 SF 646.2 SF 646.2 SF 646.3 SF 645.4 SF 646.3 SF 646.3 SF 645.4 SF 846.4 SF 846.4 SF 846.5 SF 807.9 SF 645.8 SF 807.9 SF 645.8 SF 830.8 SF 830.8 SF 846.4 SF 830.8 SF 846.5 SF 12273.4 S 540 SF | | | | | | | | | | | |
 | | | | | | | | | | | | |
 | | | | | | | | |
 | | | | | | | |
 | | | | | | |
 | | | | | | | | | | | |
 | | | | | | | | | | | |
 | | | | | | | |
| A2
A2
A2
A3
A4
B
B
B
B
B
B
B
C
C
C | 1 BR+DEN 1 BR+DEN 1 BR+DEN 1 BR+DEN 1 BR 1 BR 2 BR 1 BR+DEN 1 BR+DEN 1 BR+DEN 1 BR+DEN 1 BR 2 BR 1 BR+DEN 1 BR+DEN < | 645.4 SF 646.3 SF 646.2 SF 586.9 SF 645.8 SF 807.9 SF 796.6 SF 846.4 SF 854 SF 830.8 SF 866.5 SF 12273.5 SF 540 SF 540 SF 540 SF 646.2 SF 646.2 SF 646.2 SF 646.2 SF 646.2 SF 646.2 SF 646.3 SF 646.3 SF 646.3 SF 646.3 SF 646.3 SF 646.5 SF 12273.4 SF 540 SF 540 SF 540 SF 540 SF 645.2 SF 646.2 SF 646.3 SF 807.9 SF 796.6 SF 830.8 SF 830.8 SF 830.8 SF 846.4 SF 830.8 SF 846.5 SF 12273.4 SF 540 SF 540 SF 540 SF 540 SF <td>1 <td< td=""><td>645.4 SF 646.3 SF 645.4 SF 646.2 SF 586.9 SF 645.8 SF 807.9 SF 796.6 SF 846.4 SF 830.8 SF 830.8 SF 846.4 SF 846.5 SF 12273.5 S 540 SF 540 SF 645.2 SF 646.2 SF 646.2 SF 646.3 SF 645.4 SF 807.9 SF 796.6 SF 846.4 SF 846.4 SF 830.8 SF 830.8 SF 830.8 SF 846.4 SF 846.4 SF 846.4 SF 846.4 SF 846.5 SF 12273.4 S 846.5 SF 540 SF 540 SF 540</td></td<></td> | 1 1 <td< td=""><td>645.4 SF 646.3 SF 645.4 SF 646.2 SF 586.9 SF 645.8 SF 807.9 SF 796.6 SF 846.4 SF 830.8 SF 830.8 SF 846.4 SF 846.5 SF 12273.5 S 540 SF 540 SF 645.2 SF 646.2 SF 646.2 SF 646.3 SF 645.4 SF 807.9 SF 796.6 SF 846.4 SF 846.4 SF 830.8 SF 830.8 SF 830.8 SF 846.4 SF 846.4 SF 846.4 SF 846.4 SF 846.5 SF 12273.4 S 846.5 SF 540 SF 540 SF 540</td></td<>

 | 645.4 SF 646.3 SF 645.4 SF 646.2 SF 586.9 SF 645.8 SF 807.9 SF 796.6 SF 846.4 SF 830.8 SF 830.8 SF 846.4 SF 846.5 SF 12273.5 S 540 SF 540 SF 645.2 SF 646.2 SF 646.2 SF 646.3 SF 645.4 SF 807.9 SF 796.6 SF 846.4 SF 846.4 SF 830.8 SF 830.8 SF 830.8 SF 846.4 SF 846.4 SF 846.4 SF 846.4 SF 846.5 SF 12273.4 S 846.5 SF 540 SF 540 SF 540 | | | | | | | | | | | |
 | | | | | | | | | | | | |
 | | | | | | | | |
 | | | | | | |
 | | | | | | | |
 | | | | | | | | | | | |
 | | | | | | | | | | |
 | | | | | | | | |
| A2 A2 A2 A2 A2 A2 A2 A2 A2 A3 A4 B B1 B2 B3 B4 A0 A1 A2 A2 A2 A1 A2 B B1 B2 B3 B2 B3 B4 A0 A1 A2 A2 A2 A2 A2 A2 A2 | 1 BR+DEN 1 BR+DEN 1 BR+DEN 1 BR+DEN 1 BR 1 BR 2 BR 1 BR+DEN 1 BR+DEN 1 BR+DEN 1 BR 2 BR 1 BR 1 BR 1 BR 1 BR 1 BR 1 BR+DEN 1 BR+DEN 1 BR+DEN < | 645.4 SF 646.3 SF 646.2 SF 586.9 SF 645.8 SF 807.9 SF 796.6 SF 846.4 SF 830.8 SF 866.5 SF 12273.5 SF 540 SF 540 SF 540 SF 540 SF 646.2 SF 646.2 SF 646.3 SF 646.2 SF 646.2 SF 646.2 SF 646.3 SF 646.3 SF 646.3 SF 646.3 SF 646.4 SF 807.9 SF 796.6 SF 807.9 SF 645.8 SF 807.9 SF 645.8 SF 807.9 SF 796.6 SF 807.9 SF 796.6 SF 803.8 SF 866.5 SF 12273.4 SF 646.2 SF 640 SF 540 SF 540 SF 540 SF 540 SF 540 SF 540 SF 646.2 SF <td>1 <td< td=""><td>645.4 SF 646.3 SF 645.4 SF 646.2 SF 586.9 SF 645.8 SF 807.9 SF 796.6 SF 846.4 SF 830.8 SF 830.8 SF 846.4 SF 854 SF 830.8 SF 846.4 SF 846.4 SF 854 SF 846.4 SF 846.5 SF 12273.5 S 540 SF 540 SF 540 SF 646.2 SF 646.2 SF 646.2 SF 646.3 SF 646.3 SF 646.3 SF 645.4 SF 807.9 SF 645.8 SF 807.9 SF 645.8 SF 830.8 SF 846.4 SF 854 SF 830.8 SF 846.4 SF 846.5 SF 12273.4 S 540 SF 540 SF 540 SF 540 SF 540 SF</td></td<></td> | 1 1 <td< td=""><td>645.4 SF 646.3 SF 645.4 SF 646.2 SF 586.9 SF 645.8 SF 807.9 SF 796.6 SF 846.4 SF 830.8 SF 830.8 SF 846.4 SF 854 SF 830.8 SF 846.4 SF 846.4 SF 854 SF 846.4 SF 846.5 SF 12273.5 S 540 SF 540 SF 540 SF 646.2 SF 646.2 SF 646.2 SF 646.3 SF 646.3 SF 646.3 SF 645.4 SF 807.9 SF 645.8 SF 807.9 SF 645.8 SF 830.8 SF 846.4 SF 854 SF 830.8 SF 846.4 SF 846.5 SF 12273.4 S 540 SF 540 SF 540 SF 540 SF 540 SF</td></td<>

 | 645.4 SF 646.3 SF 645.4 SF 646.2 SF 586.9 SF 645.8 SF 807.9 SF 796.6 SF 846.4 SF 830.8 SF 830.8 SF 846.4 SF 854 SF 830.8 SF 846.4 SF 846.4 SF 854 SF 846.4 SF 846.5 SF 12273.5 S 540 SF 540 SF 540 SF 646.2 SF 646.2 SF 646.2 SF 646.3 SF 646.3 SF 646.3 SF 645.4 SF 807.9 SF 645.8 SF 807.9 SF 645.8 SF 830.8 SF 846.4 SF 854 SF 830.8 SF 846.4 SF 846.5 SF 12273.4 S 540 SF 540 SF 540 SF 540 SF 540 SF | | | | | | | | | | | |
 | | | | | | | | | | | | |
 | | | | | | | |
 | | | | | | |
 | | | | | | | | |
 | | | | | | | | | | |
 | | | | | | | | | | | |
 | | | | | | | | |
| A2 A2 A2 A2 A2 A2 A2 A2 A2 A3 A4 B B1 B2 B3 B4 A0 A1 A2 A3 A4 B B1 B2 B3 B2 B3 A1 A2 A2 A2 A2 A2 A2 A2 A2 | 1 BR+DEN 1 BR+DEN 1 BR+DEN 1 BR+DEN 1 BR 1 BR 2 BR 1 BR+DEN 1 BR+DEN 1 BR+DEN 1 BR 1 BR 1 BR 1 BR 1 BR 2 BR 1 BR 1 BR 1 BR 1 BR 1 BR 1 BR+DEN 1 BR+DEN 1 BR+DEN < | 645.4 SF 646.3 SF 646.2 SF 586.9 SF 645.8 SF 807.9 SF 796.6 SF 846.4 SF 830.8 SF 866.5 SF 12273.5 SF 540 SF 540 SF 540 SF 646.2 SF 646.2 SF 646.3 SF 646.2 SF 646.2 SF 646.2 SF 646.2 SF 646.3 SF 646.3 SF 646.3 SF 646.4 SF 807.9 SF 796.6 SF 846.4 SF 807.9 SF 796.6 SF 846.4 SF 807.9 SF 796.6 SF 846.4 SF 830.8 SF 866.5 SF 12273.4 SF 540 SF | 1 1 <td< td=""><td>645.4 SF 646.3 SF 645.4 SF 646.2 SF 586.9 SF 645.8 SF 807.9 SF 796.6 SF 846.4 SF 830.8 SF 830.8 SF 846.4 SF 540 SF 540 SF 540 SF 645.2 SF 645.2 SF 646.2 SF 645.4 SF 645.3 SF 645.4 SF 807.9 SF 796.6 SF 846.4 SF 830.8 SF 830.8 SF 846.4 SF 846.5 SF 12273.4 S 540 SF 540 SF </td></td<>

 | 645.4 SF 646.3 SF 645.4 SF 646.2 SF 586.9 SF 645.8 SF 807.9 SF 796.6 SF 846.4 SF 830.8 SF 830.8 SF 846.4 SF 540 SF 540 SF 540 SF 645.2 SF 645.2 SF 646.2 SF 645.4 SF 645.3 SF 645.4 SF 807.9 SF 796.6 SF 846.4 SF 830.8 SF 830.8 SF 846.4 SF 846.5 SF 12273.4 S 540 SF | | | | | | | | | | | | |
 | | | | | | | | | | | | |
 | | | | | | | |
 | | | | | | | |
 | | | | | | | |
 | | | | | | | | | | |
 | | | | | | | | | | | |
 | | | | | | | |
| A2 A2 A2 A2 A2 A2 A2 A2 A2 A3 A4 B B1 B2 B3 B4 A0 A1 A2 B B1 B2 B2 B3 B2 | 1 BR+DEN 1 BR+DEN 1 BR+DEN 1 BR+DEN 1 BR 1 BR 2 BR 1 BR 1 BR 1 BR 1 BR 1 BR 1 BR+DEN 1 BR+DEN 1 BR+DEN 1 BR 1 BR 2 BR 1 BR+DEN 1 BR+DEN 1 BR+DEN 1 BR+DEN | 645.4 SF 646.3 SF 645.4 SF 646.2 SF 586.9 SF 645.8 SF 807.9 SF 796.6 SF 846.4 SF 830.8 SF 866.5 SF 12273.5 SF 540 SF 540 SF 540 SF 540 SF 645.2 SF 646.2 SF 646.2 SF 646.2 SF 646.3 SF 646.2 SF 646.3 SF 645.4 SF 807.9 SF 796.6 SF 846.4 SF 846.3 SF 645.2 SF 645.3 SF 645.4 SF 807.9 SF 796.6 SF 846.4 SF 830.8 SF 866.5 SF 12273.4 SF 645.2 SF 640.5 SF 540 SF 540 SF 540 SF 540 SF 540 SF 540 SF 646.2 SF | 1 1 <td< td=""><td>645.4 SF 646.3 SF 645.4 SF 646.2 SF 586.9 SF 645.8 SF 807.9 SF 796.6 SF 846.4 SF 830.8 SF 830.8 SF 846.4 SF 846.4 SF 830.8 SF 846.4 SF 846.4 SF 846.4 SF 846.4 SF 846.4 SF 846.4 SF 540 SF 540 SF 645.2 SF 646.2 SF 646.3 SF 646.2 SF 645.4 SF 846.4 SF 846.5 SF 12273.4 S 846.5 SF 540 SF 540 SF 540 SF 540 SF<</td></td<>


 | 645.4 SF 646.3 SF 645.4 SF 646.2 SF 586.9 SF 645.8 SF 807.9 SF 796.6 SF 846.4 SF 830.8 SF 830.8 SF 846.4 SF 846.4 SF 830.8 SF 846.4 SF 846.4 SF 846.4 SF 846.4 SF 846.4 SF 846.4 SF 540 SF 540 SF 645.2 SF 646.2 SF 646.3 SF 646.2 SF 645.4 SF 846.4 SF 846.5 SF 12273.4 S 846.5 SF 540 SF 540 SF 540 SF 540 SF< | | | | | | | | | | | |
 | | | | | | | | | | | | |
 | | | | | | | | |
 | | | | | | | |
 | | | | | | | |
 | | | | | | | | | | |
 | | | | | | | | | | | |
 | | | | | | | |
| A2 A2 A2 A2 A2 A2 A2 A2 A2 A3 A4 B B1 B2 B3 B4 B2 B3 A1 A2 B1 B2 B3 B2 B3 B2 B3 A1 A2 A2 A2 A2 A2 A2 A2 A2 A2 | 1 BR+DEN 1 BR+DEN 1 BR+DEN 1 BR+DEN 1 BR 1 BR 2 BR 1 BR 1 BR 1 BR 1 BR 1 BR 1 BR+DEN 1 BR+DEN 1 BR+DEN 1 BR+DEN 1 BR 2 BR 1 BR+DEN 1 BR 1 BR 1 BR 1 BR 1 BR 1 BR+DEN 1 BR+DEN 1 BR+DEN 1 BR+DEN 1 BR+DEN | 645.4 SF 646.3 SF 646.2 SF 586.9 SF 645.8 SF 807.9 SF 796.6 SF 846.4 SF 830.8 SF 866.5 SF 12273.5 SF 540 SF 540 SF 540 SF 540 SF 540 SF 645.2 SF 646.2 SF 646.2 SF 646.2 SF 646.3 SF 646.2 SF 645.4 SF 646.3 SF 645.4 SF 807.9 SF 645.4 SF 807.9 SF 645.8 SF 807.9 SF 645.8 SF 807.9 SF 796.6 SF 830.8 SF 830.8 SF 846.4 SF 854 SF 830.8 SF 645.2 SF 645.2 SF 646.2 SF 540 SF 540 SF 540 SF 540 SF 540 SF | 1 1 <td< td=""><td>645.4 SF 646.3 SF 645.4 SF 646.2 SF 586.9 SF 645.8 SF 807.9 SF 796.6 SF 846.4 SF 830.8 SF 830.8 SF 846.4 SF 846.4 SF 846.4 SF 846.4 SF 846.5 SF 12273.5 S 540 SF 540 SF 540 SF 646.2 SF 646.2 SF 646.3 SF 646.2 SF 646.3 SF 646.2 SF 646.3 SF 645.4 SF 8807.9 SF 796.6 SF 846.4 SF 854 SF 830.8 SF 846.4 SF 846.4 SF 846.4 SF 846.4 SF 846.4 SF 846.5 SF 12273.4 S 540 SF 540 SF 540 SF 540 SF 540 SF 540 SF</td></td<>

 | 645.4 SF 646.3 SF 645.4 SF 646.2 SF 586.9 SF 645.8 SF 807.9 SF 796.6 SF 846.4 SF 830.8 SF 830.8 SF 846.4 SF 846.4 SF 846.4 SF 846.4 SF 846.5 SF 12273.5 S 540 SF 540 SF 540 SF 646.2 SF 646.2 SF 646.3 SF 646.2 SF 646.3 SF 646.2 SF 646.3 SF 645.4 SF 8807.9 SF 796.6 SF 846.4 SF 854 SF 830.8 SF 846.4 SF 846.4 SF 846.4 SF 846.4 SF 846.4 SF 846.5 SF 12273.4 S 540 SF 540 SF 540 SF 540 SF 540 SF 540 SF | | | | | | | | | | | | |
 | | | | | | | | | | | | | |
 | | | | | | | |
 | | | | | | |
 | | | | | | | | |
 | | | | | | | | | | |
 | | | | | | | | | | | |
 | | | | | | | | |
| A2 A2 A2 A2 A2 A2 A2 A2 A2 A3 A4 B B1 B2 B3 B4 A0 A1 A2 B B1 B2 B2 B3 B2 | 1 BR+DEN 1 BR+DEN 1 BR+DEN 1 BR+DEN 1 BR 1 BR 2 BR 1 BR 1 BR 1 BR 1 BR 1 BR 1 BR+DEN 1 BR+DEN 1 BR+DEN 1 BR+DEN 1 BR 2 BR 1 BR+DEN 1 BR+DEN 1 BR+DEN 1 BR+DEN 1 BR+DEN | 645.4 SF 646.3 SF 645.4 SF 646.2 SF 586.9 SF 645.8 SF 807.9 SF 796.6 SF 846.4 SF 830.8 SF 866.5 SF 12273.5 SF 540 SF 540 SF 540 SF 540 SF 645.2 SF 646.2 SF 646.2 SF 646.2 SF 646.3 SF 646.2 SF 646.3 SF 645.4 SF 807.9 SF 796.6 SF 846.4 SF 846.3 SF 645.2 SF 645.3 SF 645.4 SF 807.9 SF 796.6 SF 846.4 SF 830.8 SF 866.5 SF 12273.4 SF 645.2 SF 640.5 SF 540 SF 540 SF 540 SF 540 SF 540 SF 540 SF 646.2 SF | 1 1 <td< td=""><td>645.4 SF 646.3 SF 645.4 SF 646.2 SF 586.9 SF 645.8 SF 807.9 SF 796.6 SF 846.4 SF 830.8 SF 830.8 SF 846.4 SF 846.4 SF 830.8 SF 846.4 SF 846.4 SF 846.4 SF 846.4 SF 846.4 SF 846.4 SF 540 SF 540 SF 645.2 SF 646.2 SF 646.3 SF 646.2 SF 645.4 SF 846.4 SF 846.5 SF 12273.4 S 846.5 SF 540 SF 540 SF 540 SF 540 SF<</td></td<>

 | 645.4 SF 646.3 SF 645.4 SF 646.2 SF 586.9 SF 645.8 SF 807.9 SF 796.6 SF 846.4 SF 830.8 SF 830.8 SF 846.4 SF 846.4 SF 830.8 SF 846.4 SF 846.4 SF 846.4 SF 846.4 SF 846.4 SF 846.4 SF 540 SF 540 SF 645.2 SF 646.2 SF 646.3 SF 646.2 SF 645.4 SF 846.4 SF 846.5 SF 12273.4 S 846.5 SF 540 SF 540 SF 540 SF 540 SF< | | | | | | | | | | | |
 | | | | | | | | | | | | |
 | | | | | | | | |
 | | | | | | | |
 | | | | | | |
 | | | | | | | | | | | |
 | | | | | | | | | | | |
 | | | | | | | |
| A2 A1 A0 A1 A2 A3 A4 B B1 B2 B3 A1 A2 | 1 BR+DEN 1 BR+DEN 1 BR+DEN 1 BR+DEN 1 BR 1 BR 2 BR 1 BR+DEN 1 BR+DEN 1 BR+DEN 1 BR+DEN 1 BR 2 BR 1 BR | 645.4 SF 646.3 SF 646.2 SF 586.9 SF 645.8 SF 807.9 SF 796.6 SF 846.4 SF 830.8 SF 866.5 SF 12273.5 SF 540 SF 540 SF 540 SF 540 SF 540 SF 646.2 SF 646.2 SF 646.2 SF 646.2 SF 646.2 SF 646.2 SF 646.3 SF 646.3 SF 646.4 SF 807.9 SF 646.3 SF 645.4 SF 807.9 SF 645.8 SF 807.9 SF 645.8 SF 807.9 SF 796.6 SF 830.8 SF 846.4 SF 854 SF 830.8 SF 846.5 SF 12273.4 SF 646.2 SF 540 SF 540 SF 540 SF 540 SF 540 SF | 1 1 <td< td=""><td>645.4 SF 646.3 SF 645.4 SF 646.2 SF 586.9 SF 645.8 SF 807.9 SF 796.6 SF 846.4 SF 830.8 SF 830.8 SF 846.4 SF 854 SF 830.8 SF 866.5 SF 12273.5 S 540 SF 540 SF 540 SF 646.2 SF 646.2 SF 646.2 SF 646.3 SF 646.3 SF 645.4 SF 846.4 SF 846.5 SF 12273.4 S 540 SF 540 SF </td></td<>

 | 645.4 SF 646.3 SF 645.4 SF 646.2 SF 586.9 SF 645.8 SF 807.9 SF 796.6 SF 846.4 SF 830.8 SF 830.8 SF 846.4 SF 854 SF 830.8 SF 866.5 SF 12273.5 S 540 SF 540 SF 540 SF 646.2 SF 646.2 SF 646.2 SF 646.3 SF 646.3 SF 645.4 SF 846.4 SF 846.5 SF 12273.4 S 540 SF | | | | | | | | | | | | |
 | | | | | | | | | | | | | |
 | | | | | | |
 | | | | | | | |
 | | | | | | | |
 | | | | | | | | | | | |
 | | | | | | | | | | |
 | | | | | | | |
| A2 A3 A4 B B1 B2 B3 B4 A0 A1 A2 B B1 B2 B3 A1 A2 | 1 BR+DEN 1 BR+DEN 1 BR+DEN 1 BR+DEN 1 BR 1 BR 2 BR 1 BR+DEN 1 BR+DEN 1 BR+DEN 1 BR+DEN 1 BR 2 BR 1 BR | 645.4 SF 646.3 SF 645.4 SF 645.8 SF 807.9 SF 796.6 SF 846.4 SF 830.8 SF 866.5 SF 12273.5 SF 540 SF 540 SF 540 SF 540 SF 540 SF 646.2 SF 646.2 SF 646.2 SF 646.2 SF 646.2 SF 646.3 SF 646.2 SF 646.3 SF 646.3 SF 646.4 SF 807.9 SF 796.6 SF 846.4 SF 807.9 SF 796.6 SF 846.4 SF 807.9 SF 796.6 SF 846.4 SF 830.8 SF 866.5 SF 12273.4 SF 646.2 SF 646.2 SF 646.2 SF 646.2 SF 646.2 SF 646.3 SF 646.2 SF 646.2 SF 646. | 1 1 <td< td=""><td>645.4 SF 646.3 SF 645.4 SF 646.2 SF 645.8 SF 807.9 SF 796.6 SF 846.4 SF 830.8 SF 830.8 SF 846.4 SF 846.4 SF 830.8 SF 846.4 SF 846.4 SF 846.4 SF 846.4 SF 846.4 SF 846.5 SF 12273.5 S 540 SF 540 SF 540 SF 645.2 SF 646.2 SF 645.2 SF 645.3 SF 645.4 SF 807.9 SF 796.6 SF 846.4 SF 830.8 SF 830.8 SF 846.4 SF 830.8 SF 846.5 SF 12273.4 S 540 SF 540 SF <!--</td--></td></td<>

 | 645.4 SF 646.3 SF 645.4 SF 646.2 SF 645.8 SF 807.9 SF 796.6 SF 846.4 SF 830.8 SF 830.8 SF 846.4 SF 846.4 SF 830.8 SF 846.4 SF 846.4 SF 846.4 SF 846.4 SF 846.4 SF 846.5 SF 12273.5 S 540 SF 540 SF 540 SF 645.2 SF 646.2 SF 645.2 SF 645.3 SF 645.4 SF 807.9 SF 796.6 SF 846.4 SF 830.8 SF 830.8 SF 846.4 SF 830.8 SF 846.5 SF 12273.4 S 540 SF 540 SF </td | | | | | | | | | | | |
 | | | | | | | | | | | | |
 | | | | | | | | |
 | | | | | | | |
 | | | | | | | |
 | | | | | | | | | | |
 | | | | | | | | | | | |
 | | | | | | | |

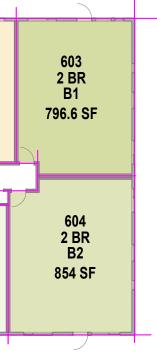




This drawing is an instrument of service and the property of Shift Architecture Inc. and shall remain their property. The

T 604.988.7501 | shiftarchitecture.ca


use of this drawing shall be restricted to the original site for which it was prepared and publication thereof is expressly limited to such use. Reuse, reproduction or publication by any method in whole or in part is prohibited without their written consent.

No.	Date	Revision Notes
Α	26/01/22	ISSUED FOR RZ/DP
No.	Date	Revision Notes



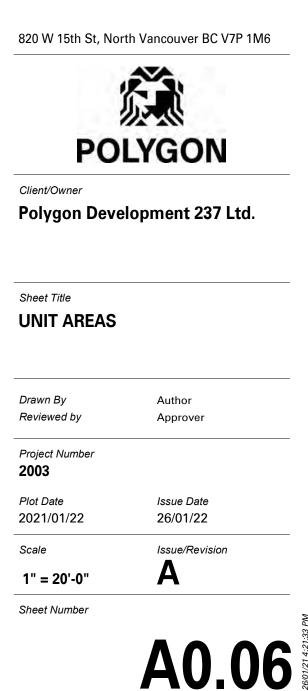



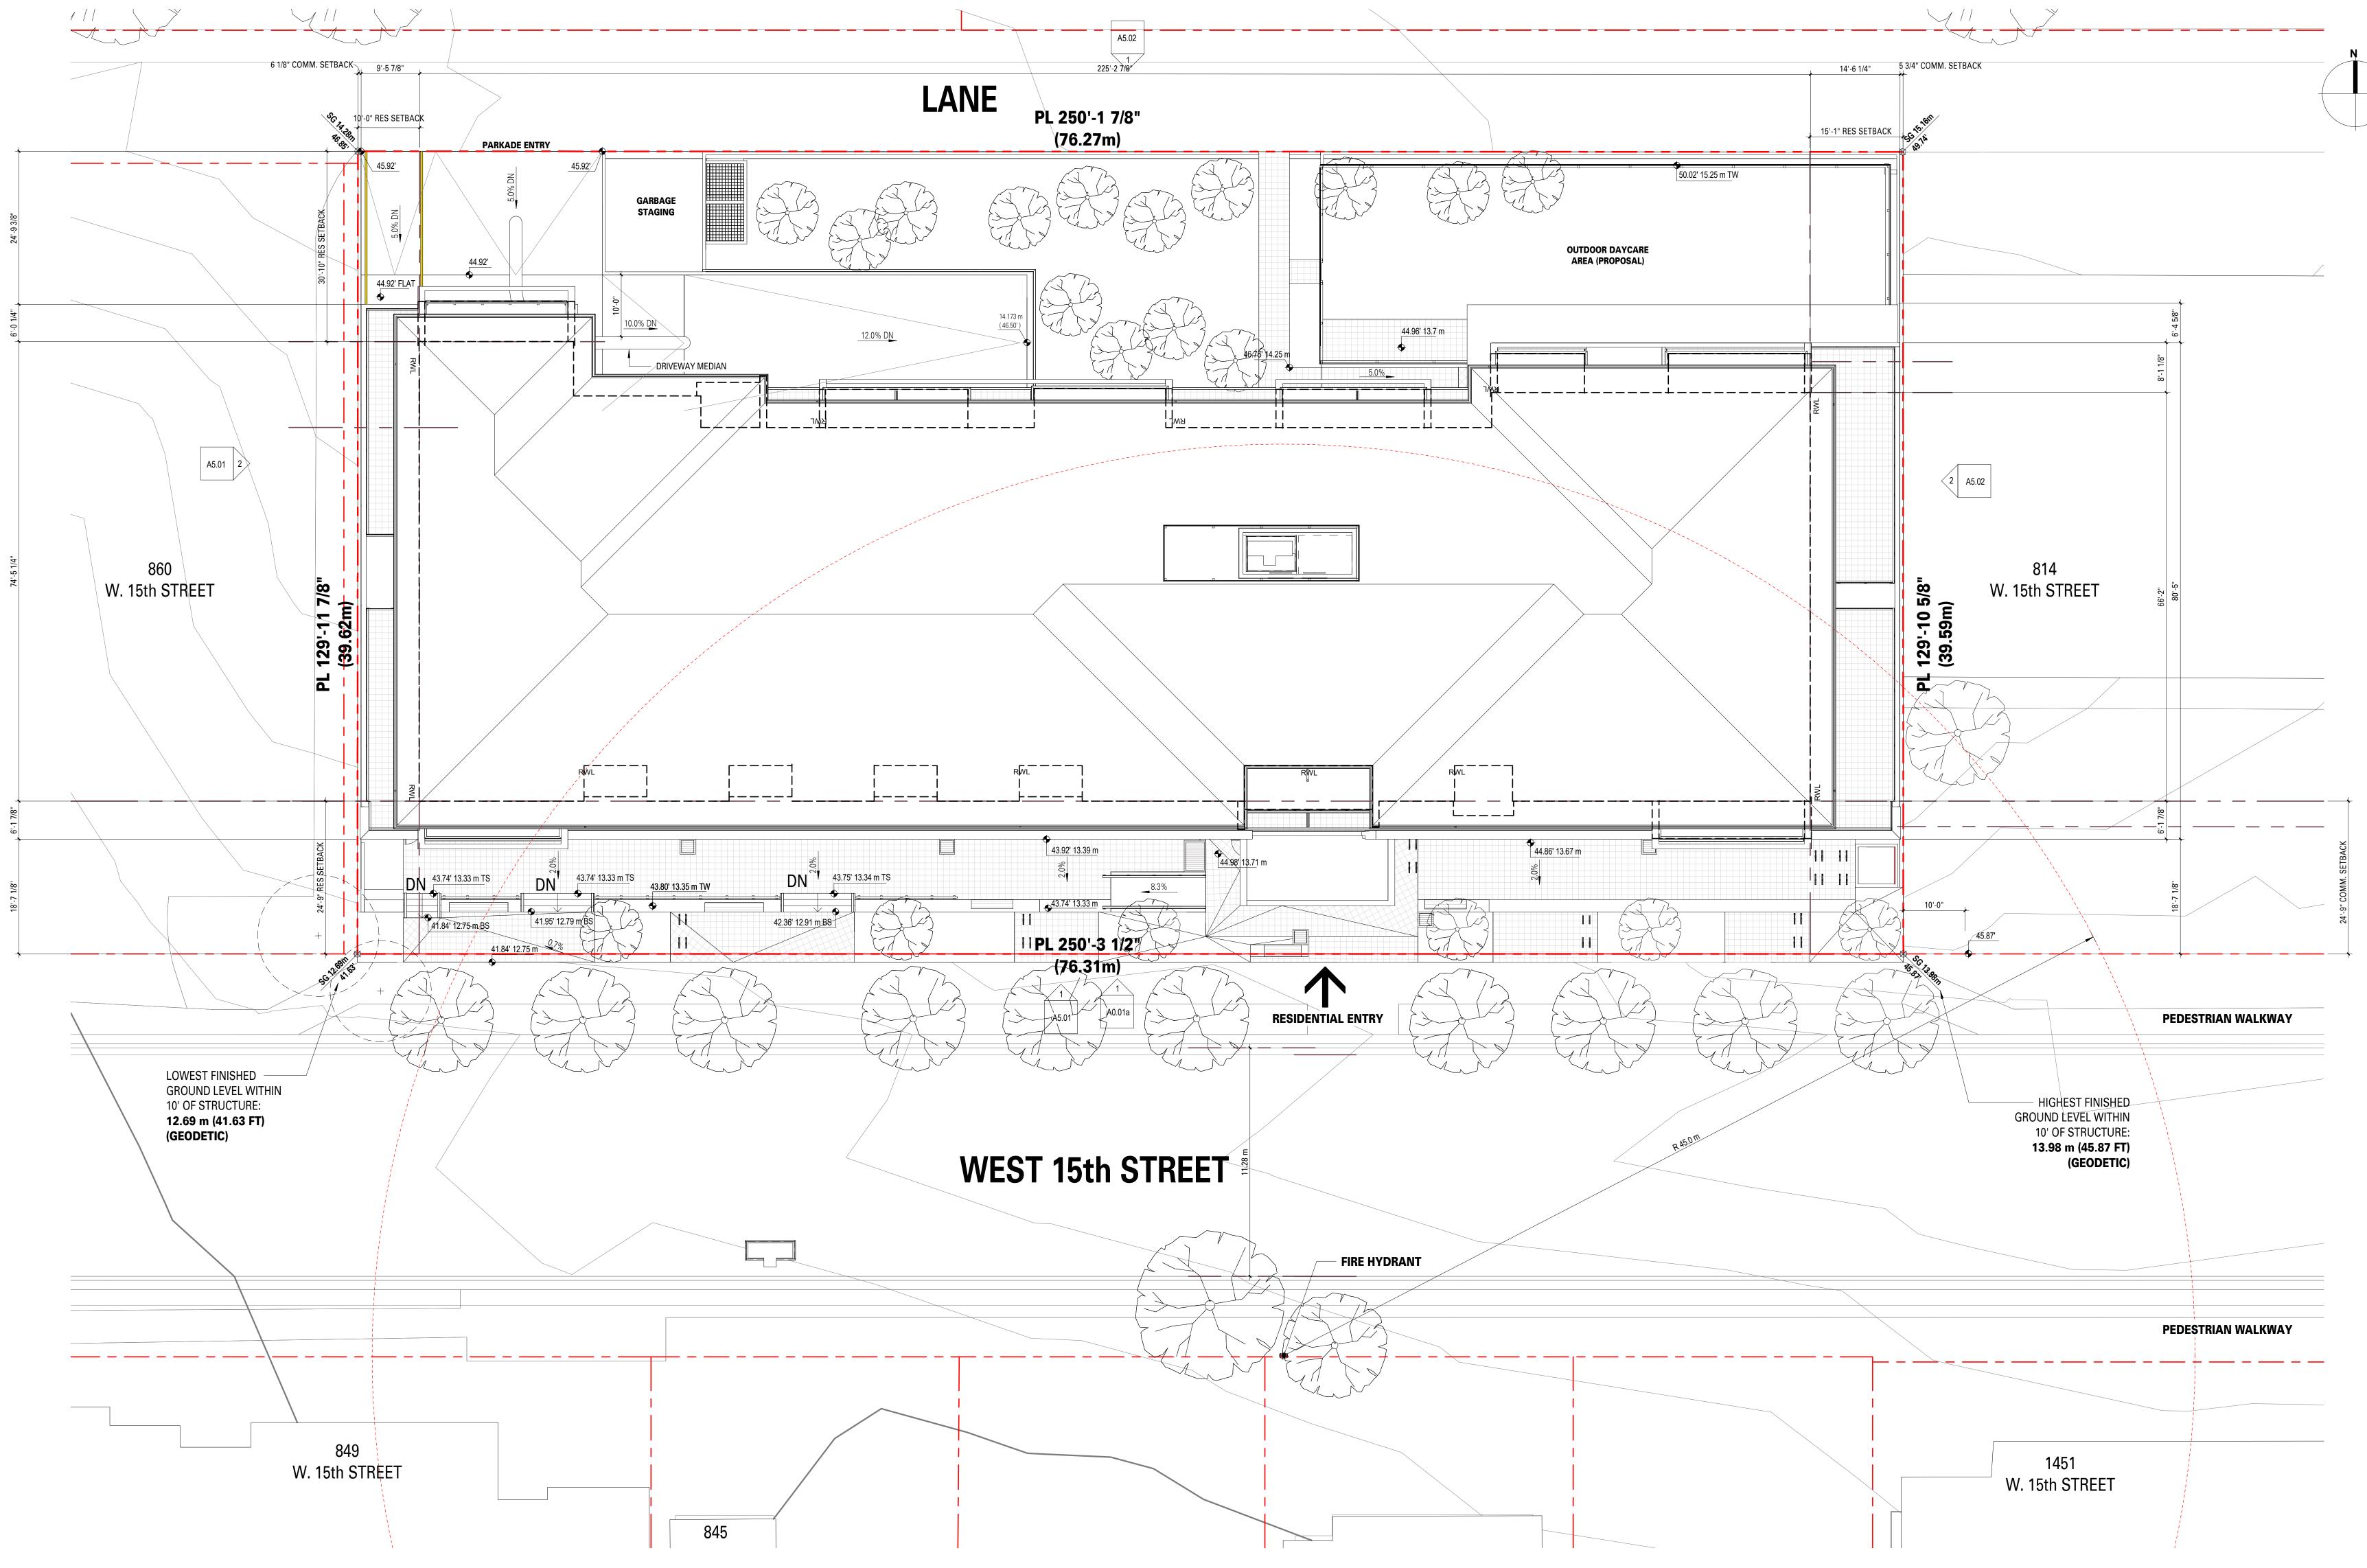



This drawing is an instrument of service and the property of Shift Architecture Inc. and shall remain their property. The use of this drawing shall be restricted to the original site for which it was prepared and publication thereof is expressly limited to such use. Reuse, reproduction or publication by any method in whole or in part is prohibited without their written consent.


No.	Date	Revision Notes
	0.0101/00	
Α	26/01/22	ISSUED FOR RZ/DP
No.	Date	Revision Notes









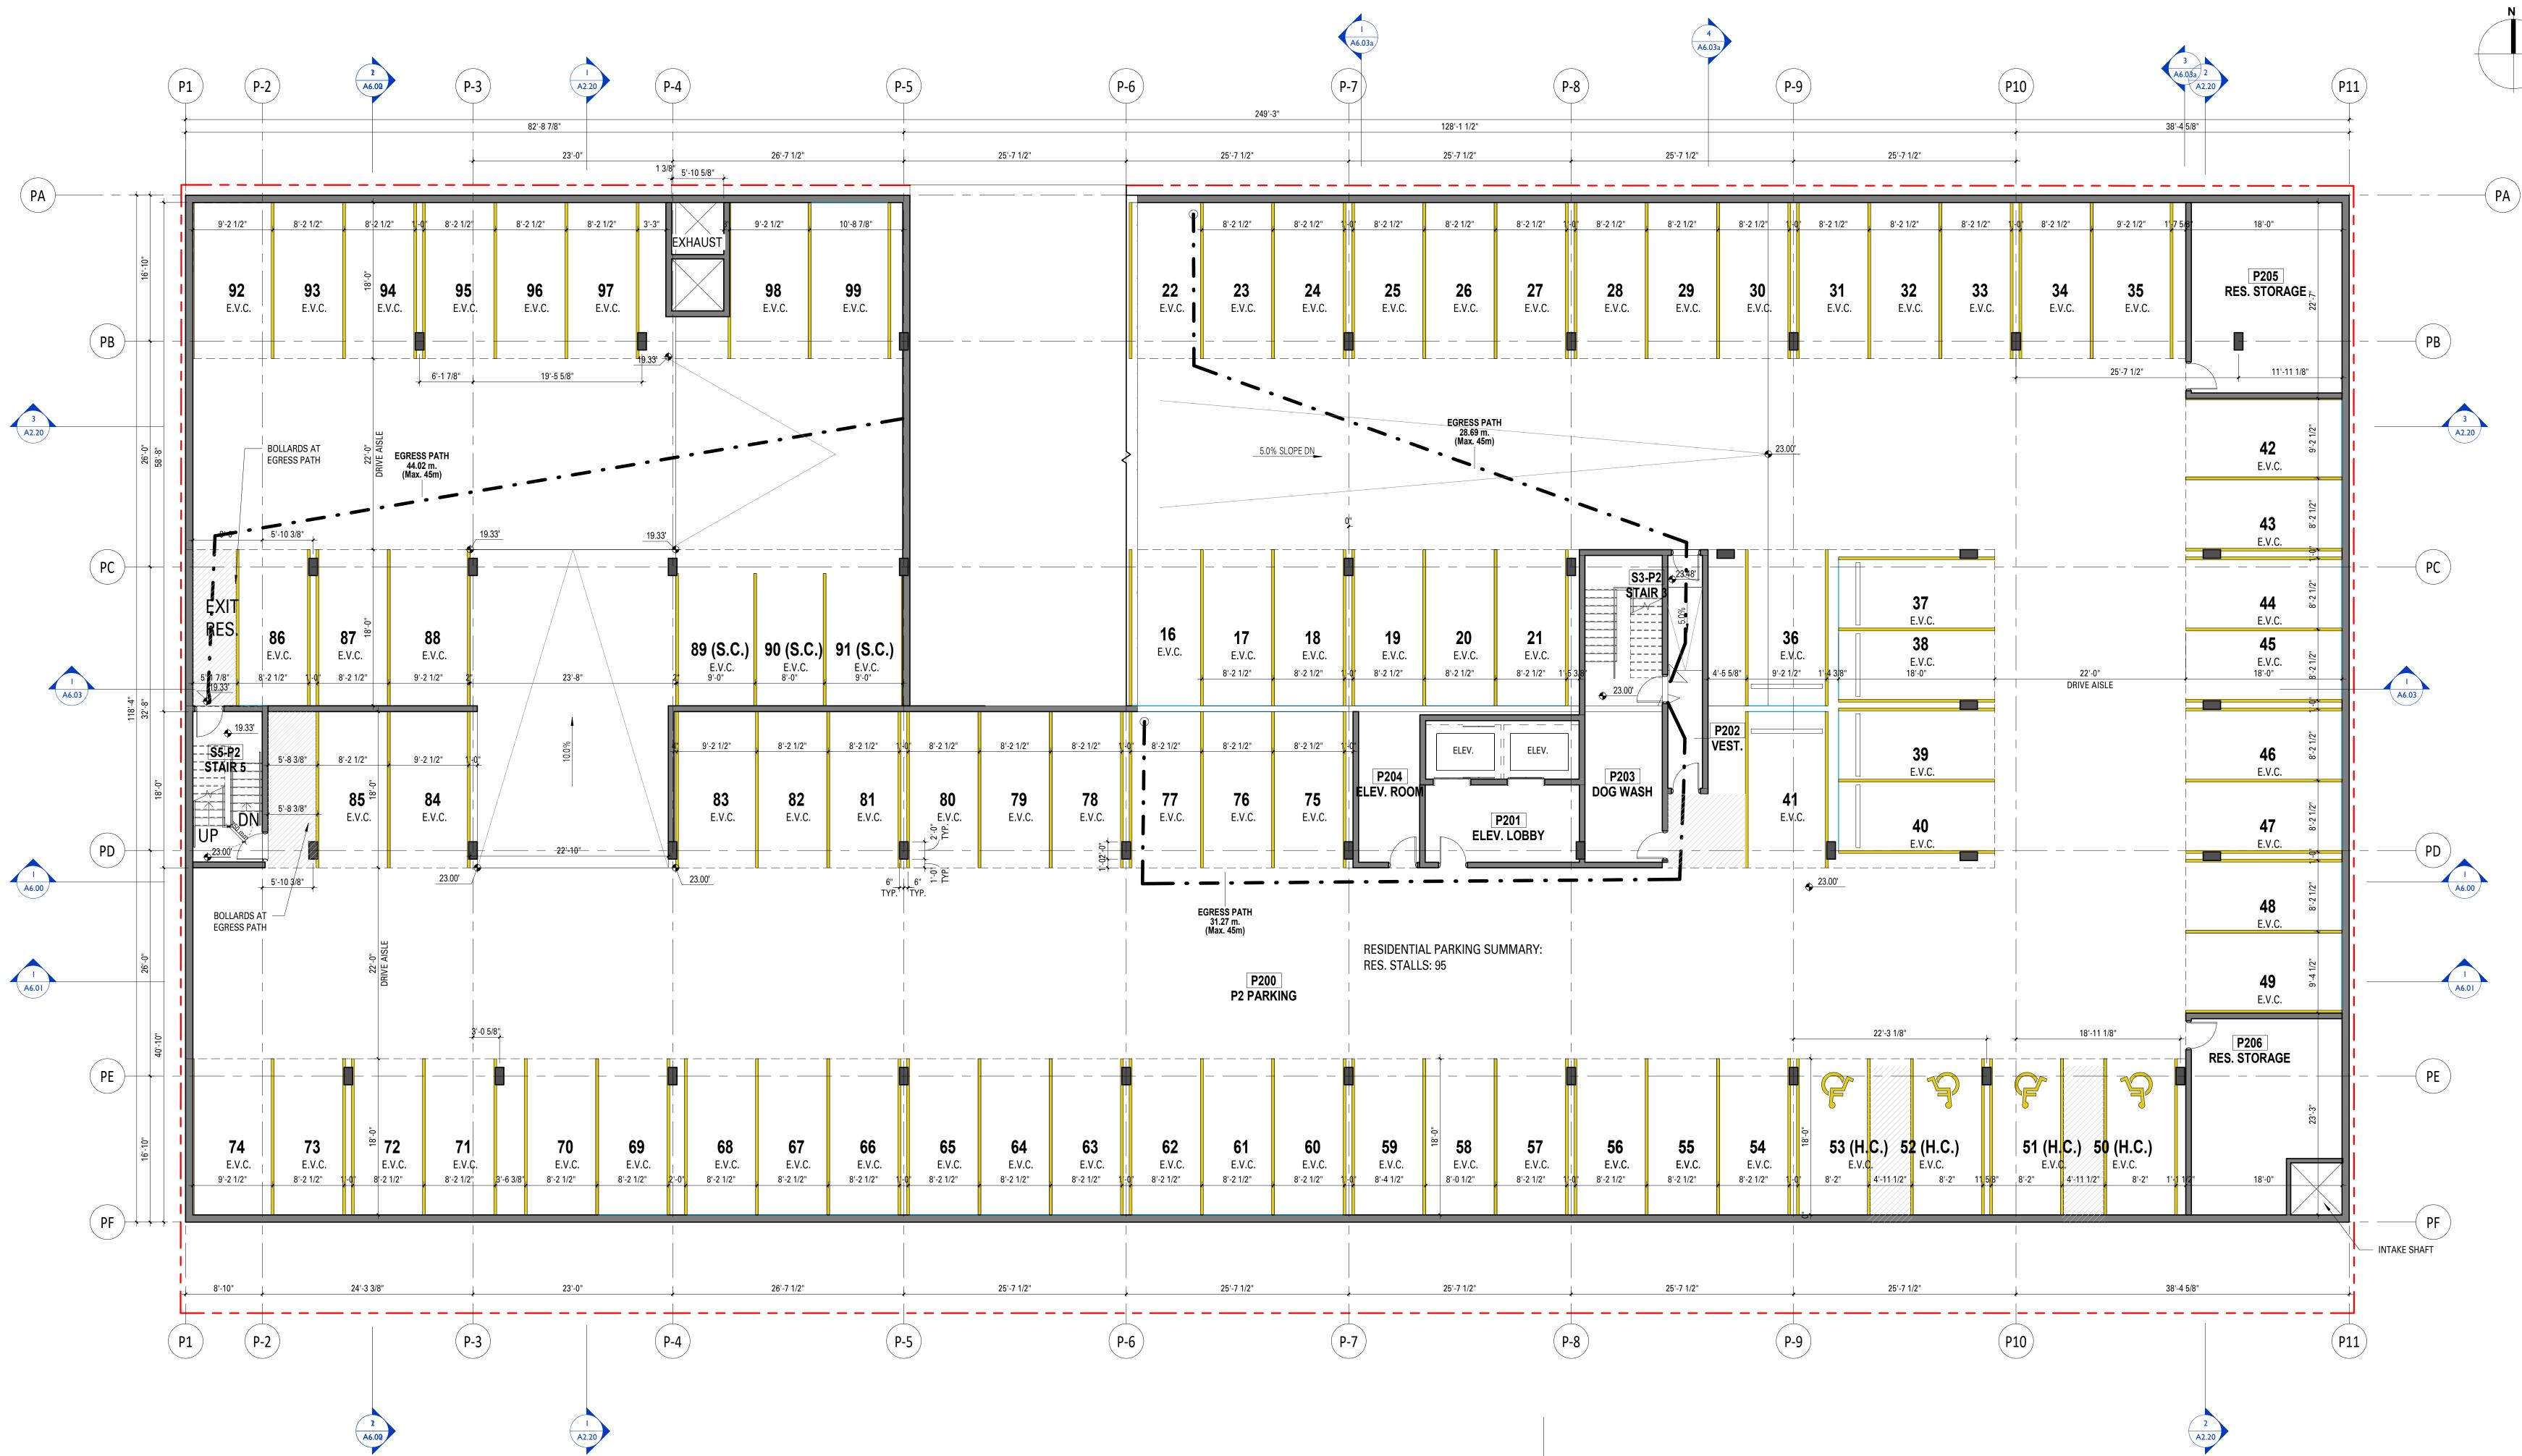

2 A6.03a



North Vancouver, BC V7P 3J6 T 604.988.7501 | shiftarchitecture.ca


This drawing is an instrument of service and the property of Shift Architecture Inc. and shall remain their property. The use of this drawing shall be restricted to the original site for which it was prepared and publication thereof is expressly limited to such use. Reuse, reproduction or publication by any method in whole or in part is prohibited without their written consent.

No.	Date	Revision Notes
	0.0101/00	
Α	26/01/22	ISSUED FOR RZ/DP
No.	Date	Revision Notes







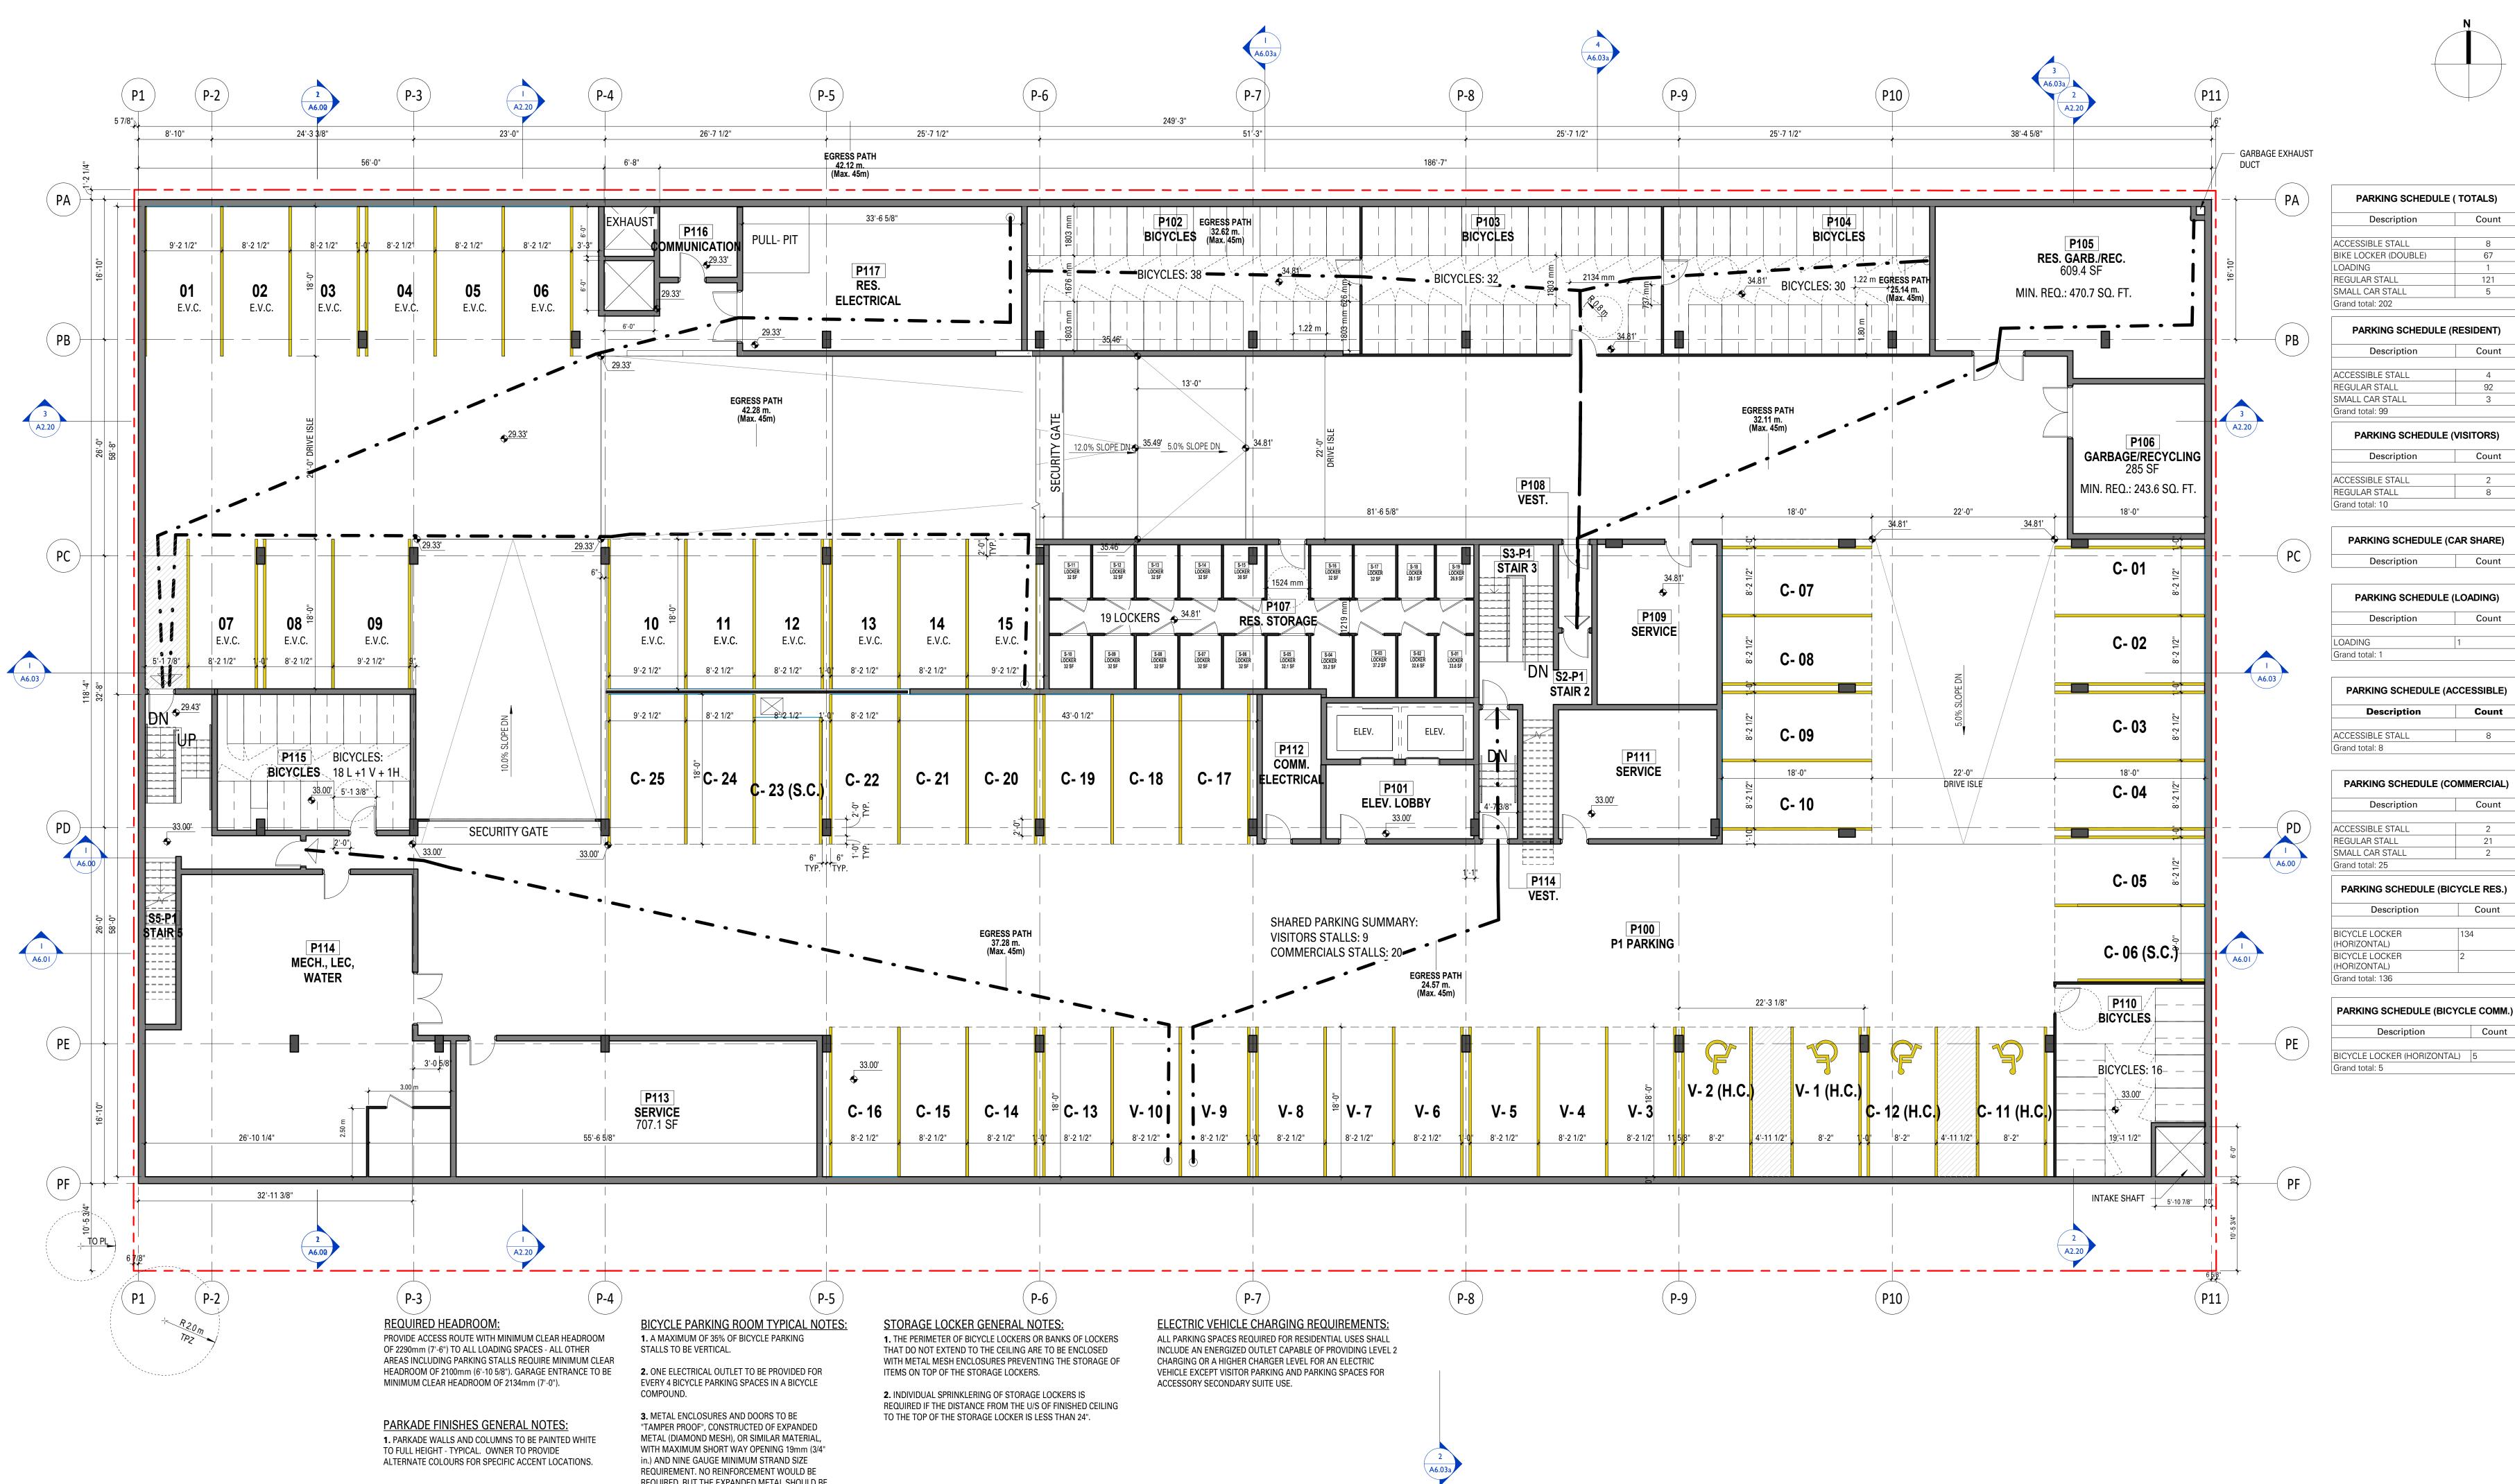

REQUIRED, BUT THE EXPANDED METAL SHOULD BE SECURELY WELDED TO A STEEL FRAME.

4. ALL BICYCLE STALLS TO HAVE MINIMUM CLEAR HEADROOM OF 2500mm (8'-2 3/8").



_S)
ount
8
67
1
21
5

ount	
4	
92	
-	

3	
RS)	

ount	
2	



Count

Count

Count

Count

Count




200,1000 West 3rd Street North Vancouver, BC V7P 3J6 T 604.988.7501 | shiftarchitecture.ca

This drawing is an instrument of service and the property of Shift Architecture Inc. and shall remain their property. The use of this drawing shall be restricted to the original site for which it was prepared and publication thereof is expressly limited to such use. Reuse, reproduction or publication by any method in whole or in part is prohibited without their written consent.

No.	Date	Revision Notes
А	26/01/22	ISSUED FOR RZ/DP
No.	Date	Revision Notes



820 W 15th St, North Vancouver BC V7P 1M6 沙漠 POLYGON Client/Owner Polygon Development 237 Ltd. Sheet Title LEVEL P1 PLAN Drawn By Author Reviewed by Approver Project Number 2003 Plot Date Issue Date 2021/01/22 26/01/22 Scale Issue/Revision 1/8" = 1'-0" Sheet Number

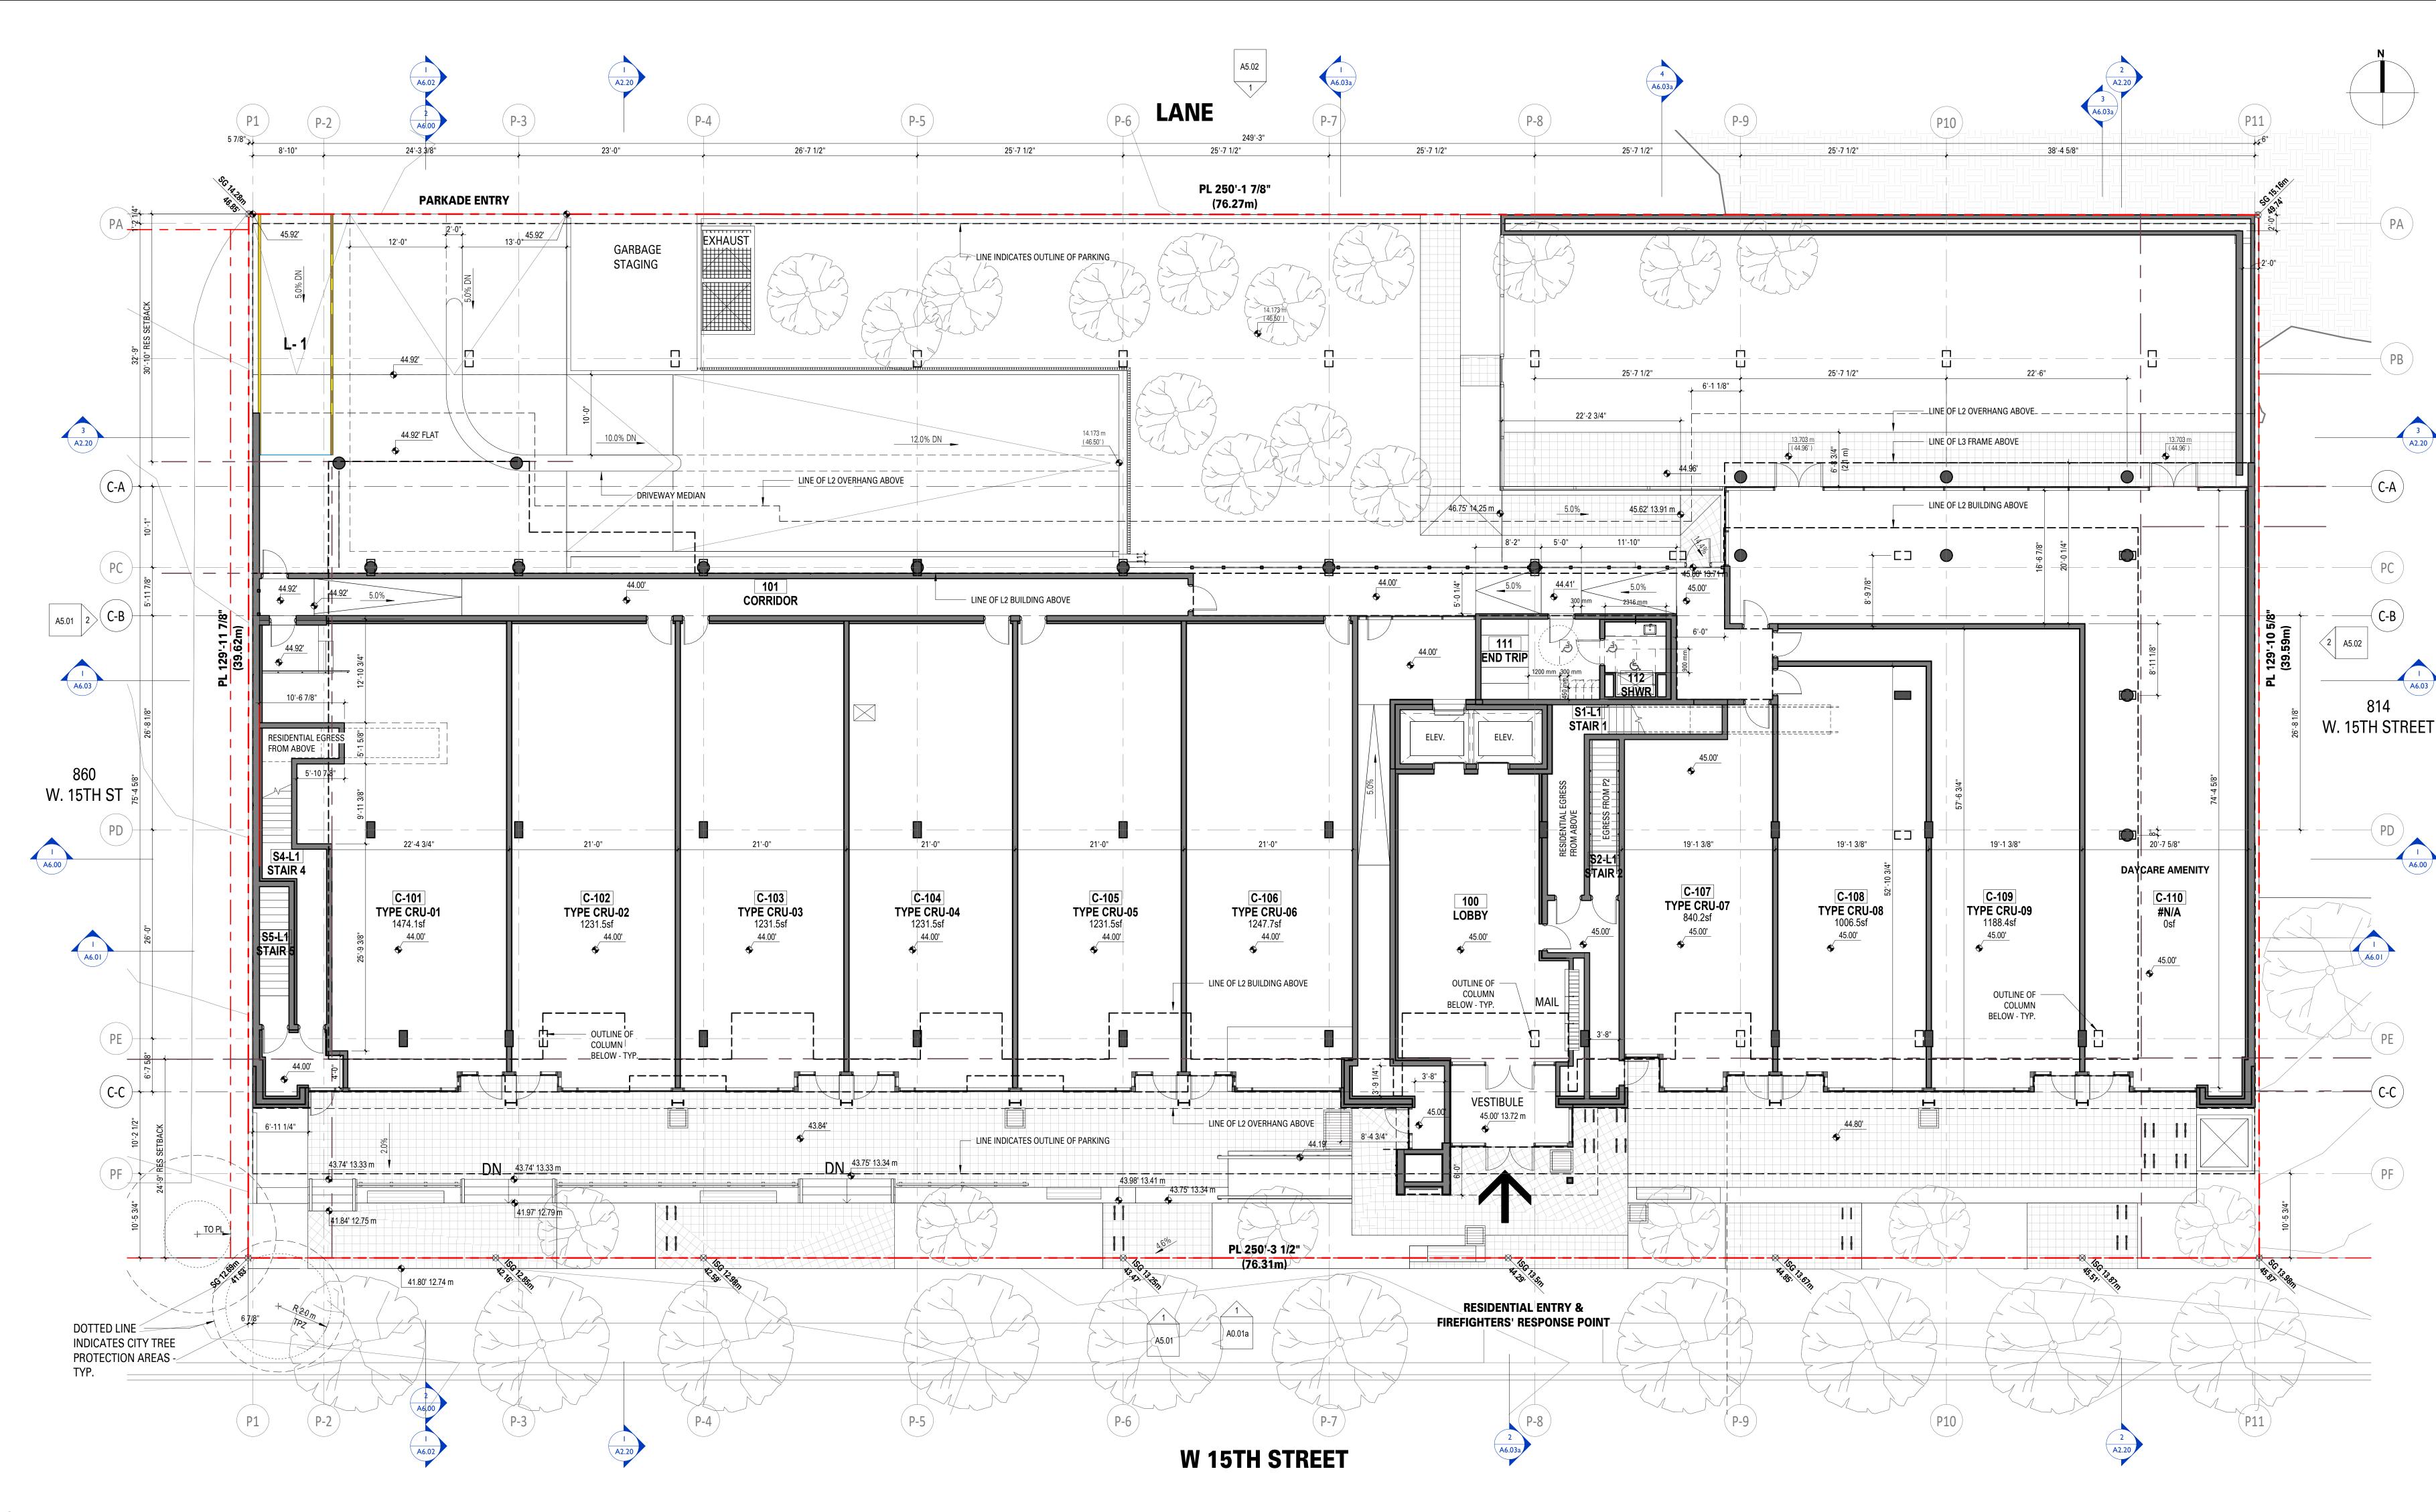




This drawing is an instrument of service and the property of Shift Architecture Inc. and shall remain their property. The use of this drawing shall be restricted to the original site for which it was prepared and publication thereof is expressly limited to such use. Reuse, reproduction or publication by any method in whole or in part is prohibited without their written consent.


No.	Date	Revision Notes
A	26/01/22	ISSUED FOR RZ/DP
No.	Date	Revision Notes





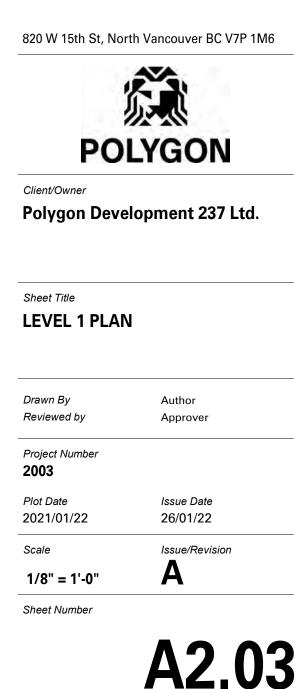

26/01/21 4:21:52 PM

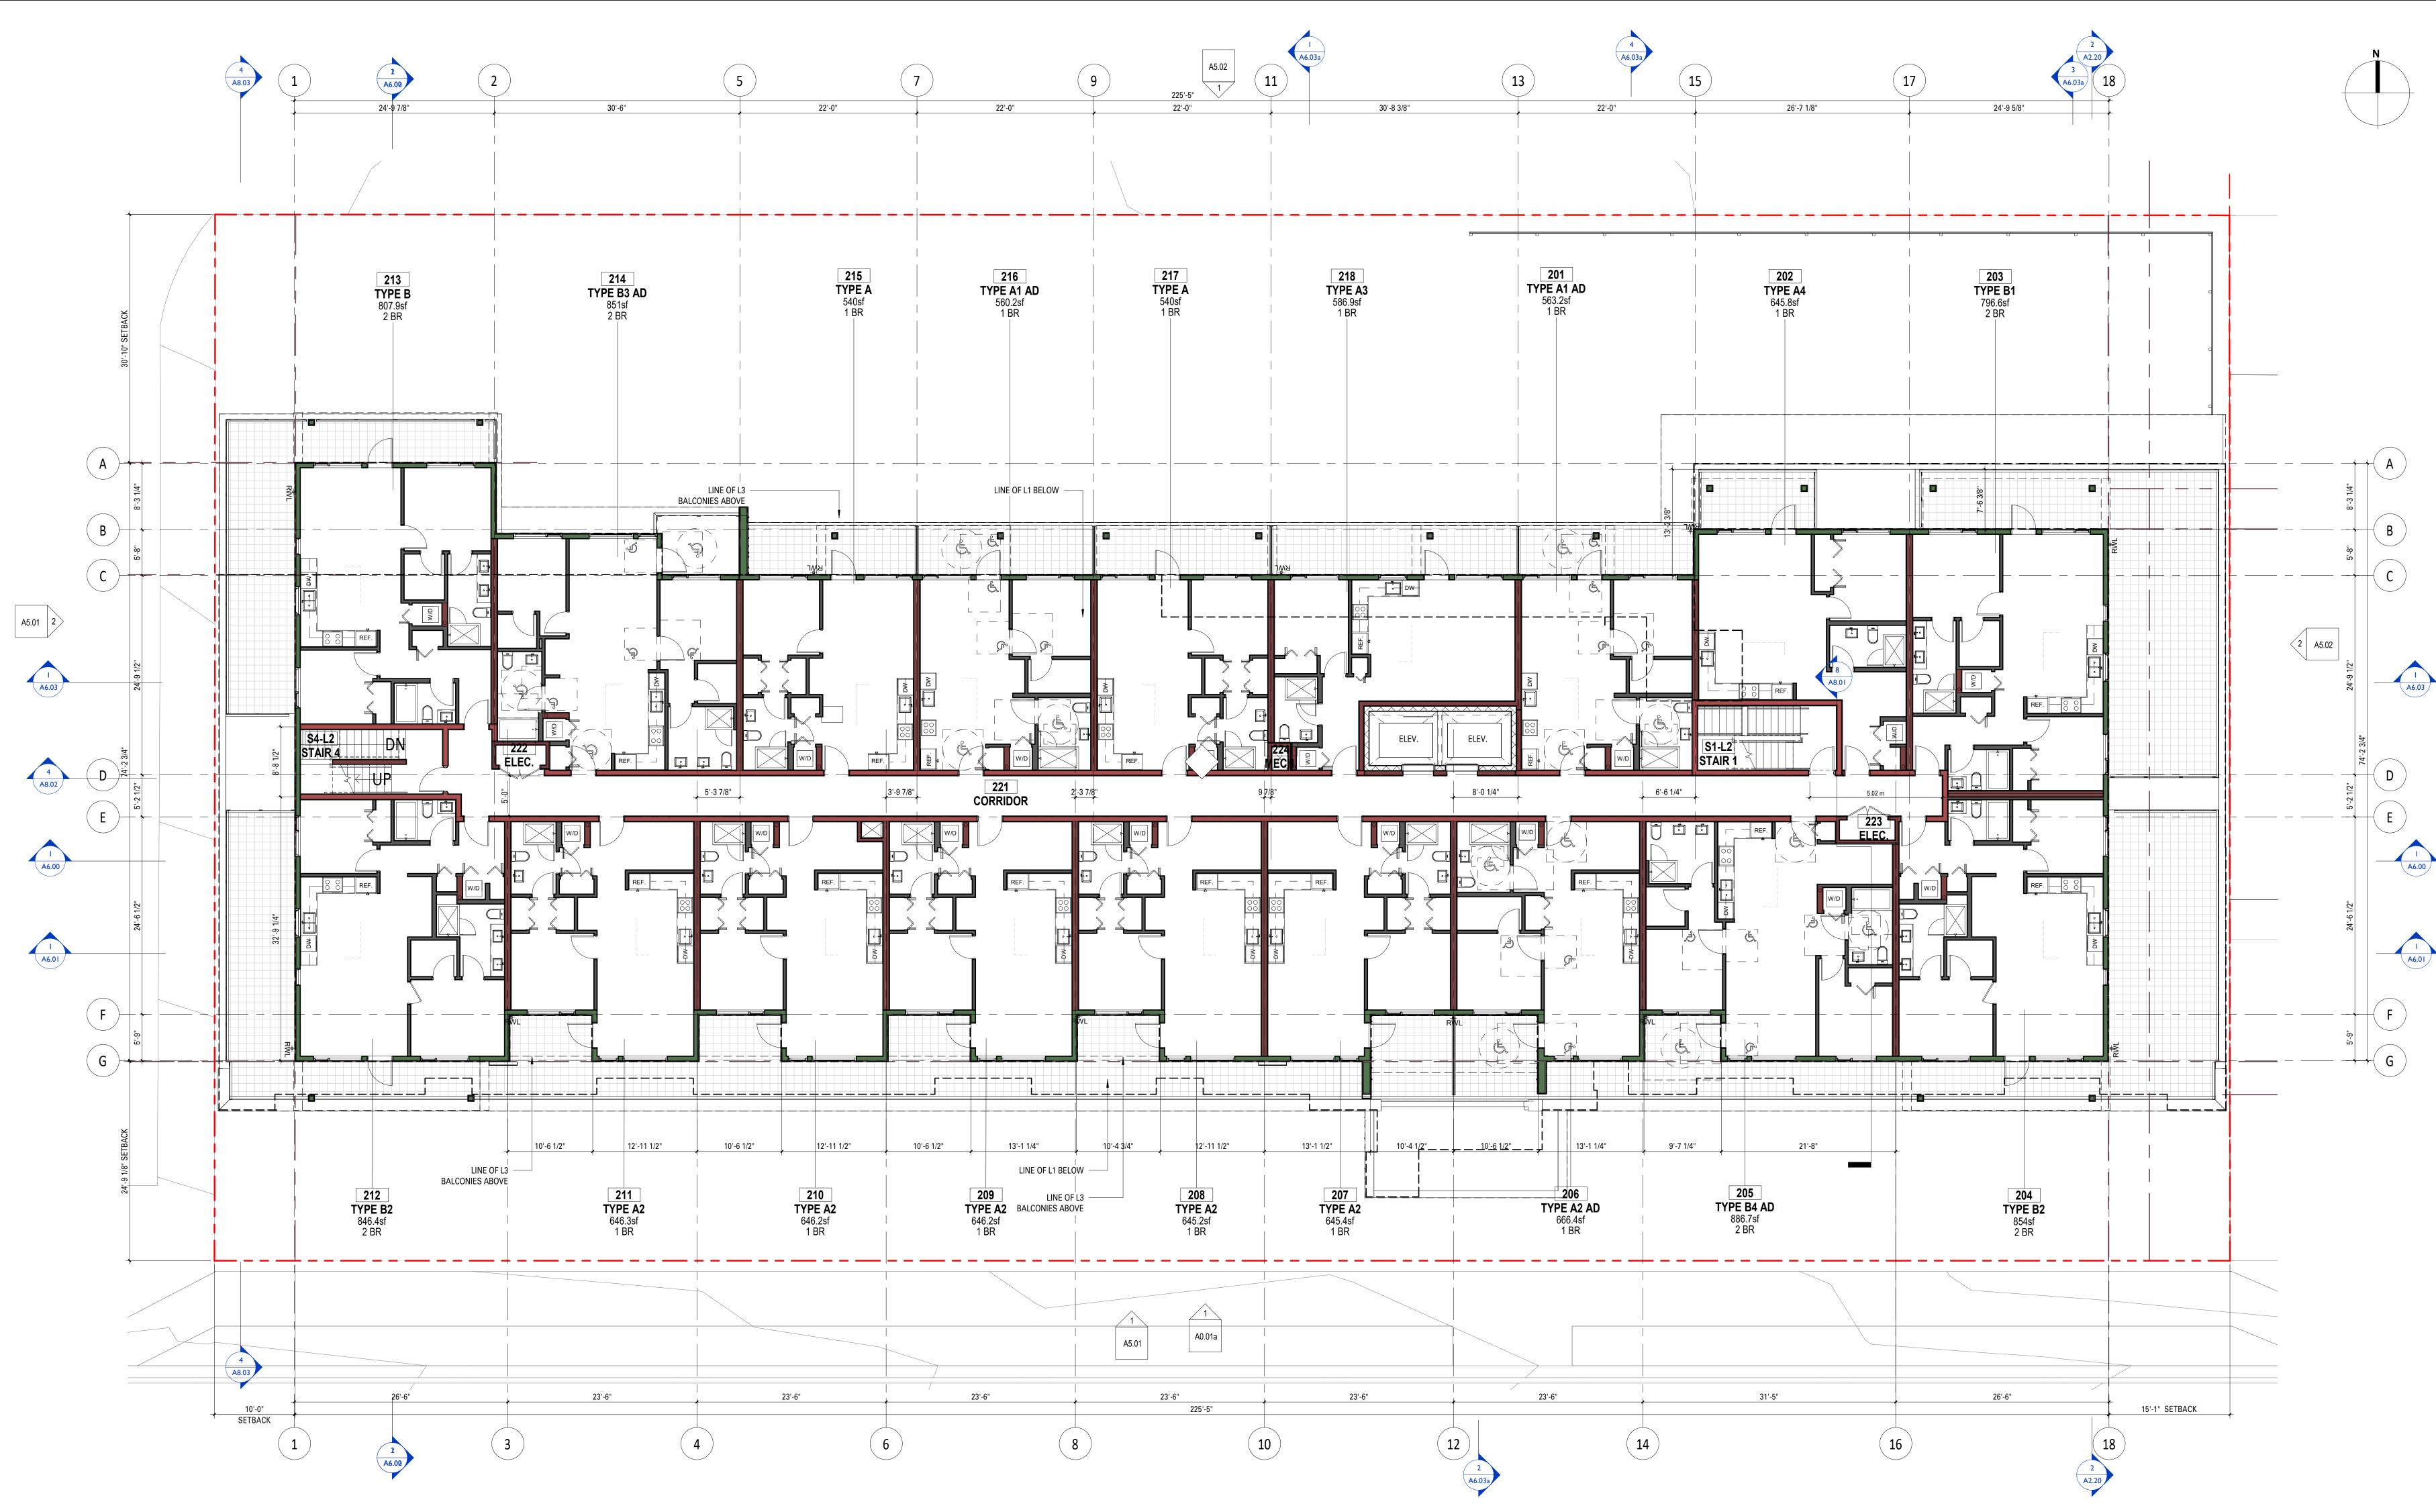




This drawing is an instrument of service and the property of Shift Architecture Inc. and shall remain their property. The use of this drawing shall be restricted to the original site for which it was prepared and publication thereof is expressly limited to such use. Reuse, reproduction or publication by any method in whole or in part is prohibited without their written consent.

No.	Date	Revision Notes
А	26/01/22	ISSUED FOR RZ/DP
No.	Date	Revision Notes





820 W 15th St, North Vancouver BC V7P 1M6 派派 POLYGON Client/Owner Polygon Development 237 Ltd. Sheet Title LEVEL 2 PLAN Drawn By Reviewed by Approver Project Number **2003** Plot Date Issue Date 2021/01/22 26/01/22 Scale Issue/Revision 1/8" = 1'-0" Α Sheet Number .04

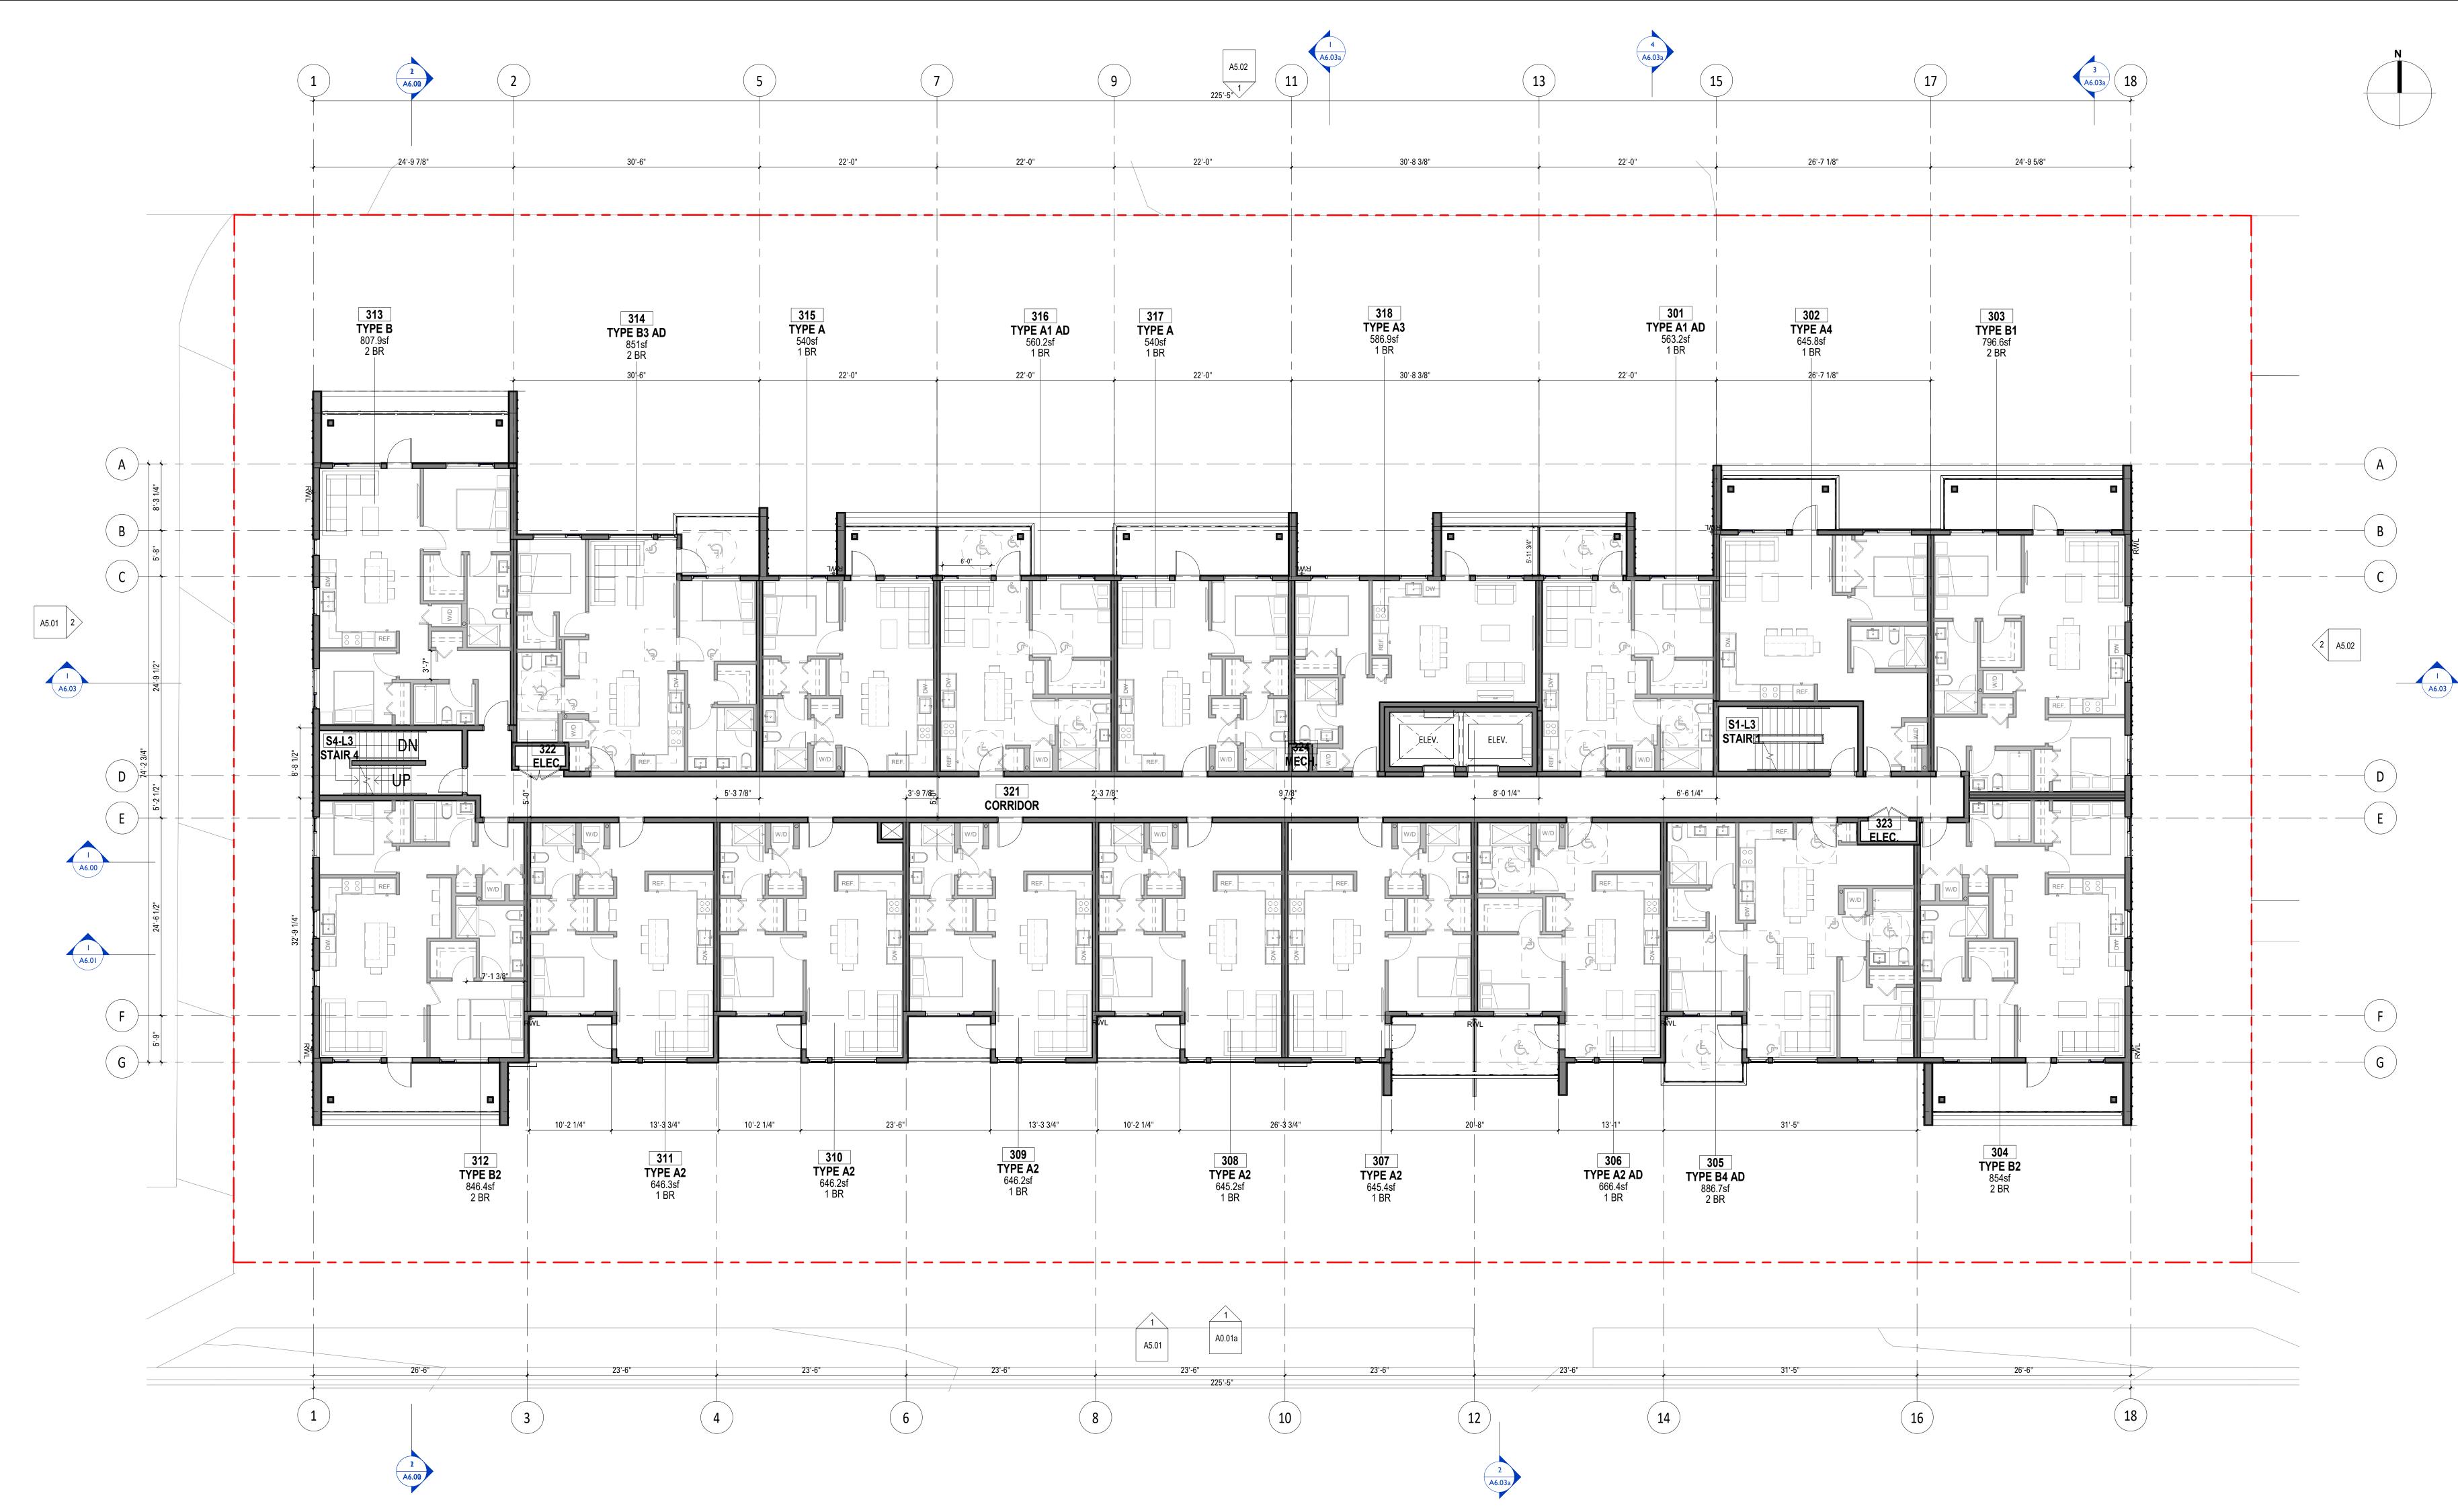




This drawing is an instrument of service and the property of Shift Architecture Inc. and shall remain their property. The use of this drawing shall be restricted to the original site for which it was prepared and publication thereof is expressly limited to such use. Reuse, reproduction or publication by any method in whole or in part is prohibited without their written consent.


No.	Date	Revision Notes
A	26/01/22	ISSUED FOR RZ/DP
No.	Date	Revision Notes





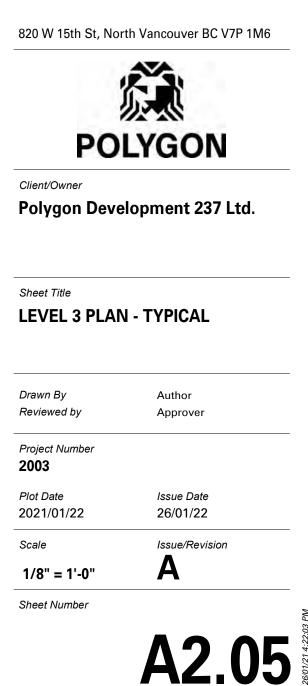



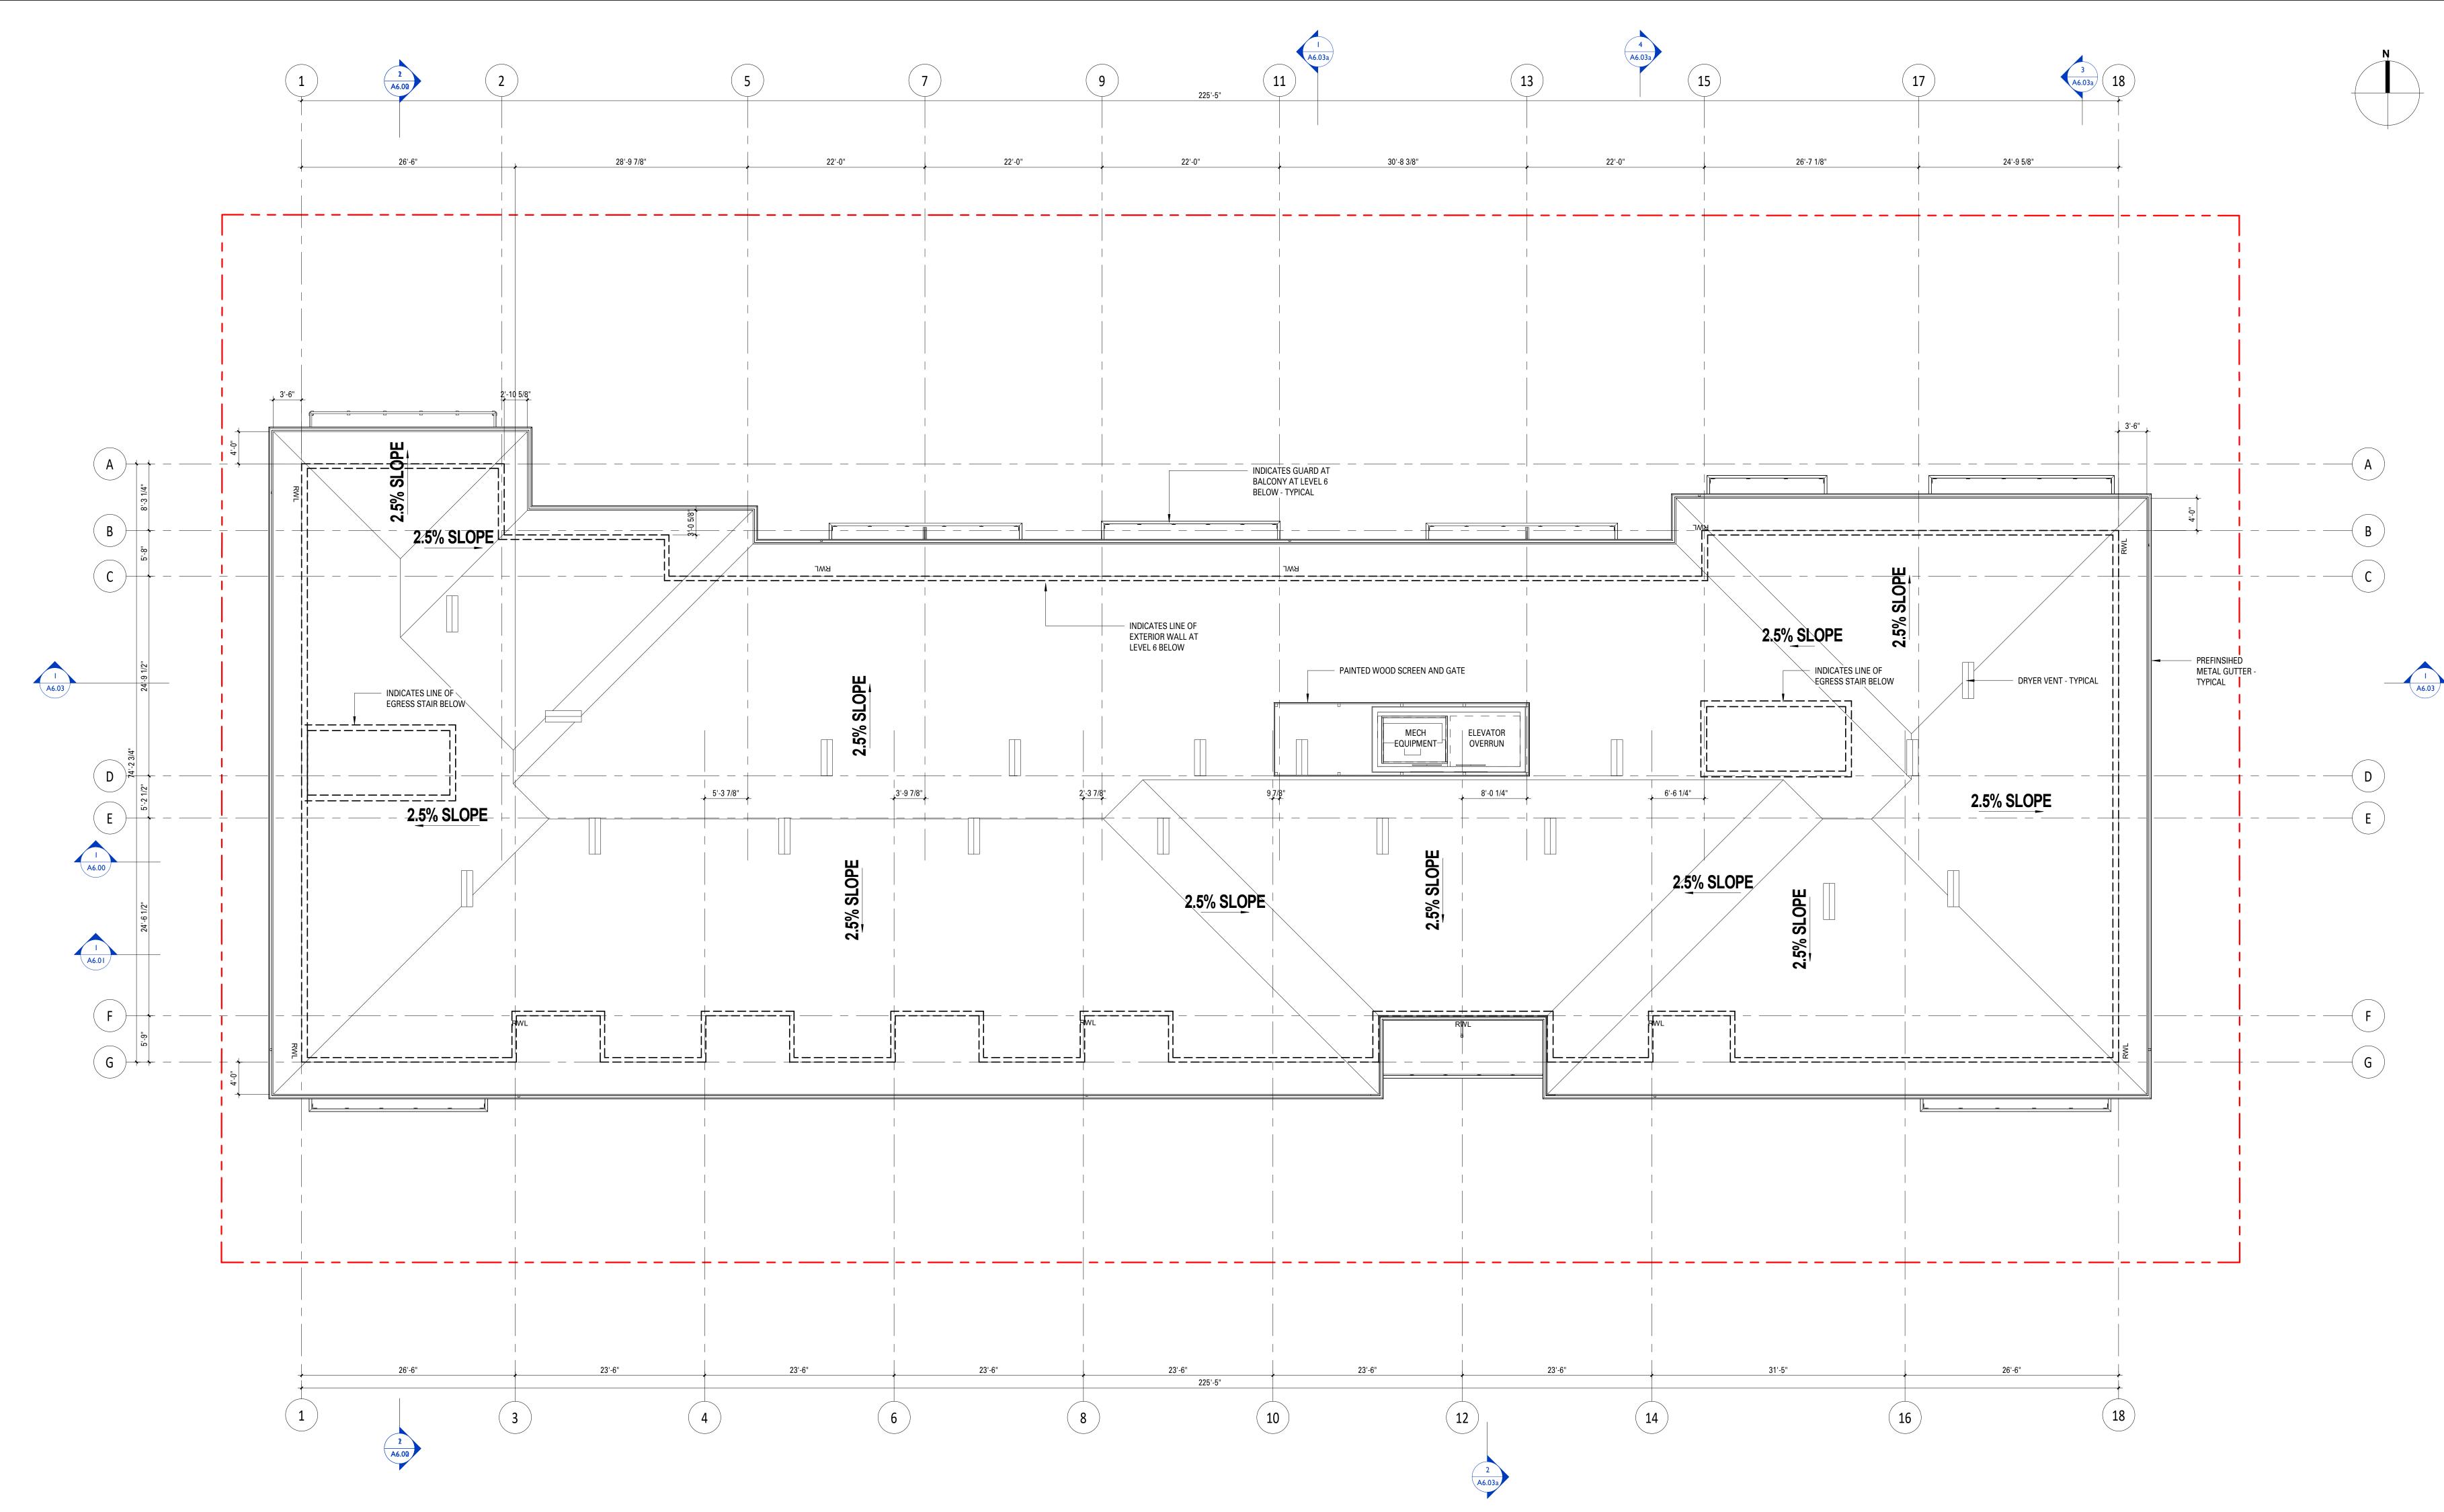




This drawing is an instrument of service and the property of Shift Architecture Inc. and shall remain their property. The use of this drawing shall be restricted to the original site for which it was prepared and publication thereof is expressly limited to such use. Reuse, reproduction or publication by any method in whole or in part is prohibited without their written consent.


No.	Date	Revision Notes
A	26/01/22	ISSUED FOR RZ/DP
No.	Date	Revision Notes





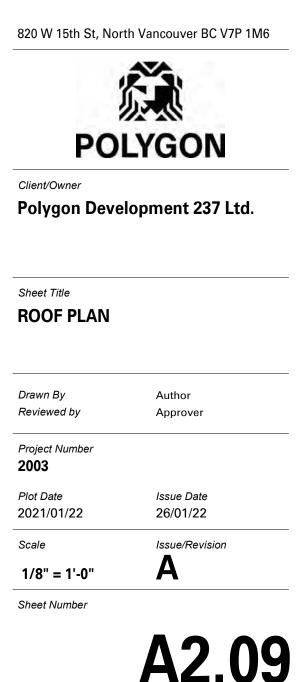



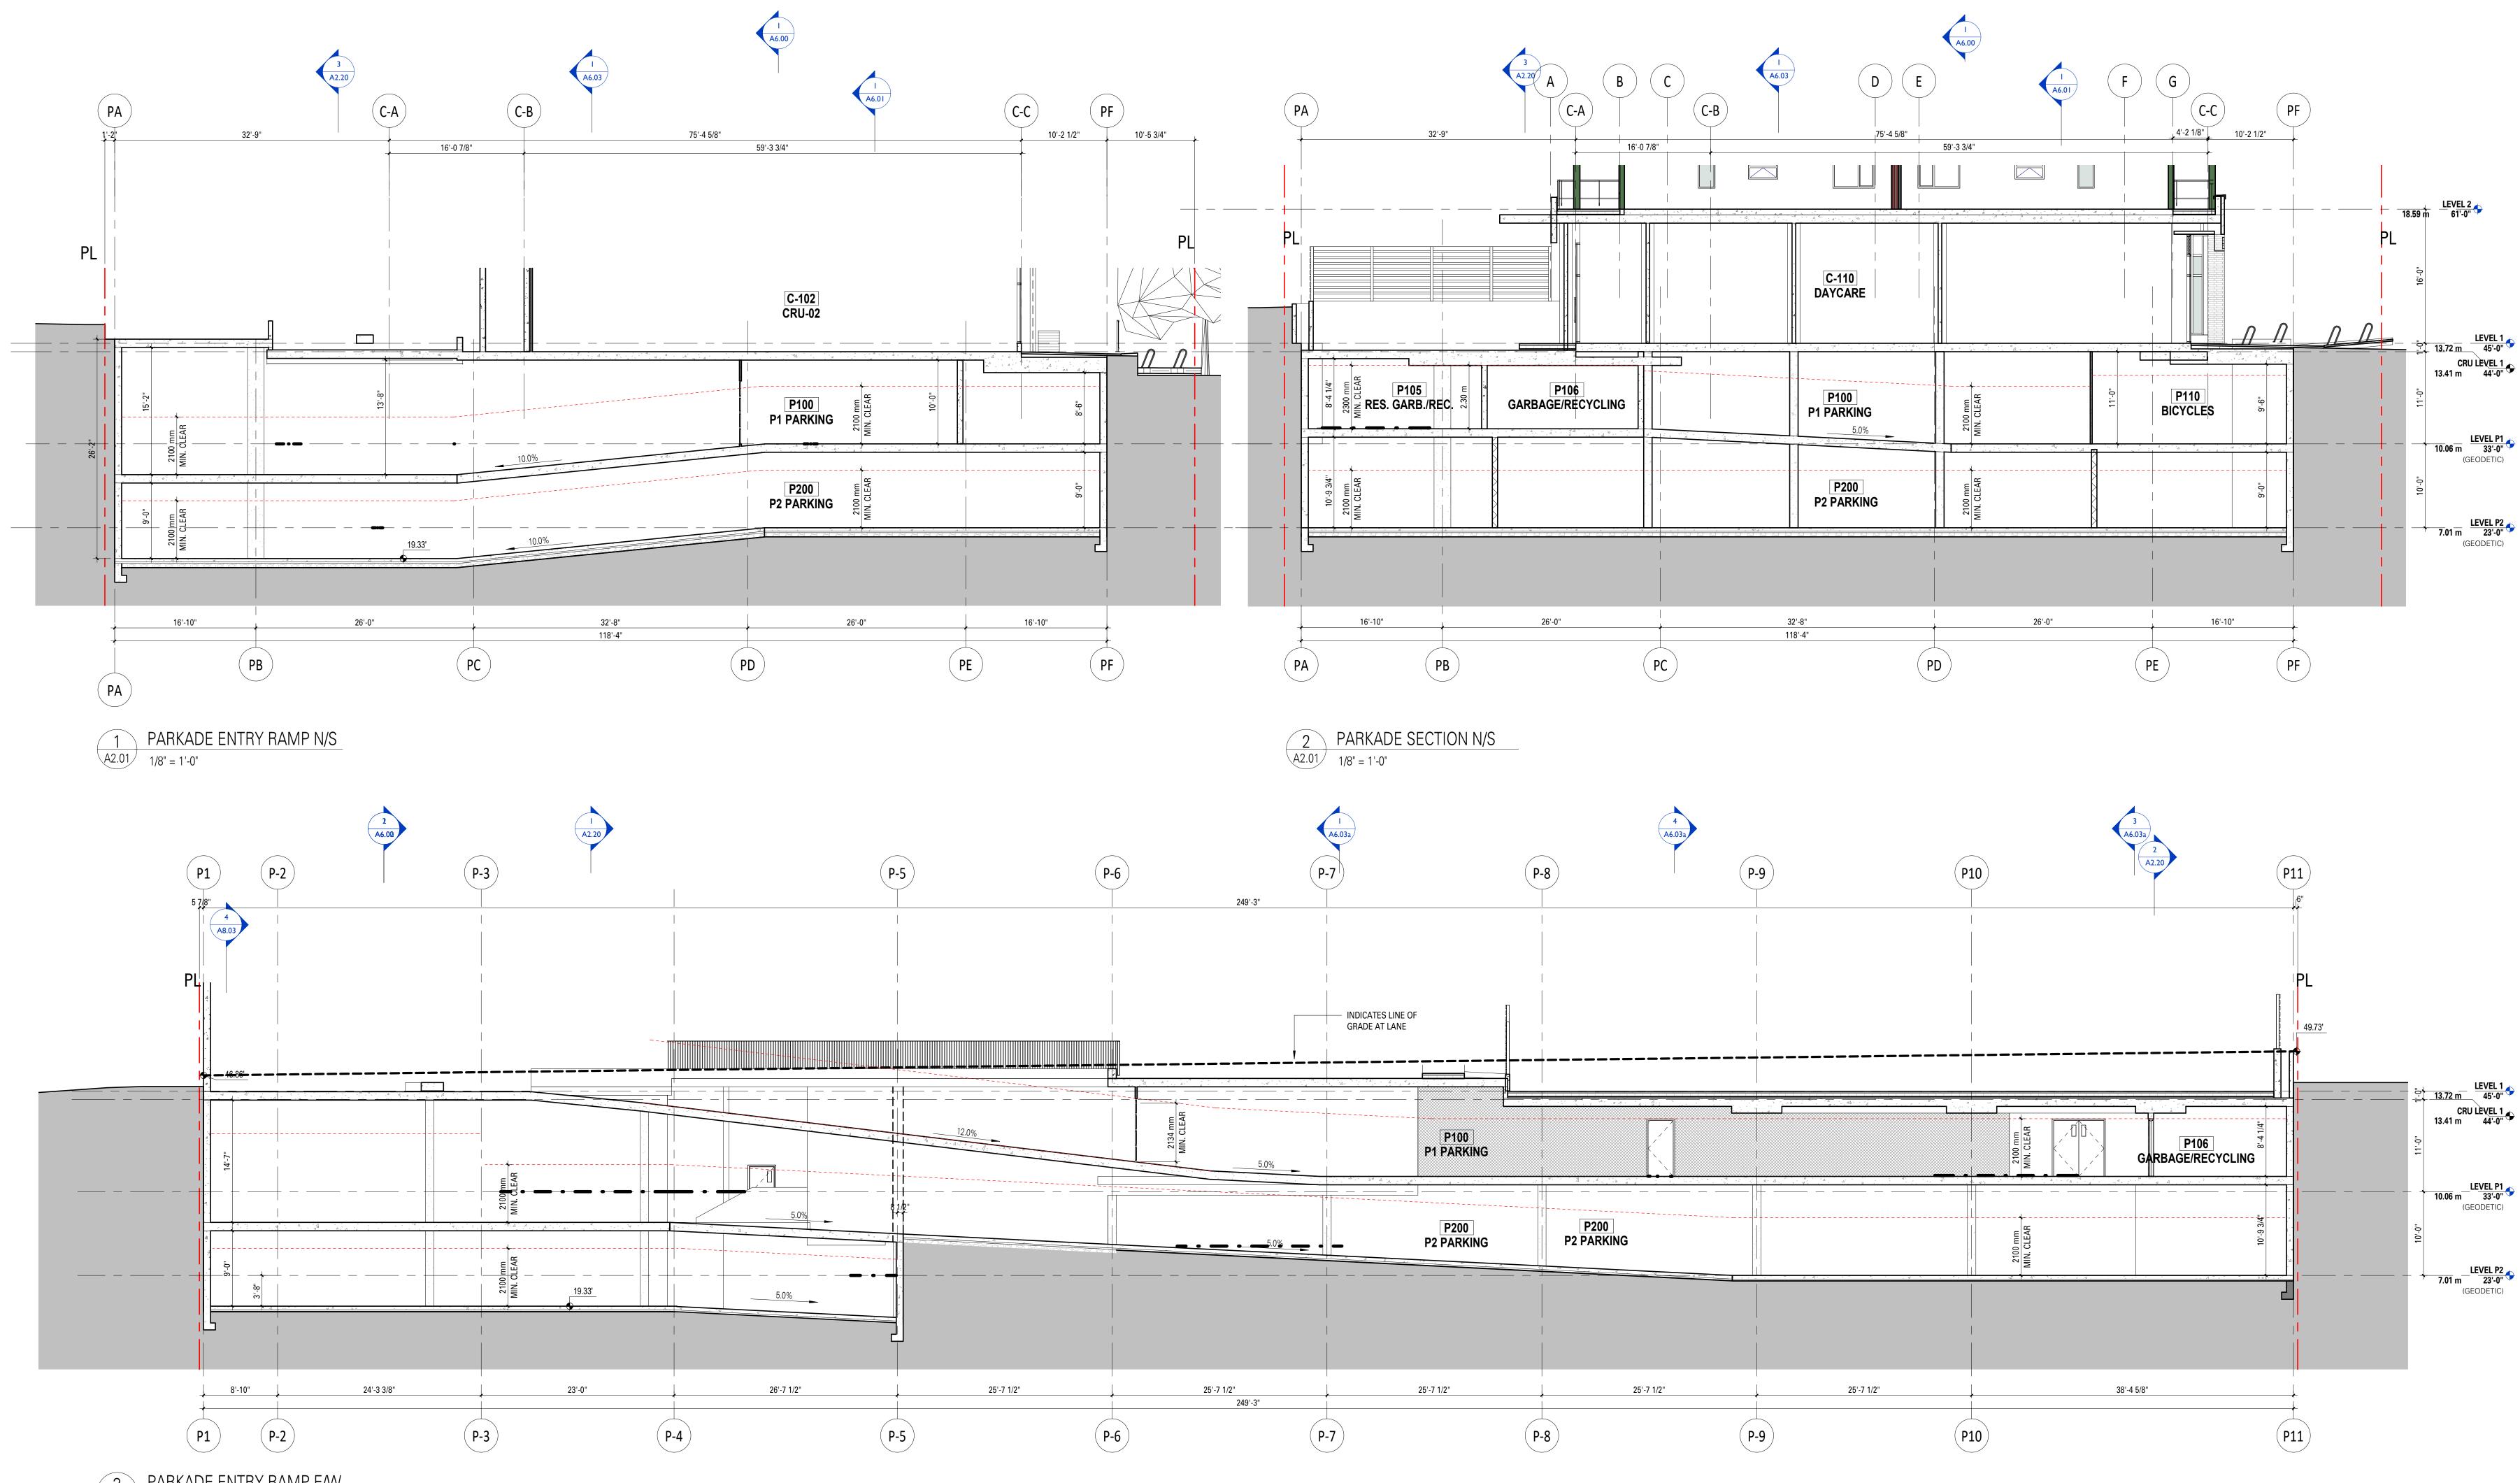

3 PARKADE ENTRY RAMP E/W A2.01 1/8" = 1'-0"



200,1000 West 3rd Street North Vancouver, BC V7P 3J6 **T** 604.988.7501 | shiftarchitecture.ca

This drawing is an instrument of service and the property of Shift Architecture Inc. and shall remain their property. The use of this drawing shall be restricted to the original site for which it was prepared and publication thereof is expressly limited to such use. Reuse, reproduction or publication by any method in whole or in part is prohibited without their written consent.

No.	Date	Revision Notes

А	26/01/22	ISSUED FOR RZ/DP
No.	Date	Revision Notes

ſ 22 0



Client/Owner Polygon Development 237 Ltd.

Sheet Title PARKING SECTIONS

820 W 15th St, North Vancouver BC V7P 1M6

派派

POLYGON

Drawn By Reviewed by Project Number

2003 Plot Date 2021/01/22 Scale 1/8" = 1'-0" Sheet Number

LC Approver

Issue Date 26/01/22

Issue/Revision A







ITEM	MATERIAL
CL-01	STANDING SEAM METAL PANEL CLADDING C/W FLASHINGS - SHERWIN WILLIAMS 'PEPPERCORN - 7674' - REGENT GREY
CL-02	CORRUGATED METAL SIDING- SHERWIN WILLIAMS 'WALL STREET- 7665' - CHARCOAL
CL-03	CEMENTITIOUS CLADDING PANEL - ARCHTIC WHITE
CL-04	CEMENTITIOUS CLADDING PANEL - NIGHT GRAY
CL-06	TONGUE & GROOVE CORRUGATED PVC PLANK SOFFIT & WALL - 'PINE ZEBRAWOOD'
CO-01	ARCHITECTURAL CONCRETE ELASTOMERIC PAINT - TO MATCH BM SEA HAZE- 2137-50
FIN-02	PAINTED METAL FASCIA TO MATCH STANDING SEAM CLADDING (CL-01)
FIN-03	PAINTED METAL GUTTER TO MATCH STANDING SEAM CLADDING (CL-01)
FIN-04	PAINTED METAL RWL TO MATCH STANDING SEAM CLADDING (CL-01)
MA-01	BRICK VENEER- NORMAN MODULE, 1/3 BOND - CLINKER MORA BLACK
MM-01	METAL SCREEN - SHERWIN WILLIAMS 'PEPPERCORN- 7674'
PS-01	PRIVACY SCREEN (ALUMINUM & TRANSLUCENT GLASS) - BM BENJAMIN MOORE 2129-10 MIDNIGHT DREAM
PS-02	PAINTED WOOD MECHANICAL SCREEN - NIGHT GRAY
RG-01	GUARDRAIL (ALUMINUM & GLASS) - POWDER COAT- BM 'BLACK PANTHER' 2125-10
RG-02	GUARDRAIL (ALUMINUM) - POWDER COAT- BM 'BLACK PANTHER' 2125-10


CL-01	CL-02	CL-03	CL-04	CL-05
QC 16072 CHARCOAL	QC 16082 REGENT GREY	SMOOTH ARCHTIC WHITE MM-01/ RG-01/	SMOOTH NIGHT GREY	SMOOTH GREY SLATE
CO-01	MA-01	RG-02/ RG-04/ TMP-03	RG-03	CL-06
ELASTOMERIC PAINT BM-SEA HAZE 2137-50	IXL MANGANSESE IRONSPOT	PAINTED TO MATCH SHERWIN WILLIAMS 'PEPPERCORN- 7674'	POWDER COAT TO MATCH BM 'DISTANT GREY' OC-068	'PINE ZEBRAWOOD'
TMP-01	TMP-02	TMP-04	VEN-01	


This drawing is an instrument of service and the property of Shift Architecture Inc. and shall remain their property. The use of this drawing shall be restricted to the original site for which it was prepared and publication thereof is expressly limited to such use. Reuse, reproduction or publication by any method in whole or in part is prohibited without their written consent.

No.	Date	Revision Notes
A	26/01/22	ISSUED FOR RZ/DP
No.	Date	Revision Notes


Р ED FOR RZ/ 1- ISS 202 RY JANU, 26



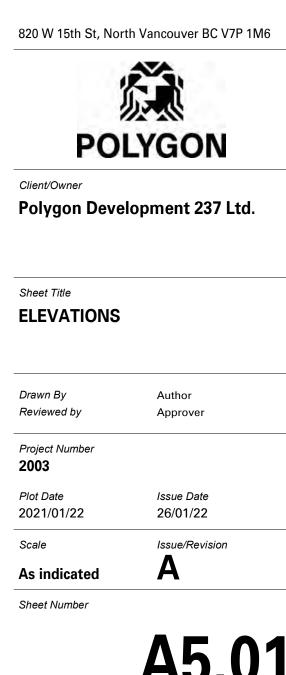

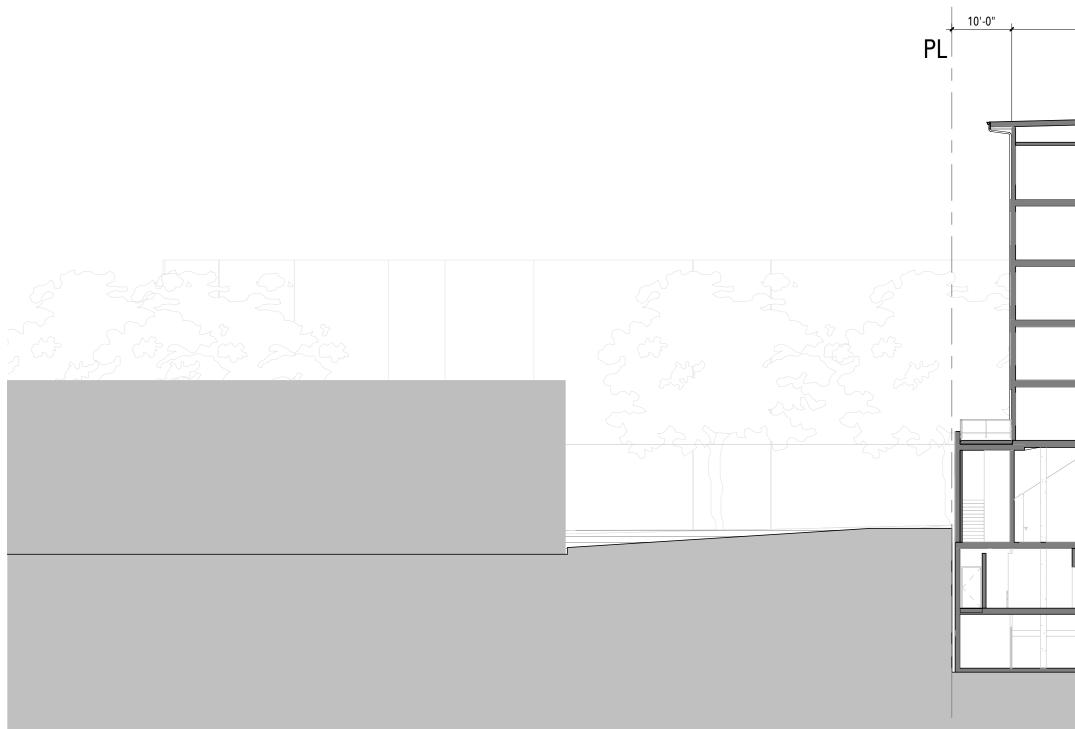


E-W SITE SECTION

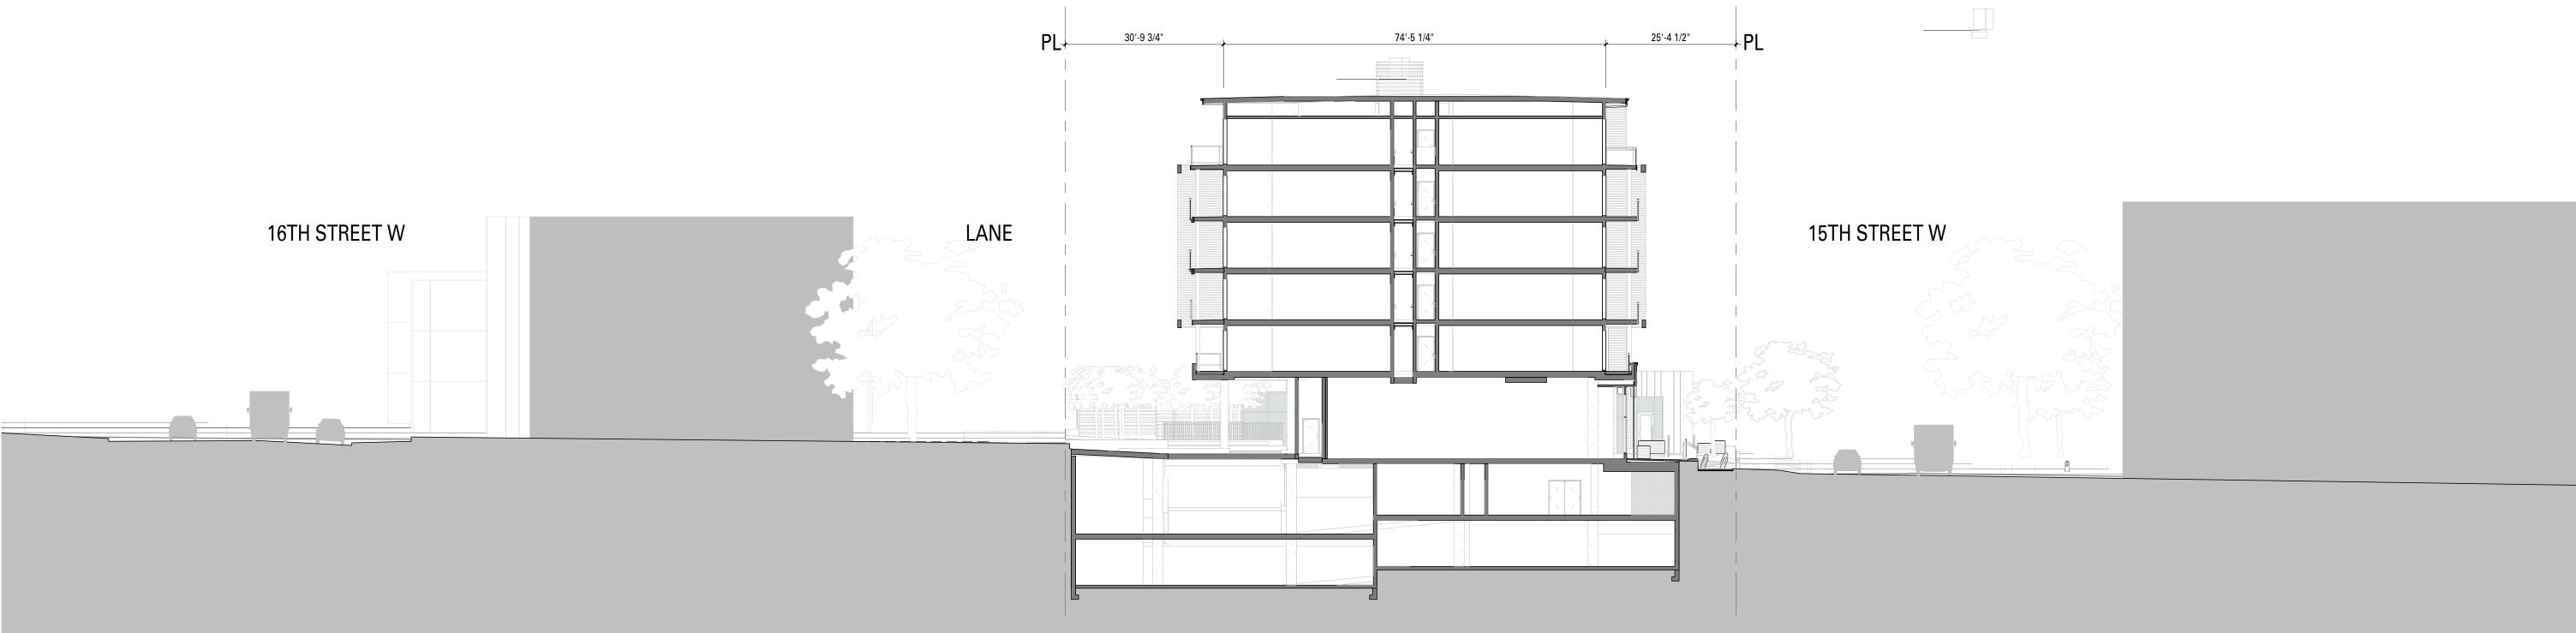

N-S SITE SECTION

, ,				

225'-3 1/4"

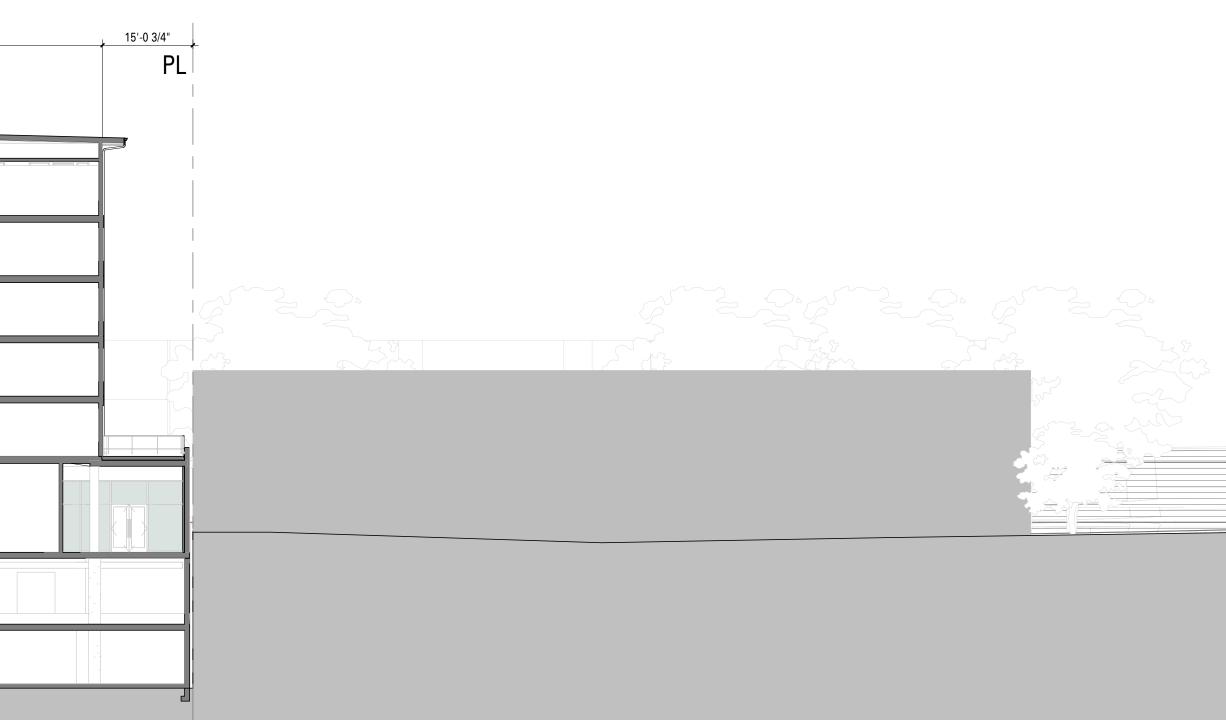

MARINE DRIVE



200,1000 West 3rd Street North Vancouver, BC V7P 3J6 **T** 604.988.7501 | shiftarchitecture.ca

This drawing is an instrument of service and the property of Shift Architecture Inc. and shall remain their property. The use of this drawing shall be restricted to the original site for which it was prepared and publication thereof is expressly limited to such use. Reuse, reproduction or publication by any method in whole or in part is prohibited without their written consent.

No.	Date	Revision Notes
	0.010100	
А	26/01/22	ISSUED FOR RZ/DP
No.	Date	Revision Notes



820 W 15th St, North Vancouver BC V7P 1M6



Client/Owner Polygon Development 237 Ltd.

Sheet Title SITE SECTIONS

Drawn By Reviewed by

Project Number **2003**

Plot Date 2021/01/22 Scale 1/16" = 1'-0"


Sheet Number

Author Approver

Issue Date 26/01/22

Issue/Revision Α



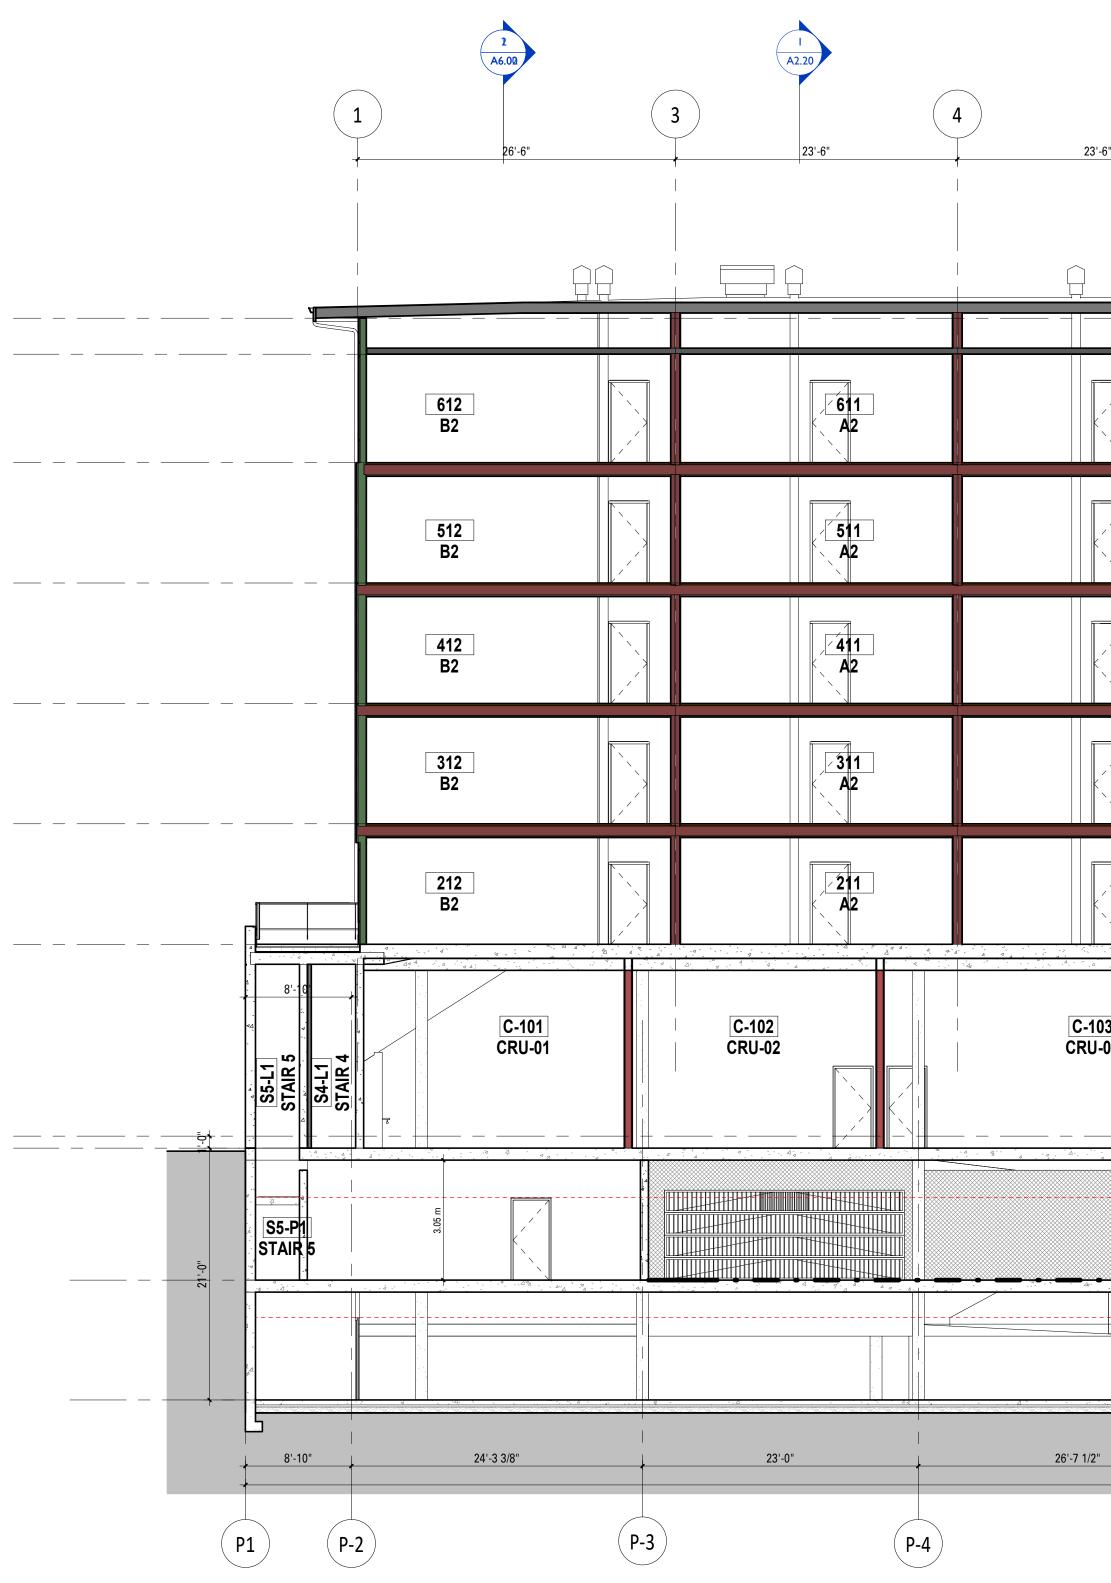



1TYPICAL E-W SECTION AT BUILDINGA1.011/8" = 1'-0"

					1 .03a			
23'-6"	23'-6"	3	23'-6"	0)	23'-6"		2)	23'-6"
610 A2	609 A2		608 A2			607 A2		606 A2 AD
510 A2	509 A2		508 A2			507 A2		506 A2 AD
410 A2	409 A2		408 A2			407 A2		406 A2 AD
310 A2	309 A2		308 A2			307 A2		306 A2 AD
210 A2	209 A2		208 A2			207 A2		206 A2 AD
-103	104 J-04 C-105 CRU-05		C-106 CRU-06			100 LOBB		
			P100 P1 PARKING					
			P200 P2 PARKING					
/2"	25'-7 1/2"		25'-7 1/2" 249'-3"			25'-7 1/2"		25'-
P-	5	P-6		P-7			P-8	





This drawing is an instrument of service and the property of Shift Architecture Inc. and shall remain their property. The

use of this drawing shall be restricted to the original site for which it was prepared and publication thereof is expressly limited to such use. Reuse, reproduction or publication by any method in whole or in part is prohibited without their written consent.

No.	Date	Revision Notes
А	26/01/22	ISSUED FOR RZ/DP
No.	Date	Revision Notes



820 W 15th St, North Vancouver BC V7P 1M6 POLYGON Client/Owner Polygon Development 237 Ltd. Sheet Title **BUILDING SECTIONS** Drawn By Author Reviewed by Approver Project Number **2003** Plot Date Issue Date

2021/01/22 Scale 1/8" = 1'-0" Sheet Number


26/01/22

Issue/Revision Α

A6




-01

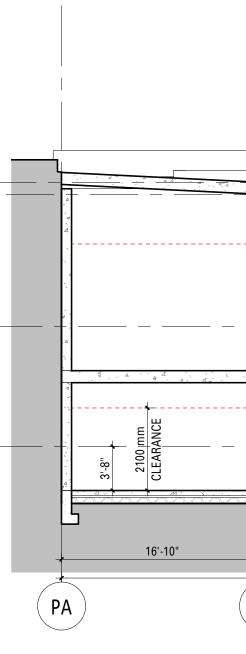

_____ _ _____

_ _ _ _ _ _ _ _ _ _ _ _ _ _ _ _

1TYPICAL N-S SECTION AT BUILDINGA1.011/8" = 1'-0"

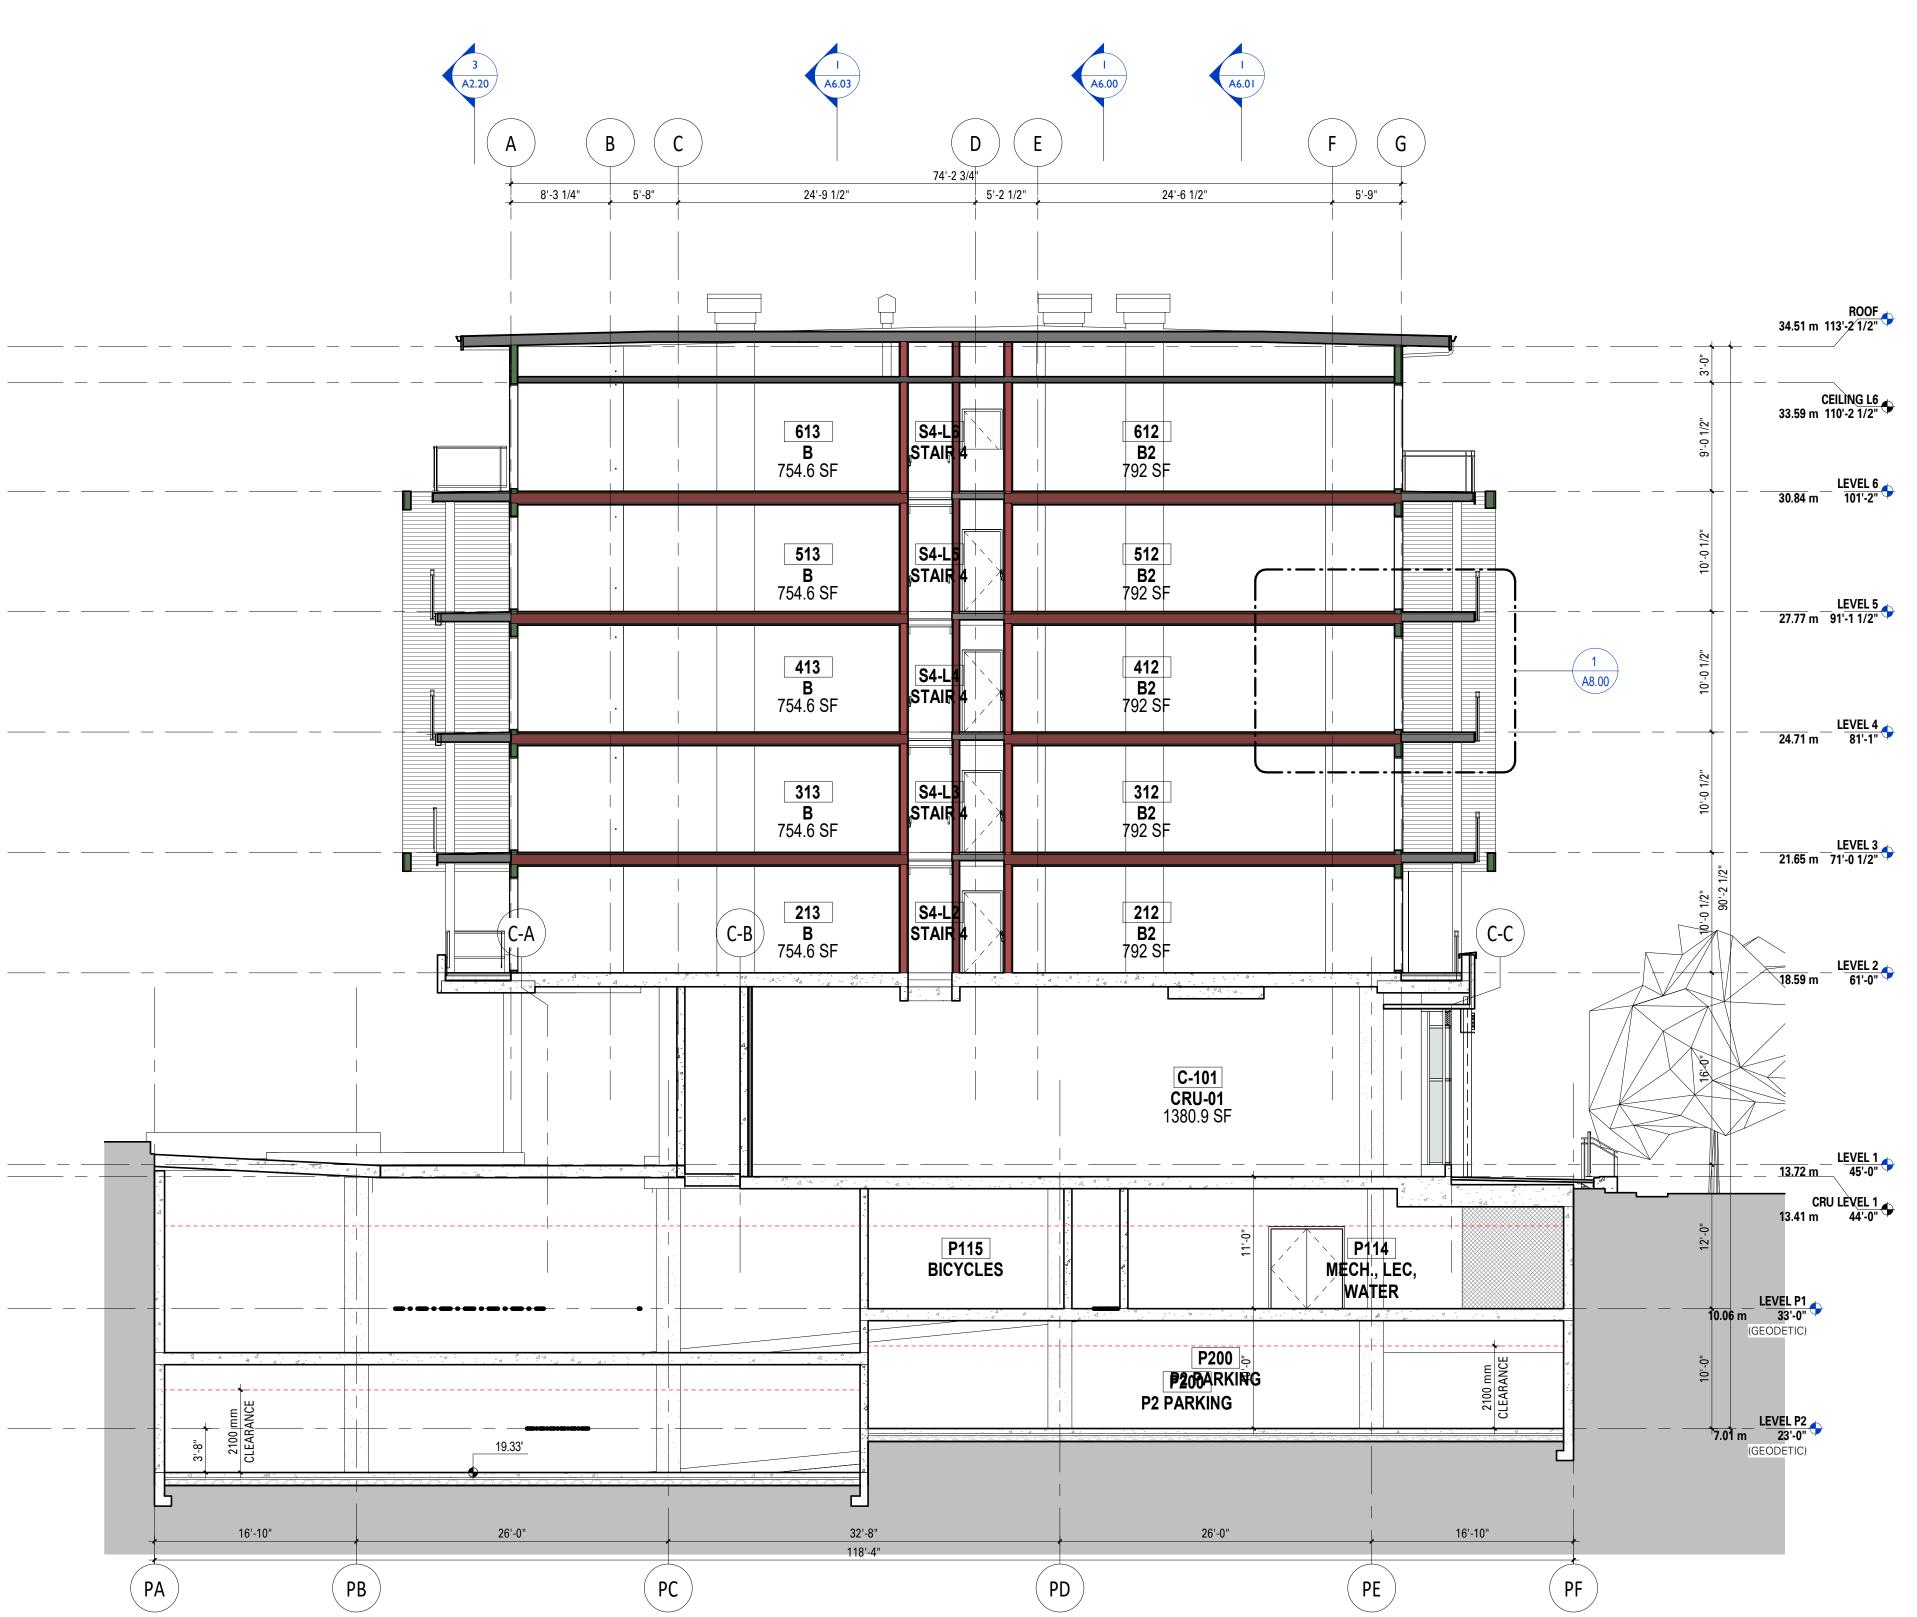



This drawing is an instrument of service and the property of Shift Architecture Inc. and shall remain their property. The

use of this drawing shall be restricted to the original site for which it was prepared and publication thereof is expressly limited to such use. Reuse, reproduction or publication by any method in whole or in part is prohibited without their written consent.

No.	Date	Revision Notes
A	26/01/22	ISSUED FOR RZ/DP
No.	Date	Revision Notes



Plot Date

Scale

2021/01/22

1/8" = 1'-0"


Sheet Number

820 W 15th St, North Vancouver BC V7P 1M6 POLYGON Client/Owner Polygon Development 237 Ltd. Sheet Title **BUILDING SECTIONS** Drawn By Author Reviewed by Approver Project Number **2003**

> Issue Date 26/01/22

Issue/Revision Α



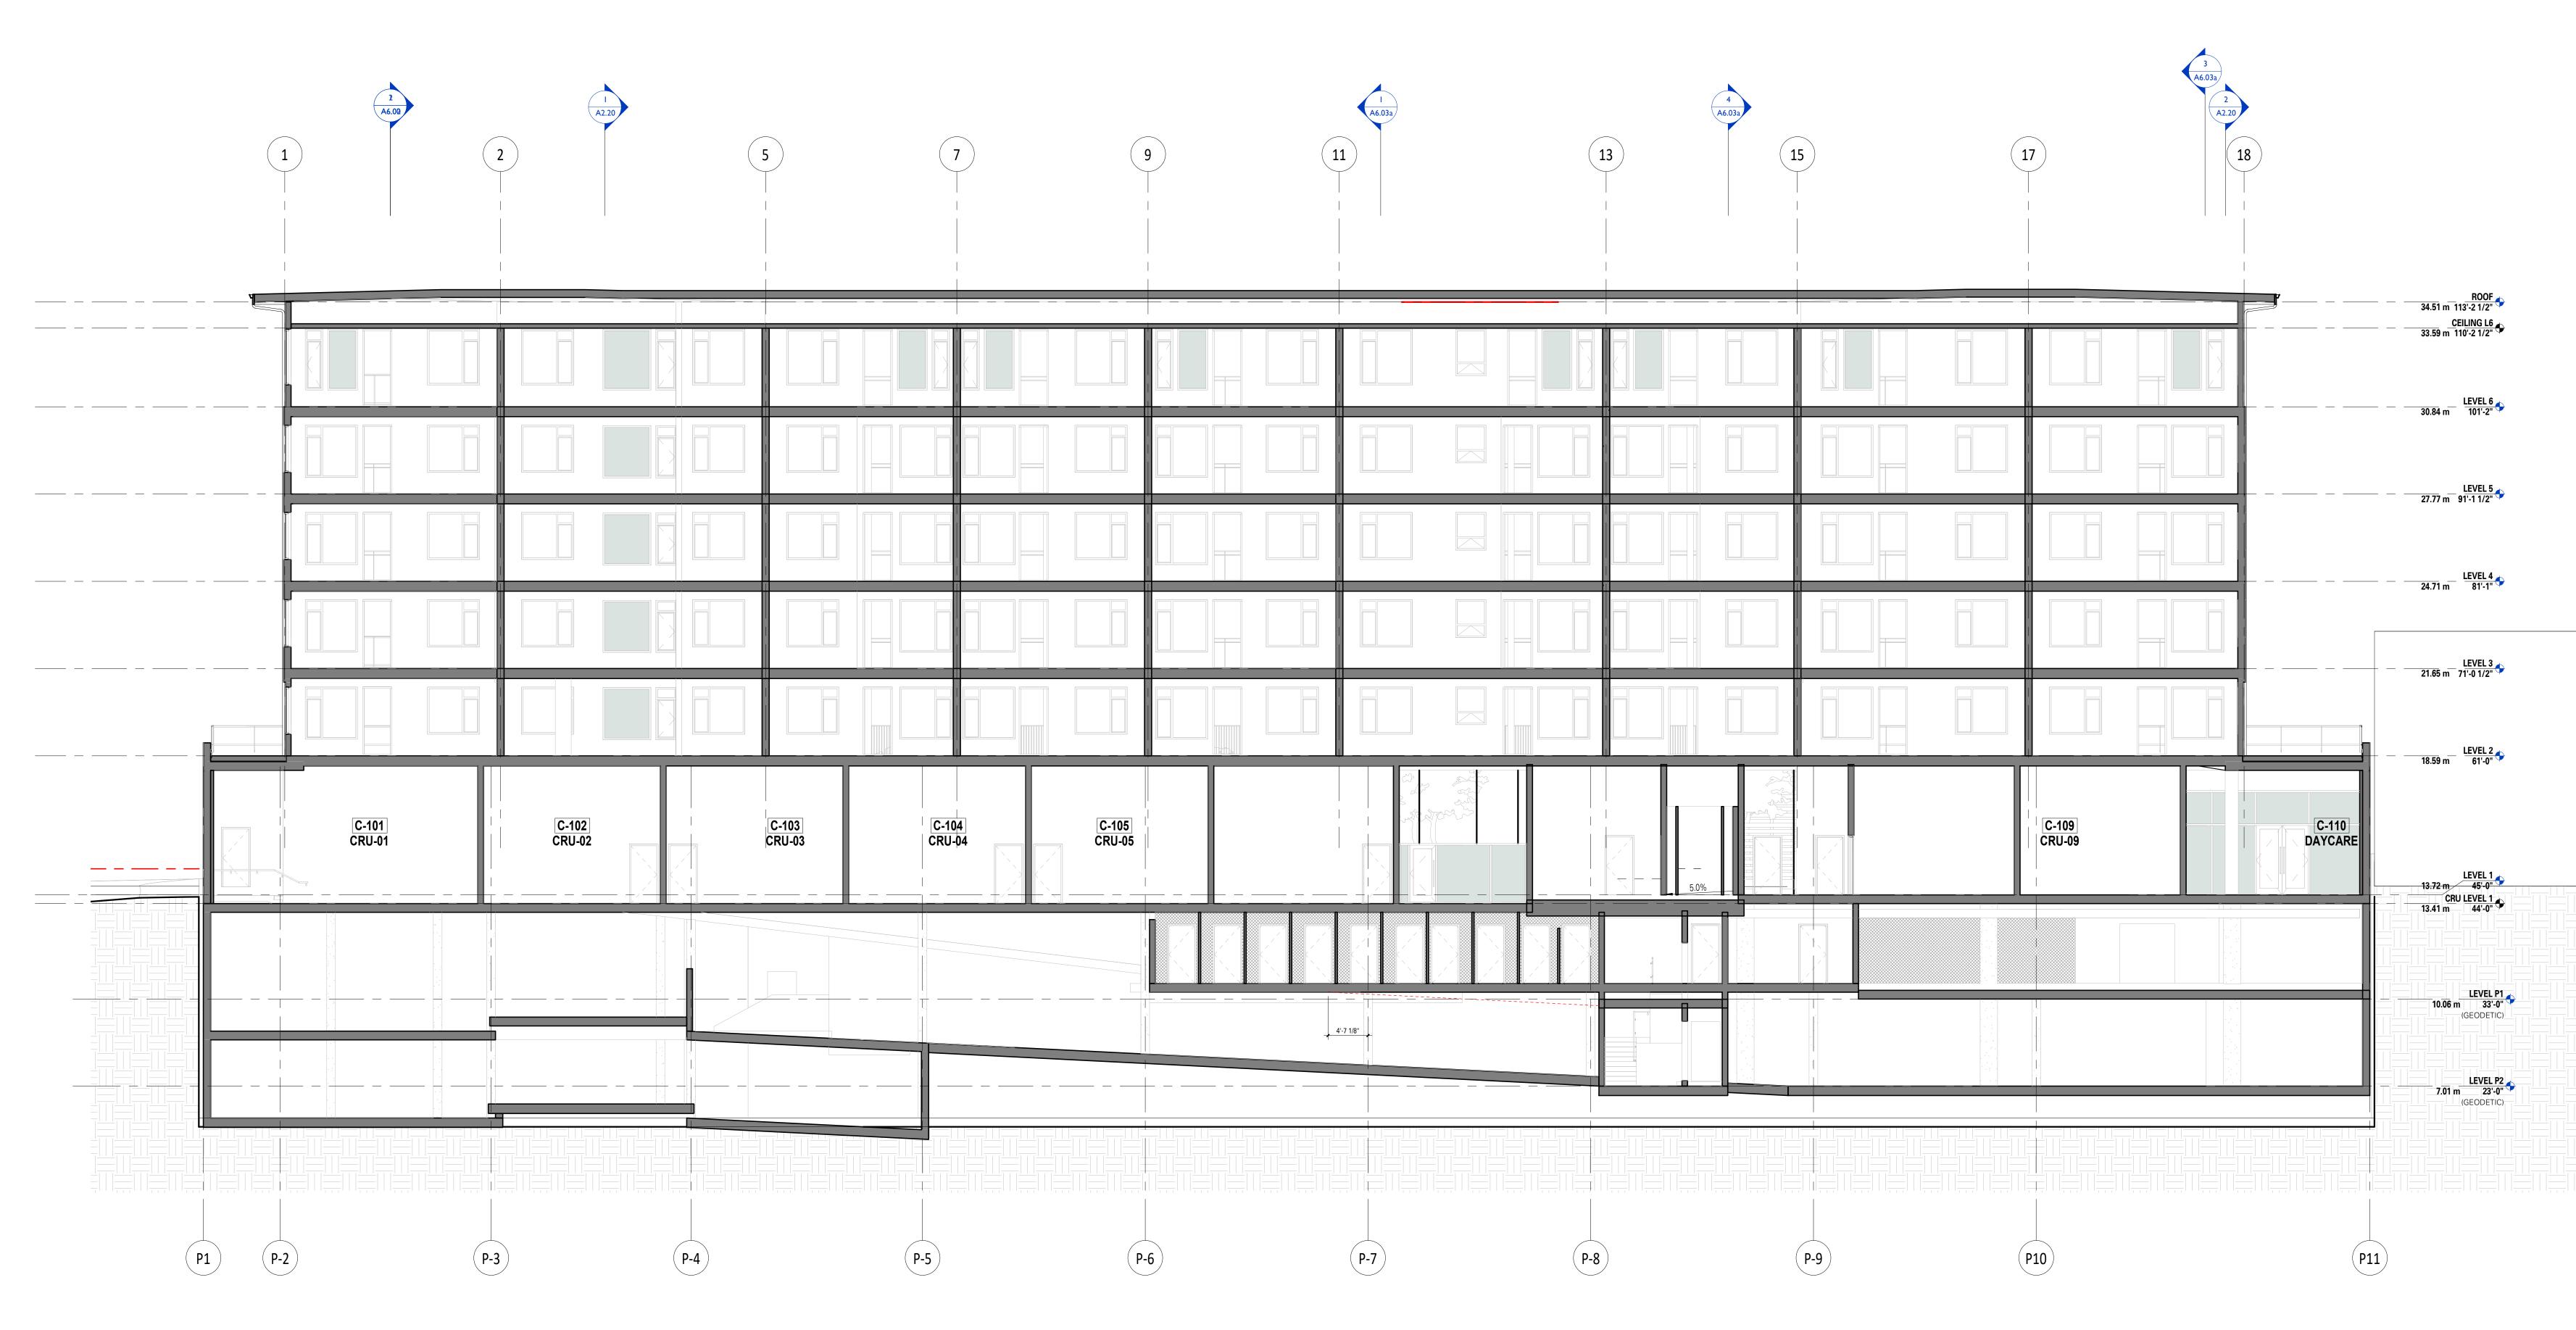

 1
 E-W SECTION AT DAYCARE & CORRIDOR 101

 A1.01
 1/8" = 1'-0"



This drawing is an instrument of service and the property of Shift Architecture Inc. and shall remain their property. The

use of this drawing shall be restricted to the original site for which it was prepared and publication thereof is expressly limited to such use. Reuse, reproduction or publication by any method in whole or in part is prohibited without their written consent.

No.	Date	Revision Notes
Α	26/01/22	ISSUED FOR RZ/DP
No.	Date	Revision Notes



POLYGON Client/Owner Polygon Development 237 Ltd. Sheet Title **BUILDING SECTIONS**

820 W 15th St, North Vancouver BC V7P 1M6

Drawn By Reviewed by

_____ Project Number **2003**

Plot Date 2021/01/22 Scale 1/8" = 1'-0"


Sheet Number

Author Approver

Issue Date 26/01/22

Issue/Revision Α



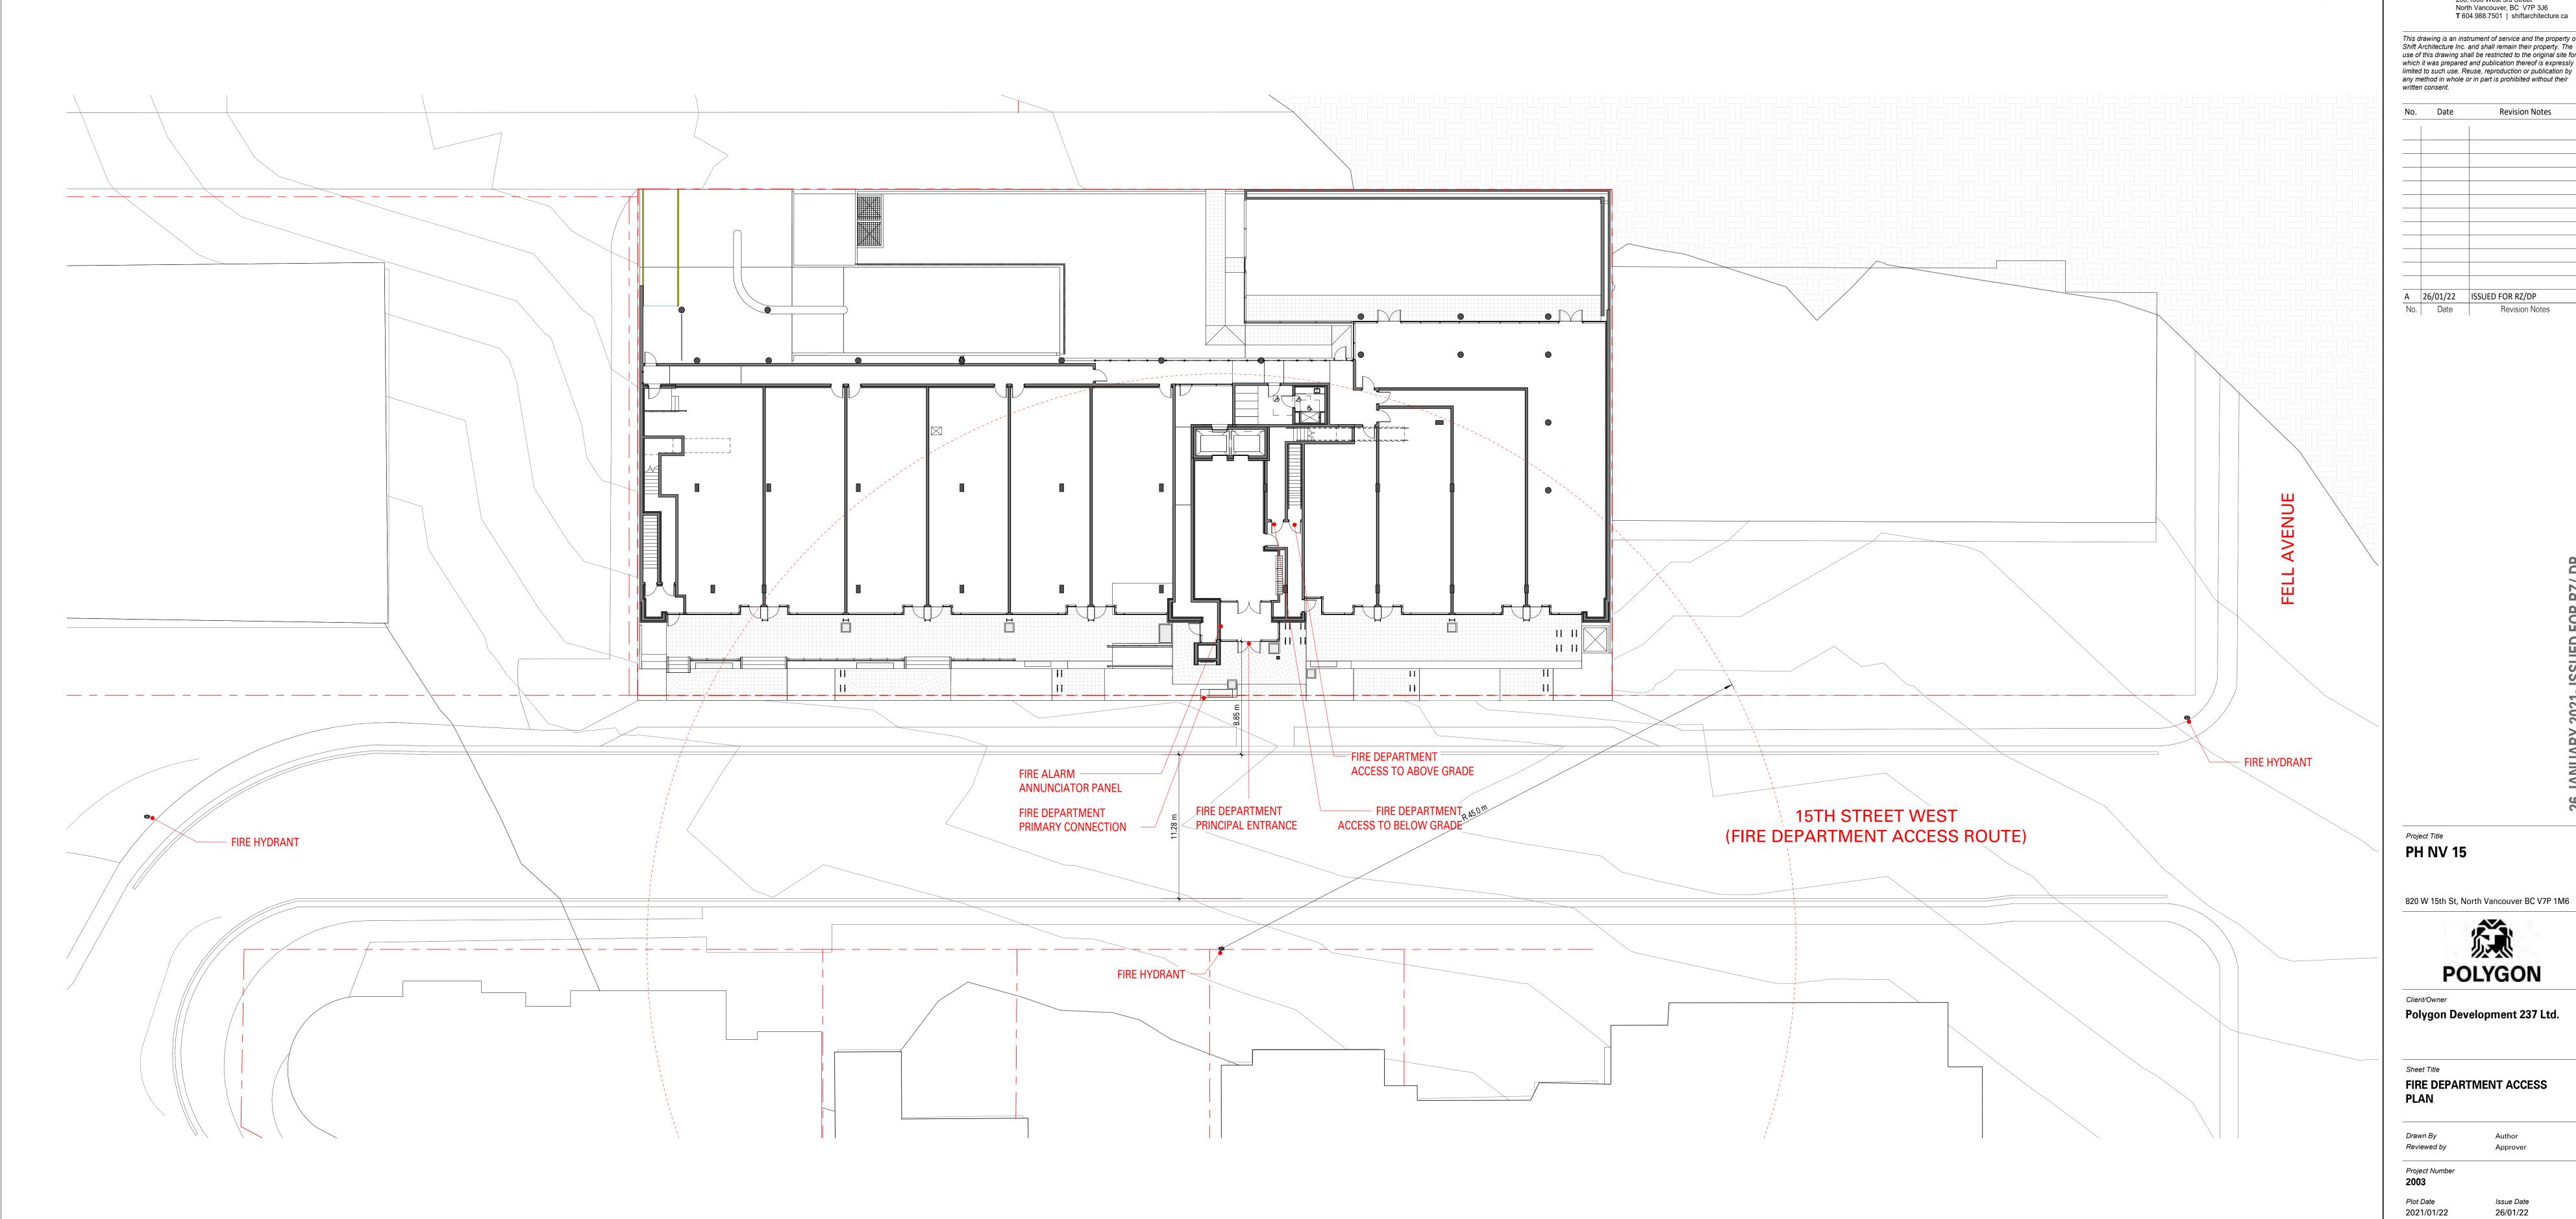



This drawing is an instrument of service and the property of Shift Architecture Inc. and shall remain their property. The use of this drawing shall be restricted to the original site for which it was prepared and publication thereof is expressly limited to such use. Reuse, reproduction or publication by any method in whole or in part is prohibited without their written consent.

No.	Date	Revision Notes
Α	26/01/22	ISSUED FOR RZ/DP
No.	Date	Revision Notes



POLYGON Client/Owner Polygon Development 237 Ltd. Sheet Title FIRE DEPARTMENT ACCESS PLAN Drawn By Author Reviewed by Approver

> Issue Date 26/01/22

> > Issue/Revision Α


A9.01

C:\REVIT 2021 LOCAL FILES\2003 PH M15 - BUILDING (Central)_SHIFT_Shadi.rvt


Scale

1/16" = 1'-0"


Sheet Number

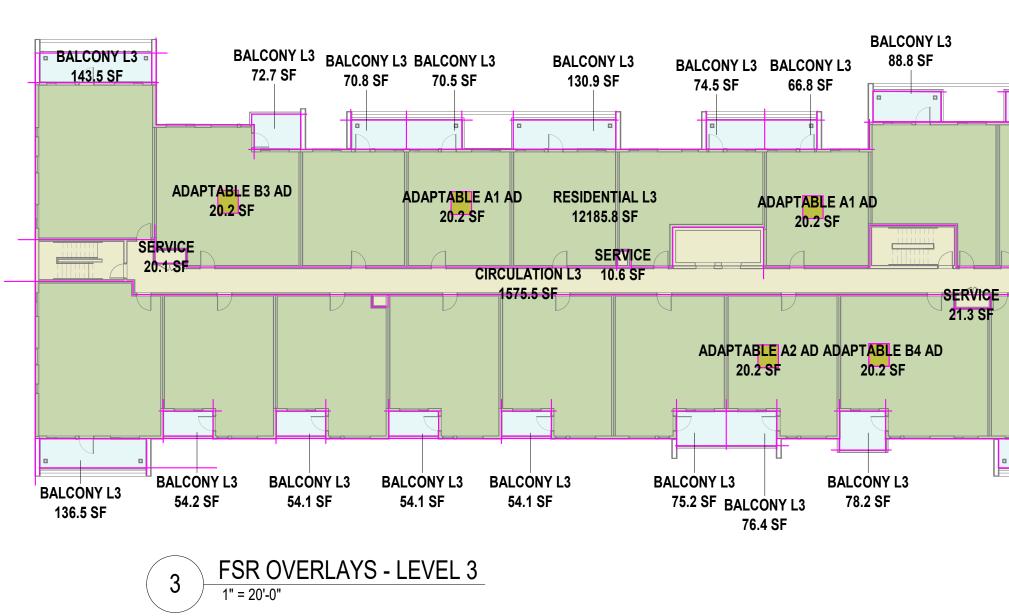





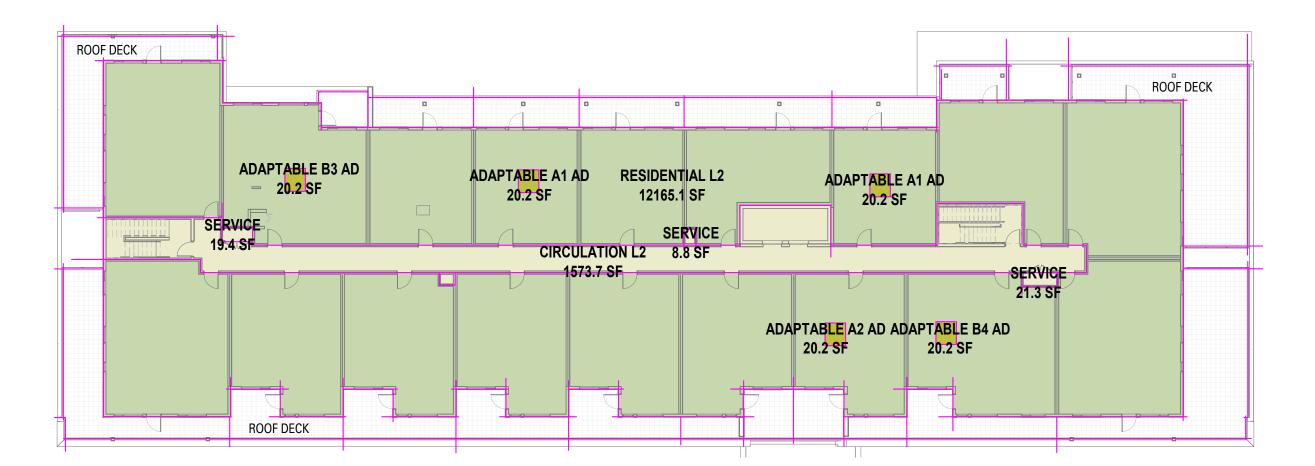




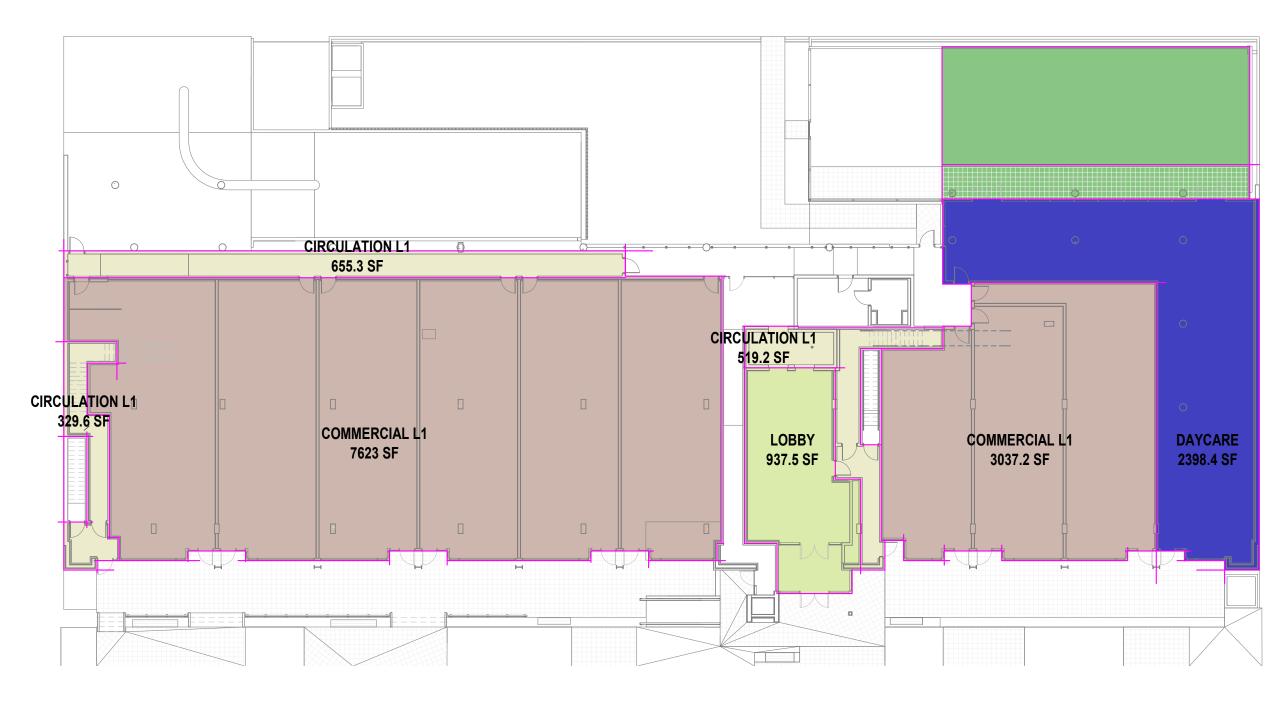

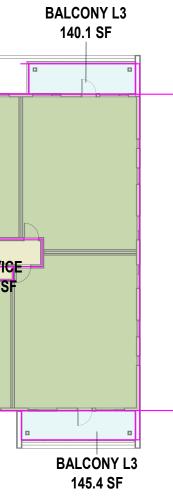

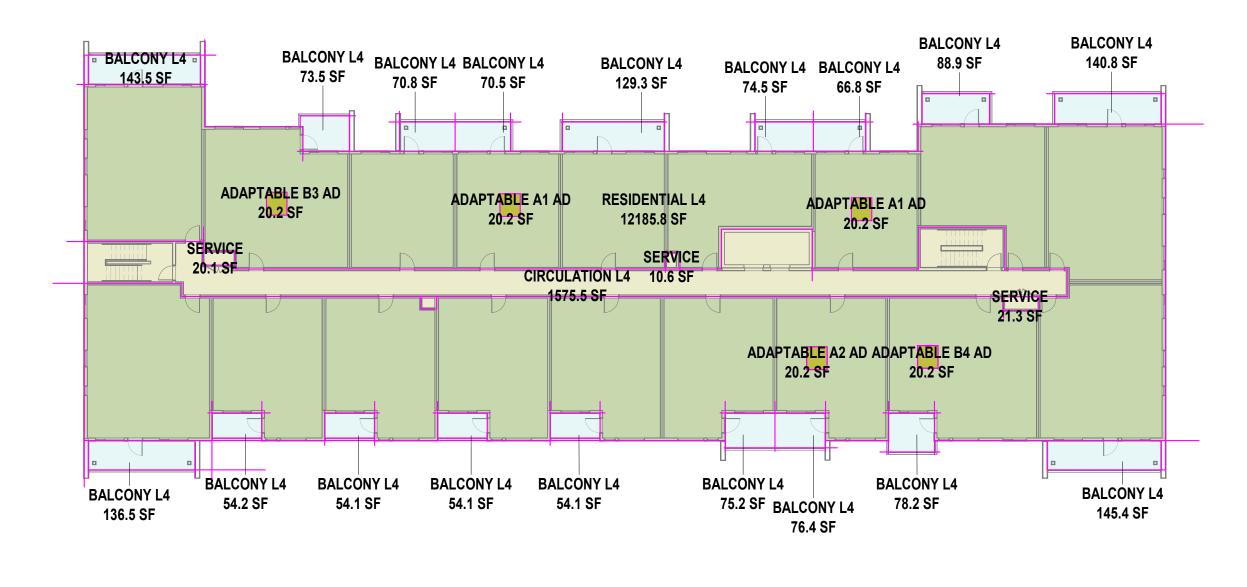




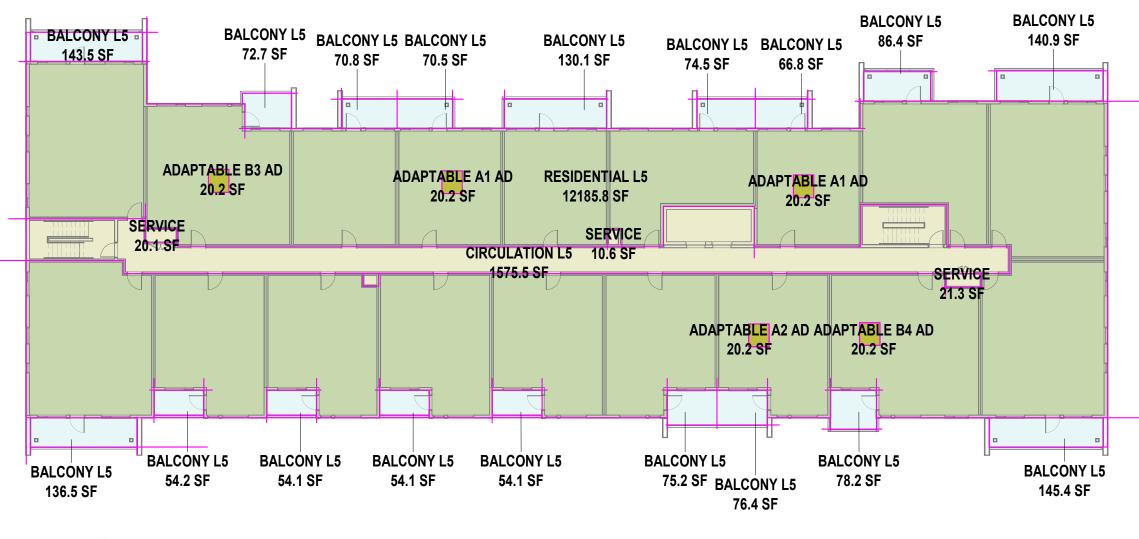



FSR OVERLAYS - LEVEL 5 1" = 20'-0"

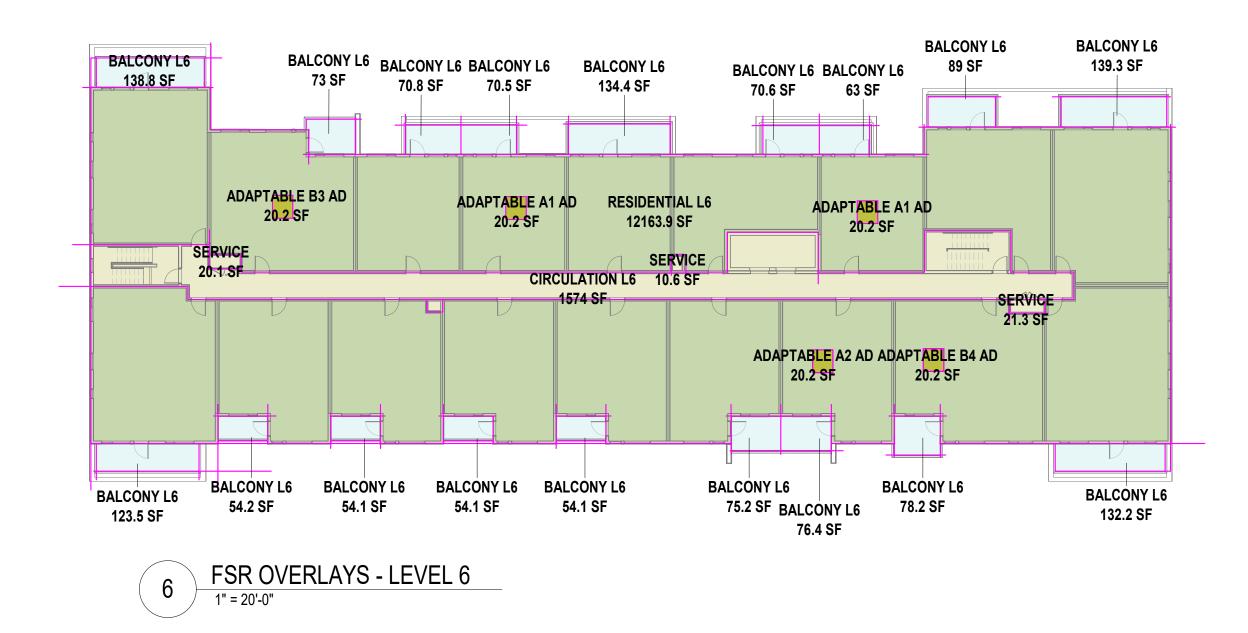

GROSS FLOOR AREA LEVEL P1

GROSS FLOOR AREA LEVEL 1

CIRCULATION	1504 SF
COMMERCIAL	10660.2 SF
DAYCARE	2398.4 SF
LOBBY	937.5 SF
TOTAL:	15500.1 SF

GROSS FLOOR AREA LEVEL 2

ADAPTABLE	101.2 SF
CIRCULATION	1631.9 SF
RESIDENTIAL	12165.1 SF
TOTAL:	13898.2 SF

GROSS FLOOR AREA LEVEL 3

ADAPTABLE	101.2 SF
CIRCULATION	1636.2 SF
RESIDENTIAL	12185.8 SF
TOTAL:	13923.2 SF

GROSS FLOOR AREA LEVEL 4

ADAPTABLE	101.2 SF
CIRCULATION	1636.2 SF
RESIDENTIAL	12185.8 SF
TOTAL:	13923.2 SF

GROSS FLOOR AREA LEVEL 5

ADAPTABLE	101.2 SF
CIRCULATION	1636.2 SF
RESIDENTIAL	12185.8 SF
TOTAL:	13923.2 SF

GROSS FLOOR AREA LEVEL 6

ADAPTABLE	101.2 SF
CIRCULATION	1634.8 SF
RESIDENTIAL	12163.9 SF
TOTAL:	13899.8 SF

GROSS FLOOR AREA TOTAL

LEVEL 1	15500.1 SF
LEVEL 2	13898.2 SF
LEVEL 3	13923.2 SF
LEVEL 4	13923.2 SF
LEVEL 5	13923.2 SF
LEVEL 6	13899.8 SF
TOTAL:	85067.7 SF




This drawing is an instrument of service and the property of Shift Architecture Inc. and shall remain their property. The use of this drawing shall be restricted to the original site for which it was prepared and publication thereof is expressly limited to such use. Reuse, reproduction or publication by any method in whole or in part is prohibited without their

written consent.

T 604.988.7501 | shiftarchitecture.ca

No.	Date	Revision Notes
A	26/01/22	ISSUED FOR RZ/DP
No.	Date	Revision Notes



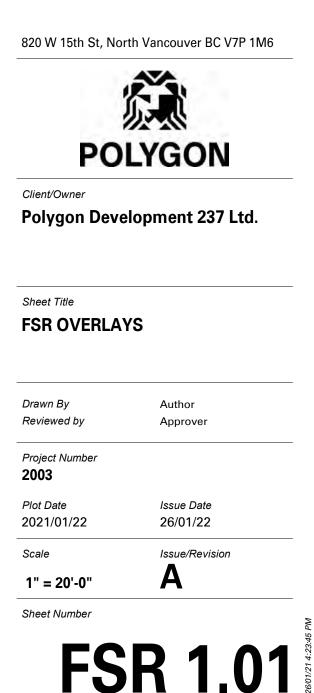






No.	Date	Revision Notes
	1	1
٨	26/01/22	
A No.	26/01/22 Date	ISSUED FOR RZ/DP Revision Notes



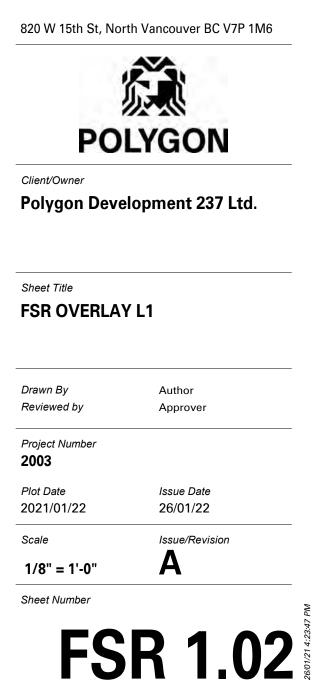







No.	Date	Revision Notes
NU.	Date	Revision notes
A	26/01/22	ISSUED FOR RZ/DP
No.	Date	Revision Notes



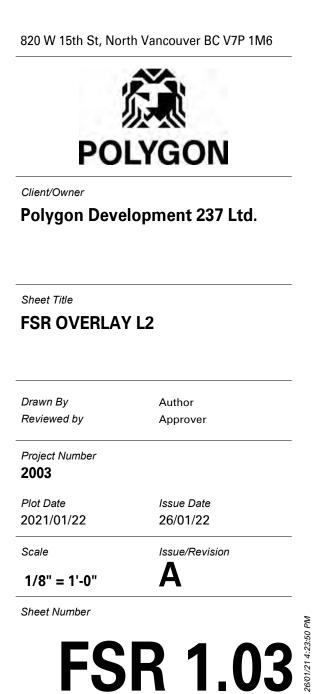

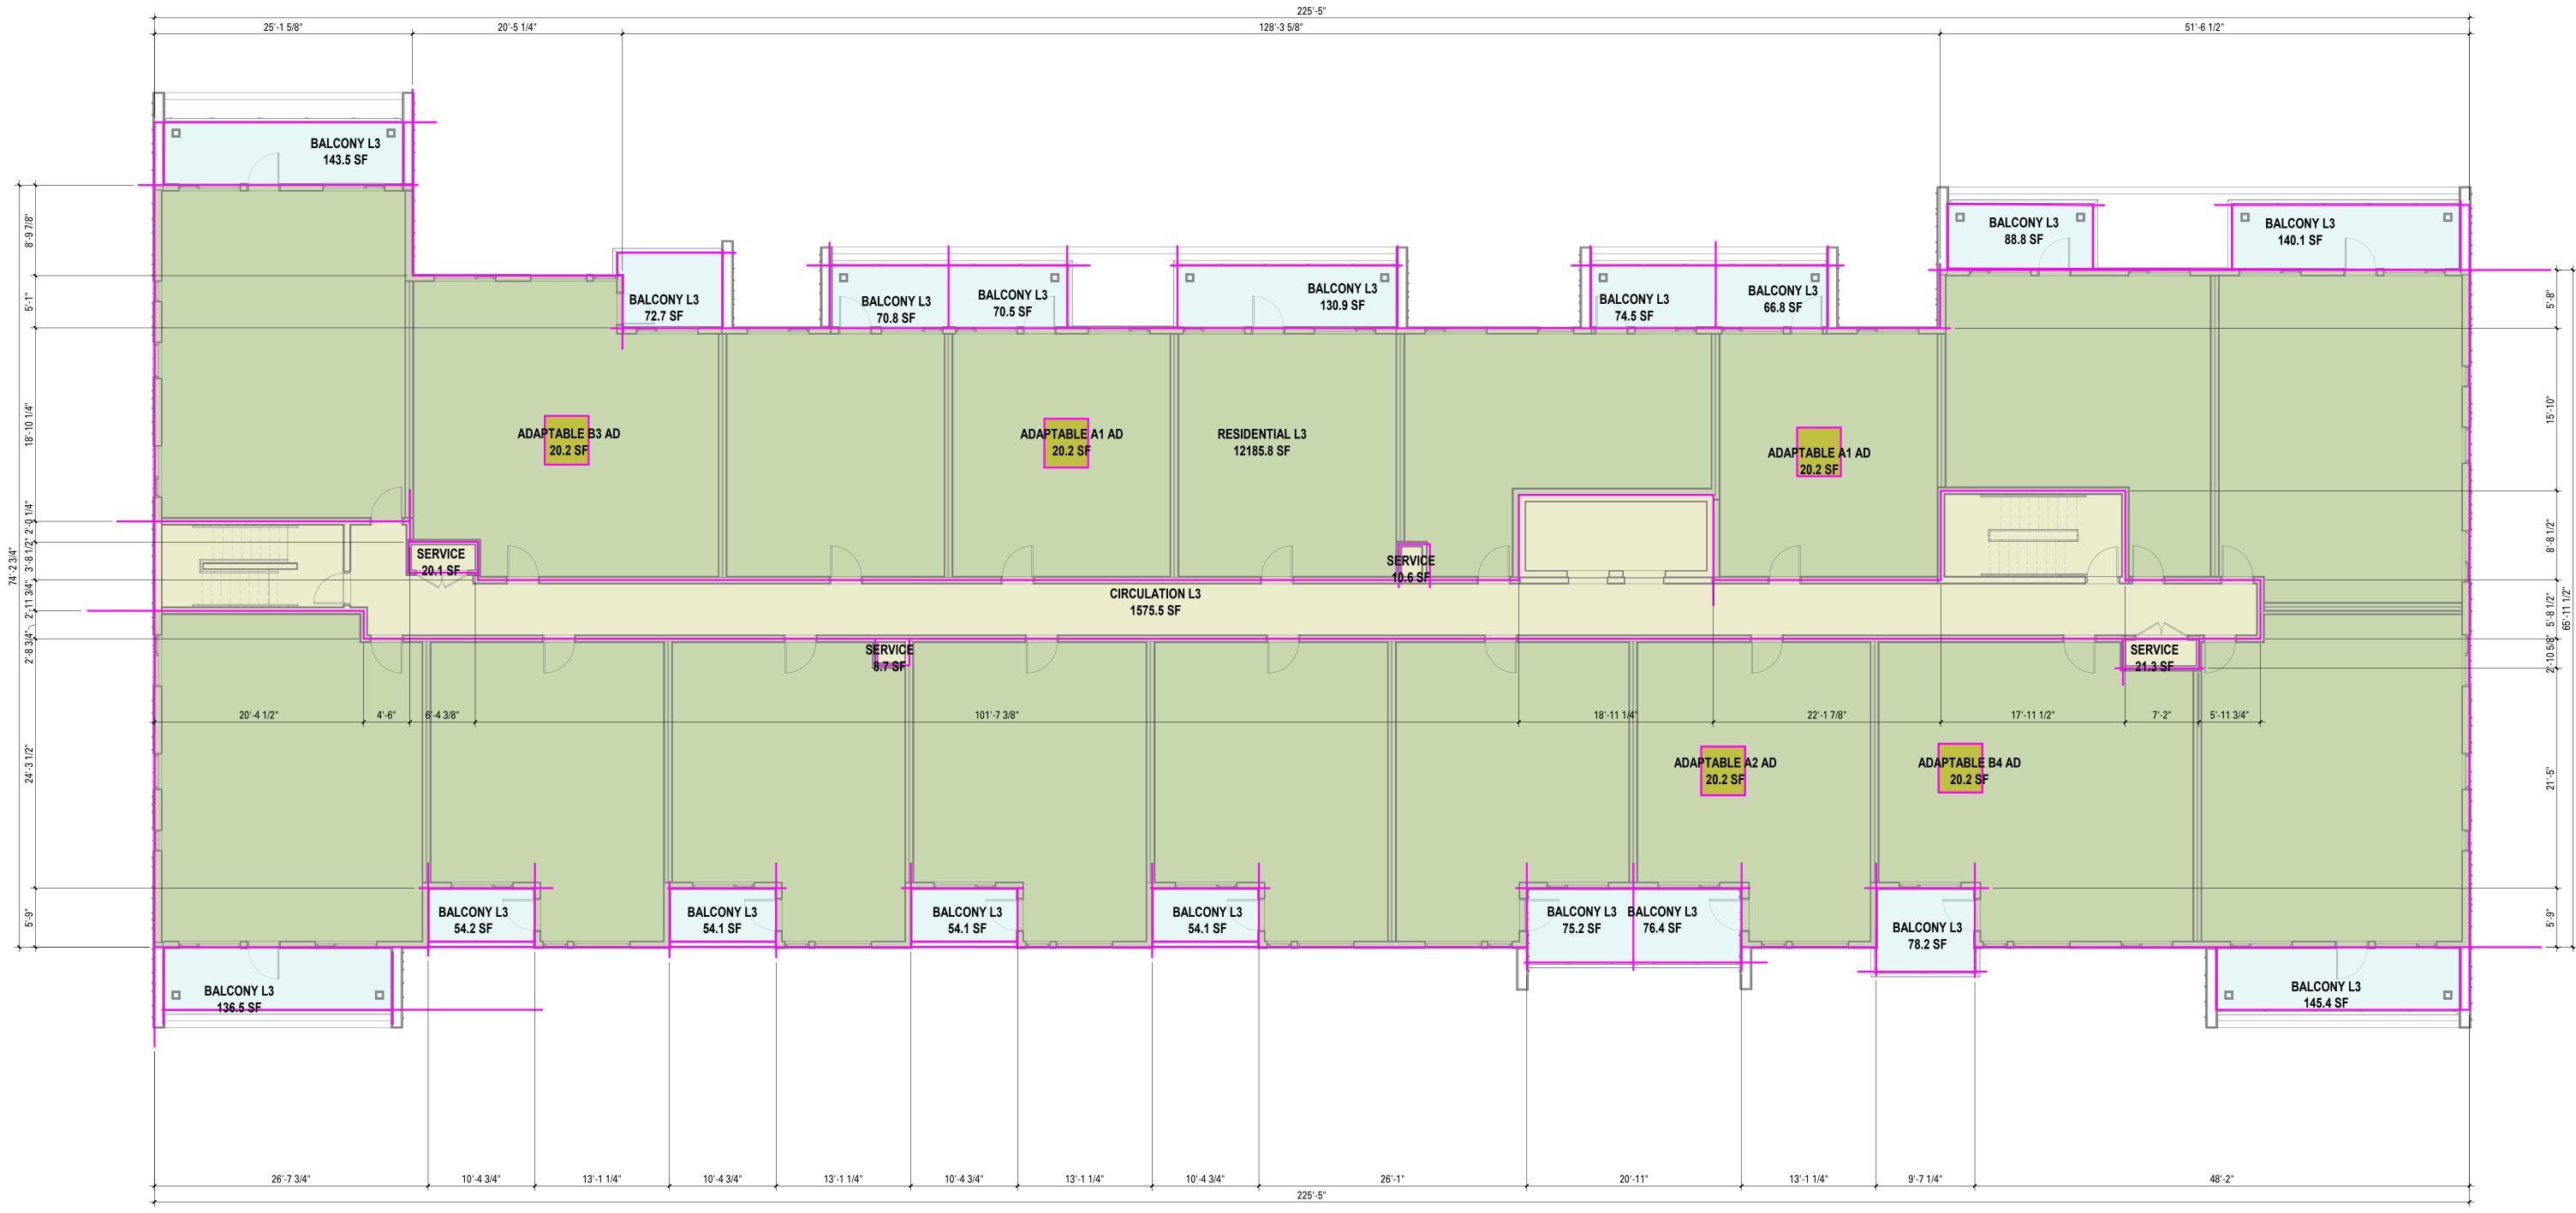




No.	Date	Revision Notes
		1
A	26/01/22	ISSUED FOR RZ/DP
No.	Date	Revision Notes





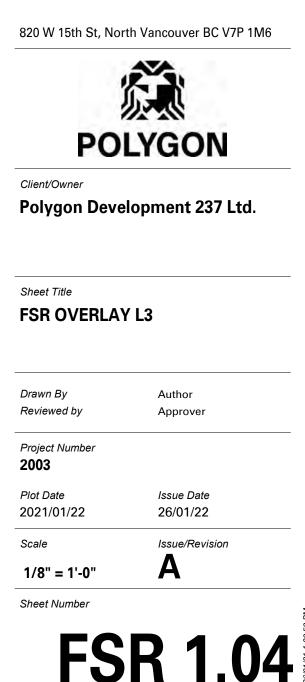









No.	Date	Revision Notes
	1	1
٨	26/01/22	
A No.	26/01/22 Date	ISSUED FOR RZ/DP Revision Notes



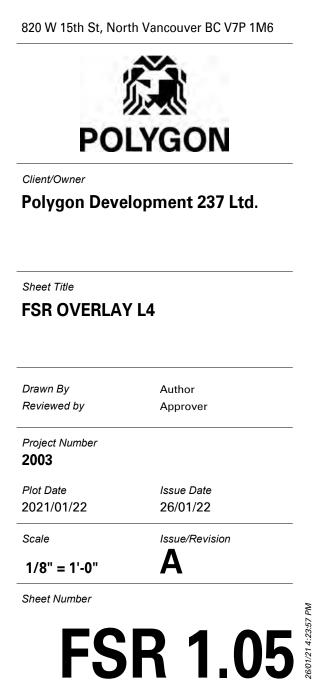




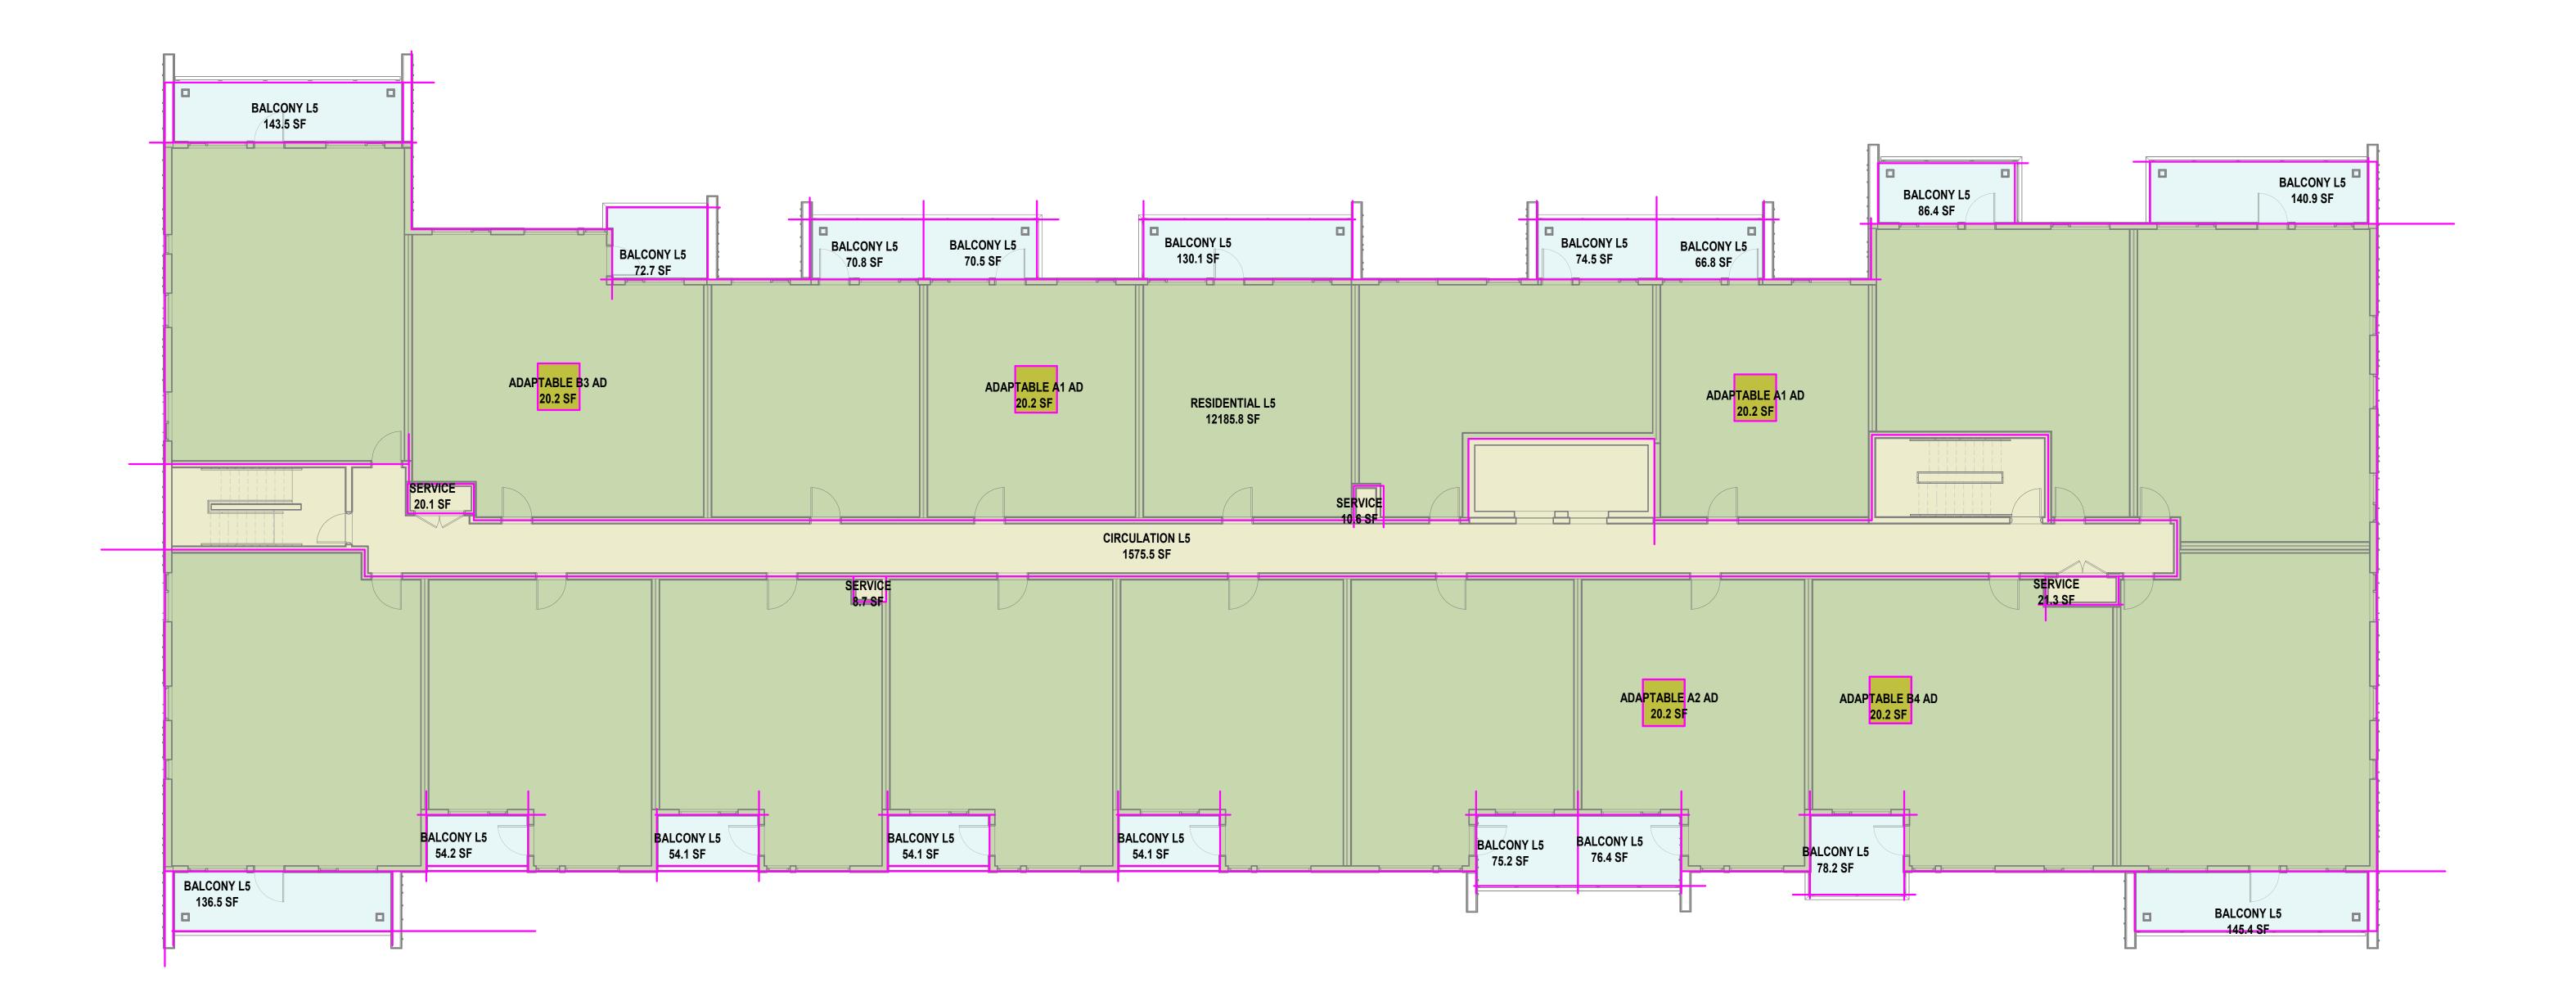



No.	Date	Revision Notes
A	26/01/22	ISSUED FOR RZ/DP
No.	Date	Revision Notes



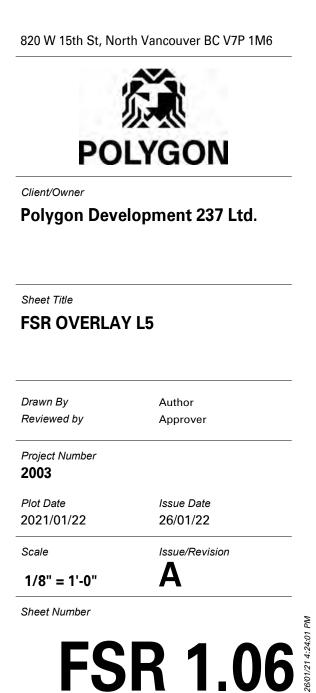





No.	Date	Revision Notes
A	26/01/22	ISSUED FOR RZ/DP
No.	Date	Revision Notes





