


McKIBBIN-McLARTY RENOVATION / ADDITION

1253 Sutherland Ave. North Vancouver, BC 1.03.2023



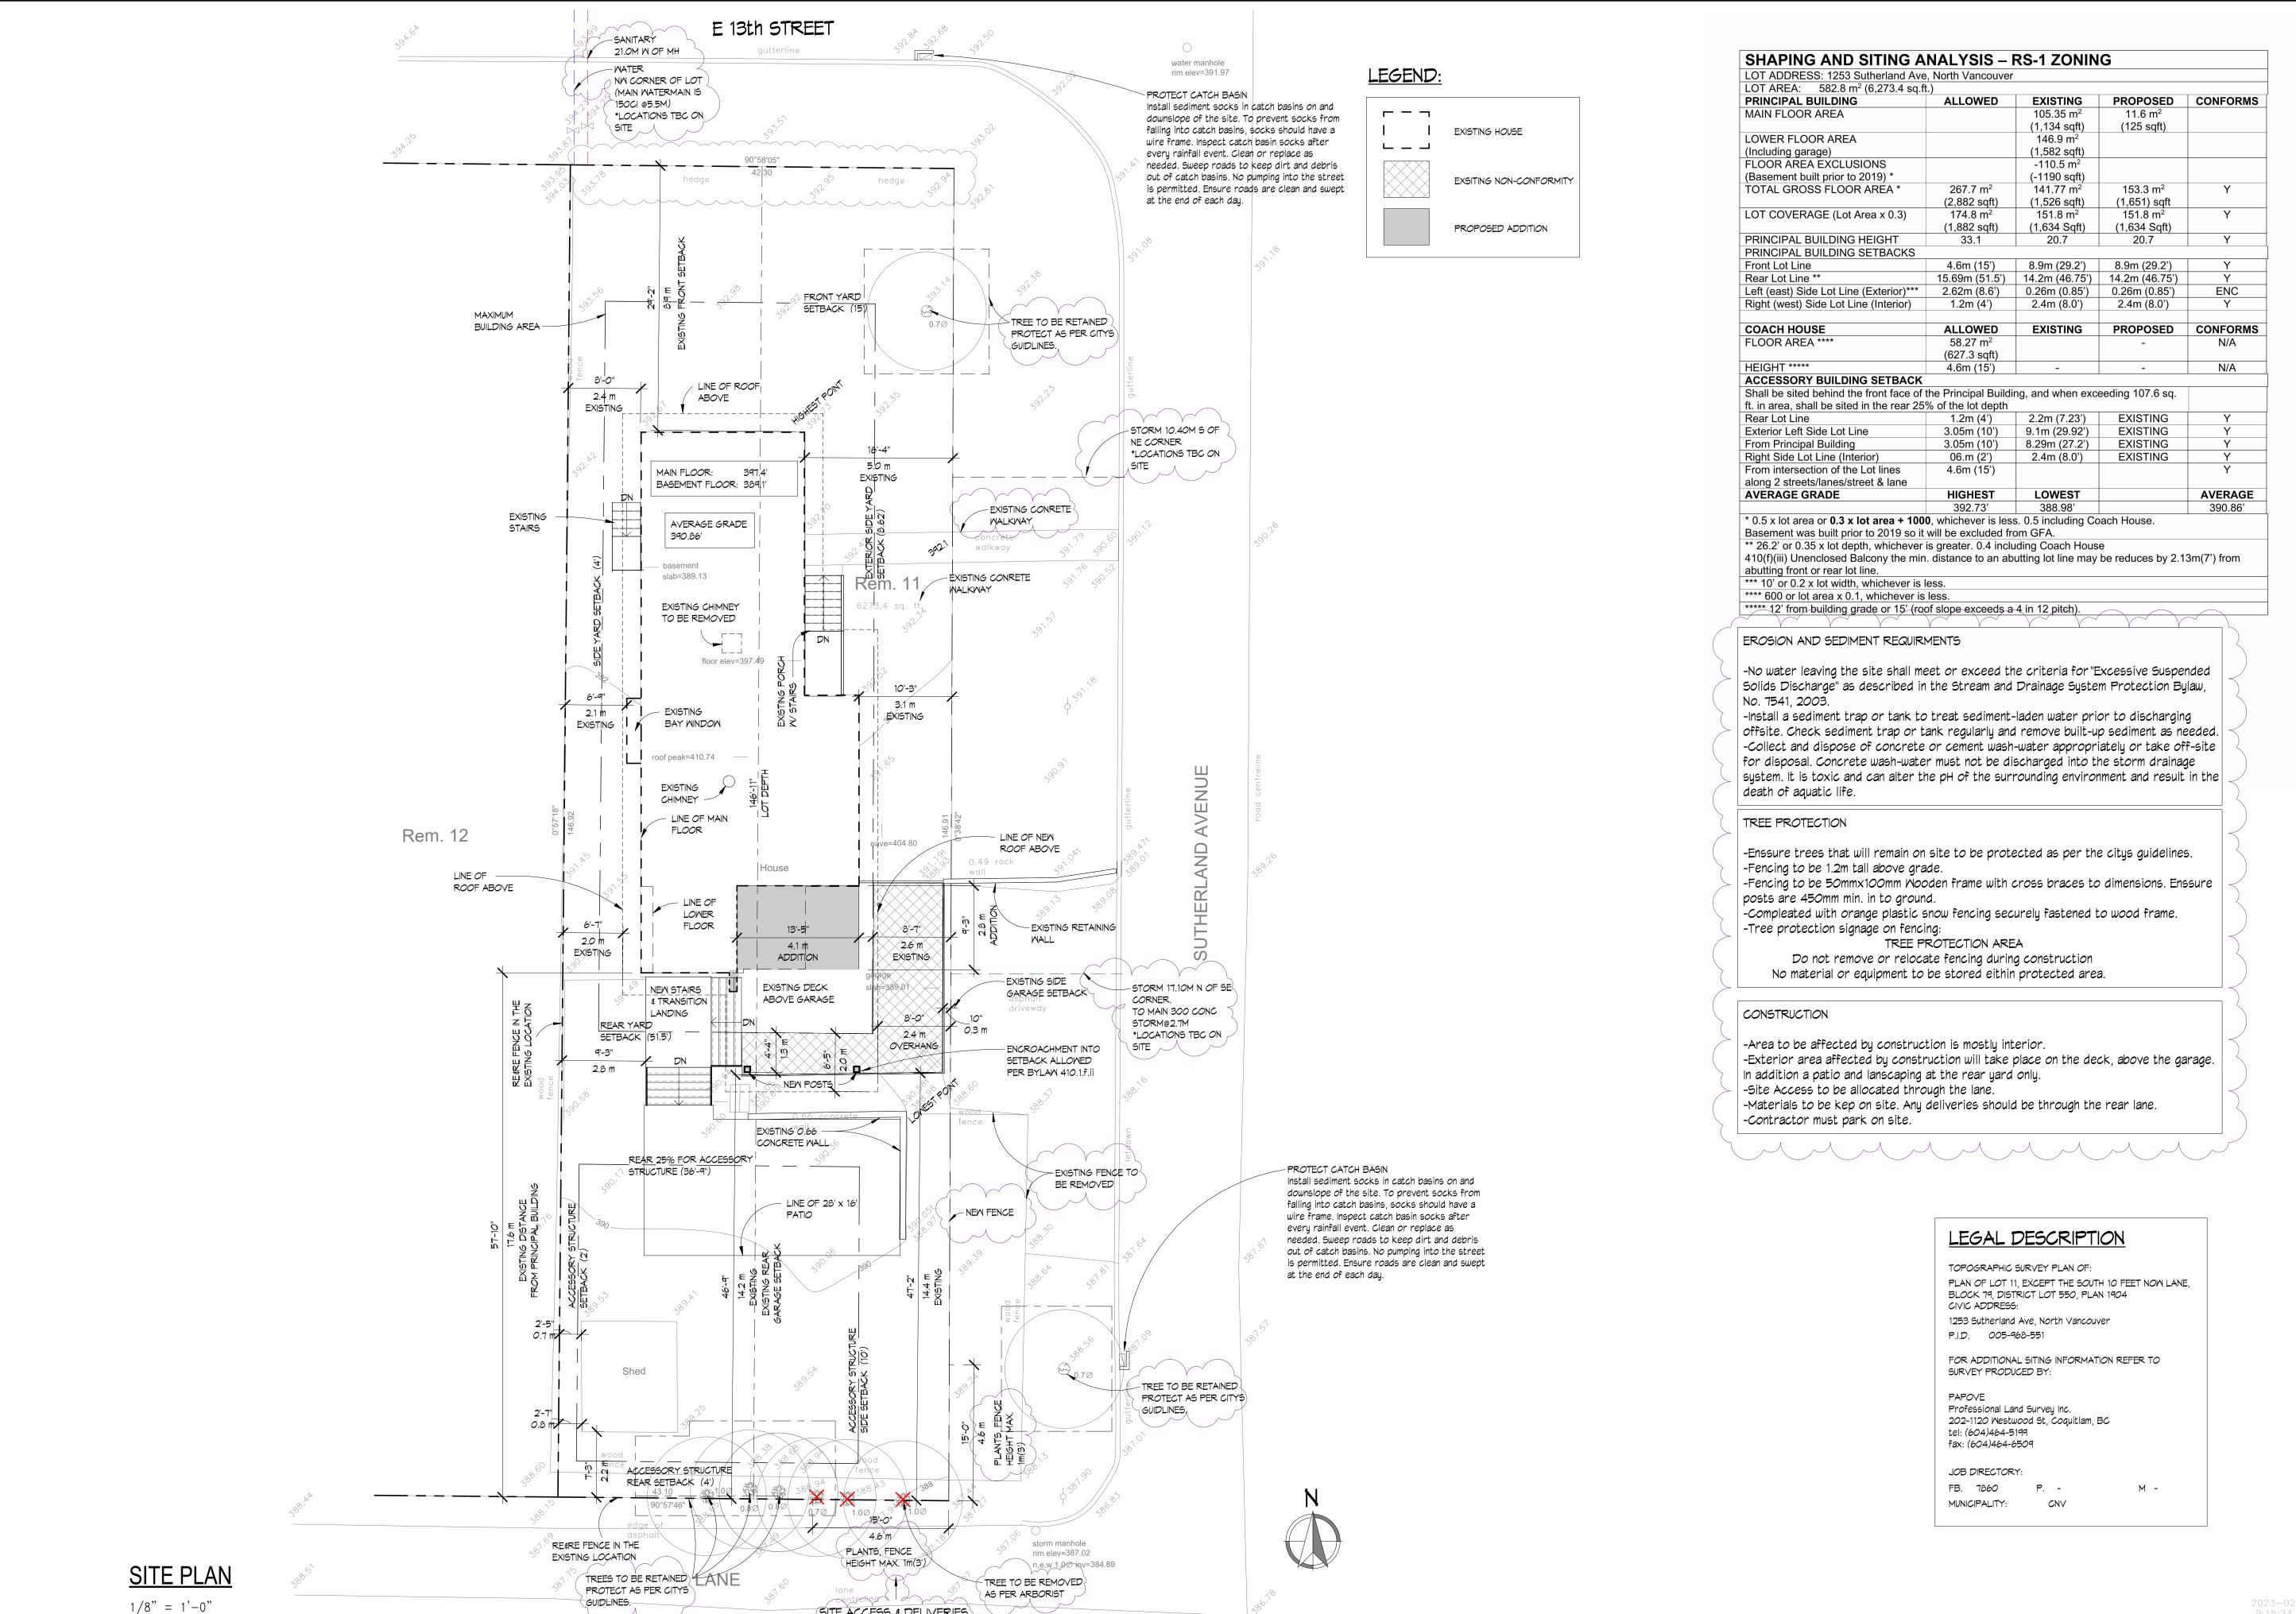

SITE ACCESS & DELIVERIES

REVISIONS | # | BY Comments 01.06.2023 contents of this drawing are the exclusive proper of Synthesis Design Inc and shall not be used reproduced without the consent of the Designe All dimensions shall be

verified on site prior to

ommencement of work

synthesis design inc. 258 east 1st street north vancouver, bc, canada V7L 1B3 tel. (604) 980-2087 www.synthesisdesign.ca

AD

TION Ave. RENOVA utherland ≻ ડ McKIBBIN-McLART 1253

Drawing Title SITE PLAN

Date 1.03.2023

Scale 1/8" = 1'-0"Drawn PGS

Job No. 22011

Sheet A-1

Of 10

Contract Documents

The Contract Documents refer to:

-The Contract between the Owner and General Contractor. -Construction Documents (all drawings, specifications and surveys).

-Consultant's Drawings and Reports. -SYNTHESIS DESIGN, INC. will not be responsible for any costs incurred to Owner or Contractor through errors or omissions in the Contract Documents after building permit is issued. -SYNTHESIS DESIGN, INC. will not be responsible for any alterations or changes during the construction process that are not documented in the Contract Documents.

-All Contract Documents assume existing structures are built to current Municipal and British Columbia Building Code (BCBC) standards, unless otherwise noted. Any existing deficiencies of deteriorated areas are not the responsibility of SYNTHESIS DESIGN, INC., but will be addressed upon their discovery, at the Owners expense.

<u>Div. 1 General Requirements</u>

Summary of Work

-The General Contractor, herein referred to as the Contractor, shall provide all labour, products, plants, equipment and materials required to complete the project as described in the —Sub grade under paved areas is to be well drained and compacted to 95% standard proctor —Provide blocking, backing and bracing for doors, stairs, railings, cabinets, wall fittings and Contract Documents -The Contractor is to be responsible for all taxes, licenses, bonds, insurance for fire and

liability, WCB coverage and all municipal and engineering inspections -The building permit shall be posted in a prominent location and the municipally approved drawings protected from the elements and on site at all times. —The Owner retains the right of access and occupancy during construction and / or prior to final completion but will maintain the Contractor's ability to execute the prescribed work. -Care must be taken to ensure safety of the public and adjoining properties at all times.

<u>Coordination and Supervision</u>

-PAPOVE PROFESSIONAL LAND SURVEYING, INC. (604-464-5199) will be retained as the Surveyors, unless otherwise noted.
-FNG STRUCTURAL ENGINEERING (604) 902-0311 will be retained as the Structural Engineers, unless otherwise noted. -All construction, materials and workmanship shall conform to current WCB & BCBC

—The Contractor shall take adequate and reasonable precautions to protect the public from hazards and dangers arising from all operations. -The Contractor will ensure that all trades observe all local construction and noise regulations; ensure also that all preceding or adjacent work enables continuation or subsequent trade work

-The Contractor shall distribute all Consultants' reports, drawings, schedules, etc. upon receipt. -The Contractor shall ensure fulfillment of all requirements within the Consultants' reports, drawings, schedules, etc., and arrange appropriate municipal inspections.

Field Engineering

-The Contractor will verify all grades and property lines as established by the Owner and report any errors or inconsistencies to SYNTHESIS DESIGN, INC. before commencing work. -The Contractor is to check and verify all dimensions and conditions on the drawings and jo site prior to construction and report any discrepancies to SYNTHESIS DESIGN, INC. — written dimensions have precedence over scaled dimensions.

Quality Control

—The Contractor shall arrange all inspections, municipal and provincial, obtain form work and foundation surveys, and advise the Engineers of construction progress, specifically enabling them to view form work 24 hours before pouring concrete. —The Contractor shall coordinate all storm, sanitary and water main work with the Municipal Works Department, as required by the Municipal Engineering Department.

The Contractor shall issue a one-year warranty against defective materials and workmanship plus an additional five years against major structural defects. -All materials, species, grades, colours, and finishes are to be approved by SYNTHESIS DESIGN, INC. and / or Owner, with samples to be provided on request, prior to ordering.

Construction Facilities & Temporary Controls

-The Contractor shall provide municipal water and sewer connections as required by the Municipality, as well as temporary water, power, light, heat, telephone, sanitary facilities and first aid as may be required during construction.

<u>Material and Equipment</u>

-The Contractor shall protect all materials, executed work and the site from damage by the elements, the public or any other source and shall repair or replace an item or work so

Contract Close-Out Procedures

-The Contractor shall maintain a continuously clean work site and provide a final professional clean up of glass, painted surfaces, floors and fixtures. All stains are to be removed and scratched or broken glass replaced. -All ducts, furnaces and air exchange systems to be professionally cleaned.

-Deficiencies and defects are to be corrected within 30 days of Substantial Performance Those items incomplete will be undertaken by the Owner with costs deducted from the final

payment.

—All bid and construction sets of contract documents are to be returned to SYNTHESIS DESIGN, Thin Stone Veneer INC. at completion of work.

Div. 2 Sitework

Subsurface Investigation

—Standard penetration tests such as drilling and subsurface investigations are the responsibility of the Contractor and are to be carried out by trades experienced in such work.

Demolition

-The Contractor shall remove and dispose of all materials pertaining to the work, including a masonry chimney. -The Contractor shall remove and store on site any items as indicated by the Owner. The Contractor shall ensure that the alteration or removal of existing structures and services will not alter or endanger those to remain which may require shoring, underpinning and / or

—The job site must be clean, and any debris left on site must be placed in locations (as approved by the Owner) to maintain safe conditions for the Owners, Contractor, and Sub-

Site Preparation

work and performed in a manner that avoids unnecessary loss, damage, or disturbance to the

-Materials shall be handled and stored according to local regulations. Dewatering (if applicable)

-The Contractor will provide trenches, piping and holding ponds necessary to control site drainage during construction —The Contractor shall provide concrete sump(s) as required by the Municipal Engineering

Department and / or Geotechnical Engineer to deal with existing and added perimeter drainage -The Contractor shall provide a rock pit as required by the Municipal Engineering Department and / or Geotechnical Engineer to deal with existing and added perimeter drainage and rainwater run off.

<u>Earthwork</u>

-Contractor to follow municipal regulations for dealing with sediment and erosion (refer to sediment and erosion plan where applicable) -Excavation for footings is to be at least 18" below grade to solid bearing and remain so until the concrete is in place.

-Unexpected soil conditions are to be reported to the Engineer before start of form work. -Excavate to required levels for footings and finish grades as required, making allowance for perimeter drains, required form work, wall coatings and thickness of base and surfacing material specified.

-Footing base shall be firm, clean and free of mud and water; rock bases to be washed and dirt free with grouted pins as per Engineer and / or <code>BCBC</code> -Excavate to required dimension and pitch of any trenches and pits for all mechanical, olumbing, sewage, electrical, communication and gas services.

-No backfilling shall be done until all form work has been removed, walls coated, and drain lines viewed by the Engineer, and approved by the Municipal Inspector. -Backfill against cast—in—place concrete only after 14 days with joists in place and coatings

-Backfill material shall be frost free and contain no discarded building or organic material -Provide and place any additional subsoil, fill or gravel required to bring existing grades to finish arades indicated:

such material shall be of acceptable low moisture content, applied in 1' (300 mm) layers, and

-Provide continuous positive slope around the entire building.

Paving and Surfacing

-Saná base courses to be clean and free of deleterious material and compacte -Broom finish surfaces are to be poured as 100 mm (4") reinforced slab or 50 mm (2") topping. Use 10 mm (3/8") maximum round washed aggregate and distribute evenly. Retardant and / or water wash, as required.

-Finished landscaping - including screened topsoil, sod, and plants - are not included in -All finished landscape work to be coordinated by the Owner following the completion of the Provide as per Structural Drawings. -Existing plants and topsoil are to be stripped from the construction area, stored in an Owner <u>Manufactured Wood Trusses</u>

approved protected area. -All trees and shrubs outside the essential excavation shall be preserved and protected against —Provide as per Truss Manufacturer's drawings (c/w 9" raised heel, as required) confirm slope and heel depth on site.

-Form work shall be constructed to dimension and profiles shown, properly braced to maintain -Provide moldings, as specified on Finish Schedule (if applicable position and shape during and after pour to prevent leakage of concrete. -Forms shall be moistened just prior to concrete pour.

-Maximum deflection permitted: 6 mm (1/4) for columns, or as per Engineer.

Concrete Reinforcement

-Reinforcing steel shall comply with CSA specifications for intermediate grade (40) bars. All bars shall be deformed according to ASTM A305. -All reinforcing steel shall be firmly positioned and secured against displacement, by chairs, spacers and hangers.

<u>Cast-in-place</u> Concrete

-Standard concrete shall be machine mixed from clean and properly graded aggregates, clean <u>Counter Tops - Refer to Interior Design specifications</u> water and Portland Cement, and shall have a strength at 28 days of 21 MPa (3000 psi) min. for reinforced concrete, or as per Engineer. -Concrete shall be deposited, vibrated and compacted so as to prevent honeycombing or

-Plain and reinforced cast in place concrete for foundations and building structure shall onform to CAN3-A23.1 & A2'3.3. -Top of sills to be true and level surface; grouting as required. -Pad footings are required as per Structural Engineer.

-Notice shall be given prior to the pouring of slabs to allow trades to position their work. -Lay concrete slabs, reinforced as shown, with necessary expansion and control joints, screed - Engineer. —Thoroughly float before final set, steel trowel to a hard, smooth finish. (Do not dust with cement before troweling).

Concrete Accessories (as per Structural Engineer)

-Embed 1/2" anchor bolts for sills at 1.2M, 4'-0" o.c., unless noted, minimum two bolts per 8321. Contact Scott at scott@optimumstudios.com -Anchor posts to footings to resist uplift, as per the Structural Engineer. -Other concrete reinforcing, dowels, shoes and connections for columns etc. shall be supplied more than 6 feet above the finished ground level) & 36" interior. and installed as detailed.

Concrete Curing

-Ensure that weather conditions will not alter concrete mixture or curing. -All concrete shall be left in forms for three days and kept moist for seven days.

-All thin stone veneer to be installed as per manufacturer's specifications. -Provide thin stone veneer as per elevations -Thin stone veneer to be applied on existing brick masonry as per manufacturer's

-Provide concrete cap as per elevations and sections. -Provide wall flashings at all horizontal intersections of differing materials.

and an additional 1" for every 2" in elevation above 1'-

specifications, confirm with Owner.

-Existing utility room chimney to be removed from lower and main floors. Masonry Flues & Chimneys

-Chimney height must conform to BCBC #9.21.4.4 — A chimney flue shall extend not less <u>1. Attic Space:</u> above the highest point at which the chimney comes in contact with the roof, and not less than 2'-0" above the highest roof surface or structure within 10'-0" of the chimney. -Uniformly distribute roof ventilation to 1/300 of insulated ceiling area with minimum 50% at water-based enamel in Kitchen's, Bathrooms and Laundry Rooms. Provide a minimum of 2" clearance between chimney and combustible framing. Refer to -Provide a minimum of 4" clearance between fireplace and combustible framing. Refer to

-Masonry fireplace hearths to conform to BCBC #9.22.5.1 -Fireplaces shall have a non-combustible hearth extending not less than 1'-4" in front of the <u>2. New Exterior Walls:</u> ireplace opening and not less than 8" beyond each side of the fireplace opening except: —Site preparation, tree cutting, excavation, trenching for services, backfill and rough grading are where the hearth floor is elevated more than 6" above the hearth extension, the width of the —All exterior 2x6 wood framed walls are to receive R—24 insulation. hearth extension shall be increased by 2" for an elevation above 6" and not more than 12

-The walls of any chimney or flue pipe shall be constructed to be smoke tight and flame

<u>Div. 5 Metals</u> Structural Steel

-All nails, spikes, screws, bolts, plates, fasteners, and brackets to be in accordance with -All hangers and saddles to be sized to suit the intended load.

—Shop drawings are to be submitted for all metal work and other specified work upon request —All added roofing to be installed over approved roofing underlay, in a professional manner, by of SYNTHESIS DESIGN, INC. -Structural hardware to be shop primed or hot dipped if in contact with water. -All paint metal work to be coated with rust proof paint or powder coating. -See Structural Drawings for steel beam sizes and details, if necessary.

3. Renovation of Existing Walls:

Shingles and Roofing

<u>Fabricated Metal & Aluminium Rails</u>

Div. 6 Woods & Plastics

work of other trades

and local codes.

as per Engineer.

Standards

-Exterior guard rails to be minimum 42" -. Refer to BCBC 9.8.8.3.

Supporting wood posts to be 6x6 minimum as per Structural Engineer

imum 1" standoff height above concrete, as per Structural Engineer

(Timberlinx® by Beere Timber Co. "or equivalent), as per Structural Engineer.

-Provide cross bridging at maximum of 7'-0" o.c. for roof and floor joists.

-Provide min. 30 mil. vinyl decking, as per Interior Design specifications.

Finish Carpentry - Refer to Interior Design specifications

two finish coats of semi-gloss latex paint.

a professional manner.

Millwork - Refer to Interior Design specifications

preservative and bear on rolled foam gasket.

Div. 7 Thermal & Moisture Protection

and floors as per local municipal codes.

top of roof and minimum 50% in soffit vents.

-Attic or roof spaces to receive R-50 insulation.

Waterproofing

Damp Proofing

-The Contractor shall provide lumber, plywood, fasteners etc. for framing and coordination of

All lumber to be SPF and all sheathing shall be plywood — grades shall conform to BCBC

Exposed wood columns shall have concealed knife blade style post base connectors c/w

All subfloor sheathing to be 3/4" tongue and groove plywood, glued and screwed to joists.

-Exposed wood beams shall be connected to columns with internal metal connectors

-Stair handrails to be located between 34" & 38" above the nosing of each tread

-Truss layout to be confirmed by SYNTHESIS DESIGN, INC. and Owner prior to ordering.

-Provide kitchen cabinets, built in units, washroom vanities as indicated on drawings. -All cabinets to be approved by SYNTHESIS DESIGN, INC. and installed in a professional

-All added door and window frames are to be within 1/16" of finish wall to accept casings.

-Installed moldings to be caulked with appropriate coloured, paintable latex caulk and receive

-Do not deliver, store, or install finish cabinets or trim until building is fully enclosed, heated,

-Coordinate work of kitchen, bathroom and storage cabinets / organizers with related trade.

-Any lumber likely to come into contact with water shall be pressure treated with approved

-Provide treated sleepers when adding sub floor systems in Basements and crawlspaces.

-Provide railings / guards for ėxterior decks — see drawings for details

-Ceramic / slate tile or equivalent required to bathroom floors.

-Provide rolled foam sill gaskets between wood sill plates and concrete sills.

-Provide minimum 1" clearance between top of roof joist and insulation BCBC #9

-Provide minimum 2.5" clearance between roof sheathing and insulation BCBC #9.19.1.3

-Fire separation required for attic spaces exceeding 65' maximum length for a concealed space as per BCBC #9.10.16.1. (6)

framed or furred out to 2x6, with minimum R—24 insulation. Report to SYNTHESIS DESIGN,

-Supply and install architectural series fibreglass laminate shingles on roof - match existing.

-Existing roofing material to remain and all new overhangs to match existing conditions, c/v

) Manufacturer's Material; 2) Roofing Contractor's Labour, and; 3) Third Party Association

-Railings to be supplied and installed by Optimum Studios Architectural Glasses (604) 321—

-Guard rails to be minimum 42" exterior (where the walking surface served by the guard is

Fechniques, fastening, blocking, fire stops, bracing and sheathing to BCBC Residential

-Provide vented, closed, flat soffits, as per drawings. -Provide vinyl venting soffits strips to run parallel to exterior walls. -Provide tight knot štain grade t&g v-groove cedar soffits. -Soffits to have two coats of oil-based stain.

INC. and / or Owner prior to commencement of the work.

Cladding and Siding

-Provide tight knot vertical cedar cladding c/w exposure to match existing, as required. See Appliances —Supply and install 42" high aluminium guardrails c/w tempered glass panels (see drawings drawings for locations. -All wood cladding to be pre-primed (4 sides) with one coat primer and installed over 2 —Guard rail protrusions must be greater than 17.75" apart horizontally and vertically to prevent climbing — Refer to BCBC 9.8.8.6(1). layers of approved 30-minute building wrap.

Pre-primed exterior trim to have one finish coat of enamel.

—Be sure to stagger the joints of all added cladding that abut existing cladding and cut all ioints @ 45 degrees. —All horizontal šiding corner joints to be mitred (NO CORNER BOARDS) -Caulk unprotected seams and openings with appropriate coloured latéx or silicone.

—Provide two finish coats of exterior paint to cladding following installation and caulking -All acrylic stucco cladding to be installed over two layers of approved 30-minute building wrap, c/w expansion joints as required. -Provide 8" clearance between grade and siding or acrylic stucco.

-Re & re any wood cladding portion which is rotten or in poor condition, to match existing.

-Provide approved rain screen assembly for all new cladding applications (see drawings for details). Confirm assemblies with municipal regulations.

-Provide pre-primed (4 sides) combed faced spruce 2x8's @ facias. -Provide pre-painted (4 sides) S4S cedar: 2x door and window trims c/w canted sill and aprons to match existina. -Twisted, misaligned or structurally inadéquate fráming mémbers to be replaced prior tó finish

Flashing and Sheet Metal

Roof Specialties and Accessories

-Provide continuous flashing: at all edges for wind and watertight installation; over all exterior windows and doors and at all horizontal intersections of differing cladding materials. -Curved stairs and stairs 43" in width or greater require two handrails as per BCBC #9.8.7. -All roof flashings, caps and fittings to match colour of roofing as close as possible

> -All new gutters are to be c/w screened rainwater leaders, unless noted. Locations to be confirmed by Owner.

Div. 8 Doors, Windows, Glazing & Mirrors

-See 'Door Schedule' on drawings.

-Before the door order is placed, the Contractor is to measure on site to confirm whether or -HRV system to be installed as per manufacturer. -Contractor to note placement of new skylights, bulkheads, coffers and peaks prior to ordering not any existing or proposed openings require a custom sized door.

-Ensure that every door has 2.5" minimum of framing material around the entire door jamb. -All exterior doors to have solid blocking (vertical and horizontal), for two stud spaces, both sides at locking height so that the jambs will resist spreading by force.

-All exterior wood doors to be stain grade solid core c/w weather stripping -All interior doors to be paint grade, solid core. Owner to approve style. and interior doors, including: dead bolts with a cylinder not having less than 5 pins and a bolt the drawings, please report to SYNTHESIS DESIGN, INC. prior to installation. throw not less than 25 mm operable from the interior without the use of keys; strike plates fastened to wood frames with wood screws providing a minimum 25 mm penetration into wood studs on all exterior swinging doors, and locking passage sets on interior bathroom

-Operable glass wall systems to be supplied by NanaWall Systems, (604) 897-8444. Contact Stewart at stewartm@nanawall.com -Glazing in all added doors to be tempered and double glazed (exterior doors only), as per municipal codes — ensure that tempered glass displays manufacturer's authentications. -All new exterior doors to achieve and / or exceed performance grade 30 and Water Penetration Resistance Test Pressure of 290 Pa as per BCBC #9.7.4.3. (1).

-All counter tops and backsplashes to be approved by SYNTHESIS DESIGN, INC. and installed in -Contractor is not to order windows until all rough openings are approved by Owner. -Final style, colour and material of windows are to be approved by Owner. -All vinyl windows shall be double glazed with double thermal break or as per municipal codes unless noted. -All windows to be supplied with exterior sills to match existing and pre-painted on both sides -All receptacles, switches, and plates as per Owner (or match existing conditions). with one colour. -Glazing to be float in windows, with oversized windows to conform to BCBC #9.7.3.2. -Protect exposed beams and structurăl elements from water damage; clean or replace as per provide manufacturer's specifications. -All new windows to achieve and / or exceed performance grade 30 and Water Penetration rovide treated studs — c/w 0.5" air space — when furring out concrete walls in Basement. Resistance Test Pressure of 290 Pa as per BCBC #9.7.4.3. (1).

-See 'Window Schedule' on drawings. Glazing & Mirrors - Refer to Interior Design specifications

-All mirrors to be approved by Owner and to be installed by a qualified glazier. -Glass doors and partitions around showers are to be tempered glass.

-Guard rails to be minimum 36" exterior (where the walking surface served by the guard is not more than 6 feet above the finished ground level). Refer to BCBC 9.8.8.3.

—Guard rail protrusions must be greater than 17.75" apart horizontally and vertically to prevent climbing — Refer to BCBC 9.8.8.6(1). <u>Gypsum Board</u>

-GWB to walls to be 1/2" (screwed to walls) and installed in a professional manner with a minimum of 3 coats of mud -All ceilings to be smooth painted finish, unless otherwise noted. -5/8" or C.D. 1/2" drywall required to ceiling members at 24" o.c.

<u>Tile - Refer to Interior Design specifications</u>

-All ceramic/slate tiles to be approved by Owner and installed in a professional manner.
-Çeramic/slate tile flooring to be set on minimum 1.25" (3/4"+1/2") t&g plywood subfloor c/w thin set base, unless noted. -Ceramic tile tub and shower surrounds to be mounted on 1/2" Dens Shield Tile Backer, or

Wood Flooring - Refer to Interior Design specifications

-Thermal insulation located and sized as per drawings; use mineral wool batts for roof, walls -Refinish all flooring throughout the main floor. —Supply and install hardwood flooring where floor needs to be patched, match existing. See —Provide continuous fully caulked 6 mil U.V. poly vapour barrier around entire building envelope, finish schedule for locations (if applicable). including below all concrete slabs as per BCBC #9.25.4

<u>Painting - Refer to Interior Design specifications</u>

—All interior paint to be BENJAMIN MOORE (or equal) — colours approved by Owner and applied in a professional manner. —'All interior walls to have one primer coat and two finish coats of eggshell latex — provide -All pre-primed interior trims and doors to have two finish coats of semi gloss latex.

Wall Coverings - Refer to Interior Design specifications

-All wall coverings to be approved by SYNTHESIS DESIGN, INC. and installed in a professional

Div. 10 Specialties

Fireplaces and Stoves -If drywall is removed from an existing exterior wall, the wall assembly and insulation may be required to be brought to current building code requirements. Existing 2x4 walls shall be re—

-Supply and install gas fireplace c/w thermostat and trim - See drawings for specifications. —Manufactured gas fireplace and flue to conform to #9.22.8 of NBC and to be installed in accordance with manufacturer's installation instructions and CAN / ULC S 610 standard for factory-built fireplaces. -Mantel height and width to conform with fireplace unit's installation instructions.

-Provide 1/2" fibre cement board as protection under non-combustible hearth finish.

Maintain minimum 2" clearance between metal flue and combustible framing.

Storage Shelving

-All shelving as per closet organizer supplier. -Contractor to ensure that roofing contractor will provide Owner with copies of all warranties,

Wardrobe and Closet Specialties

-All shelving as per closet organizer supplier.

Div. 11 Equipment

-Allow for Owner supplied kitchen appliances (if required). -Provide required ducting for range hood vents and dryers where necessary.

Div. 12 Furnishings

Bookshelves - Refer to Interior Design specifications

-All bookshelves to be approved by SYNTHESIS DESIGN, INC and installed in a professional

Div. 14 Plumbing

Water Supply & Drainage Waste

-Supply and install copper piping / PEX tubing for water supply as required. Supply and install copper water supply piping to Owner supplied Refrigerator in Kitchen. Supply and install plastic drainage waste and vent piping as required. -Install plumbing drops and venting within the walls, ceilings, and designated bulkheads i applicable. If additional bulkheads or dropped ceilings are required for the drops and venting that are not shown on the drawings, please report to SYNTHESIS DESIGN, INC. prior to

Plumbing Fixtures - Refer to Interior Design specifications

-Supply and install fixtures (to be confirmed with Owner). See drawings for locations. Toilet and Bath Accessories

—Install Owner supplied bathroom accessories including toilet paper holders, soap dish and grab bars, towel rails (minimum 1 per room).

Div. 15 Mechanical (as per Mechanical Contractor)

-Replace gas forced air mechanical for: 2 stage electrical high efficiency forced air system. Replace gas water heater for: High efficiency electric hot water tank.

Verify the adequacy of the heating system to accommodate the proposed residence. —The Contractor shall ensure that all heating systems are functioning, adjusted, and balanced with the operation, maintenance, and warranty documents provided to the Owner. A list of trades, suppliers and material order numbers will be included wherever possible (if applicable) -Supply and install grilles, registers and diffusers, as required. Install HVAC ducting and venting within the designated bulkheads if applicable. If additional— -Contractor to install Owner supplied hardware (including astragals and hinges) for all exterior, bulkheads or dropped ceilings are required for the ducting / venting that are not shown on

ovide continuous or intermittent exhaust fans in all bathrooms and Kitchens as per #9.32.3.3 c/w ducting as required, to be vented directly outside — all washrooms are to be fitted with "silent" NU—TONE 'QT130' fans (or equivalent) sized to suit.

—Allow for Owner supplied hood vent / OTR micro in kitchen c/w ducting as required, to be vented directly outside. -Ensure HVAC system, gas fireplaces, washroom exhaust fans, kitchen hood vents, etc. are all balanced and sized to enable the proper exhausting of carbon monoxide and other toxic

Div. 16 Electrical

Basic Electrical Materials & Methods

Refer to electrical drawings / reflected ceiling plans where applicable. -Ground fault interrupter circuits required for kitchens, bathrooms, laundry rooms, and all

—Verify the adequacy of the power supply to accommodate the entire house.

Service & Distribution

-Confirm lighting layout on site with Owner prior to installation.

-Separate breakers required for outdoor lighting.

<u>Heating</u>

-Provide NU-HEAT electric heating pad under tiled floors c/w thermostats as indicated on

ON e. **7** 9 a 조두 <u>></u> ഗ $\overline{\mathbf{m}}$

 $\mathbf{\Omega}$

REVISIONS | # | B

opyright reserved. Al

ontents of this drawir

are the exclusive prope

of Synthesis Design Inc

and shall not be used

eproduced without the

onsent of the Designe

l dimensions shall be

mmencement of world

258 east 1st street

north vancouver, bc

canada V7L 1B3

tel. (604) 980-2087

vww.synthesisdesign.ca

verified on site prior to

Drawing Title SPECIFICATIONS


Date 1.03.2023


Drawn PGS

Sheet A-2

Job No. 22011

Of 10

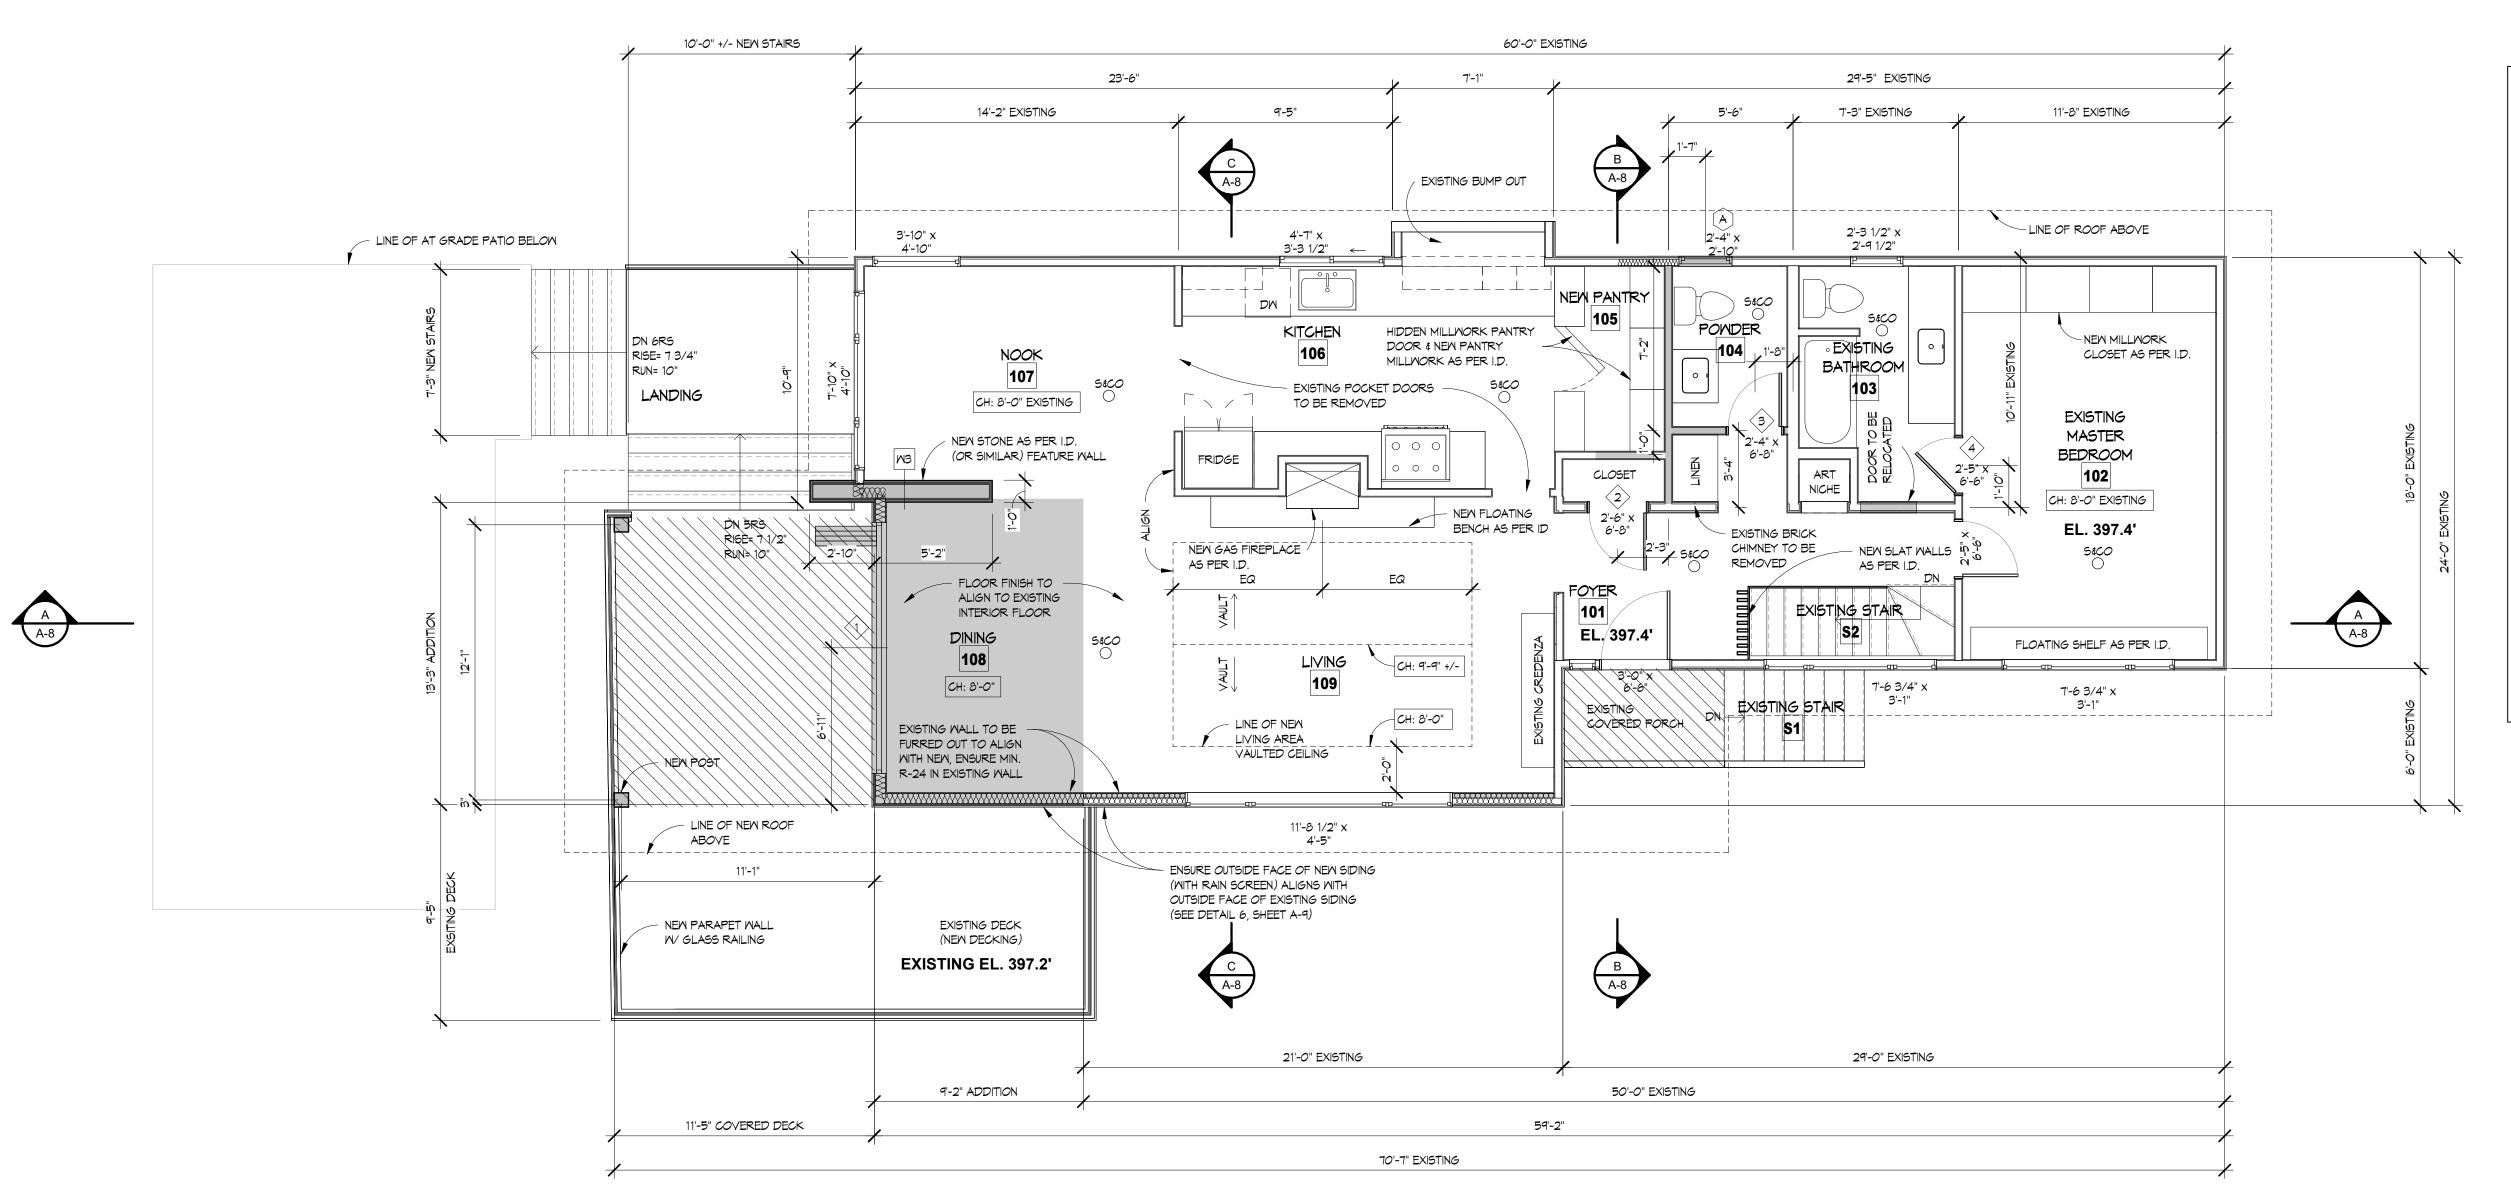

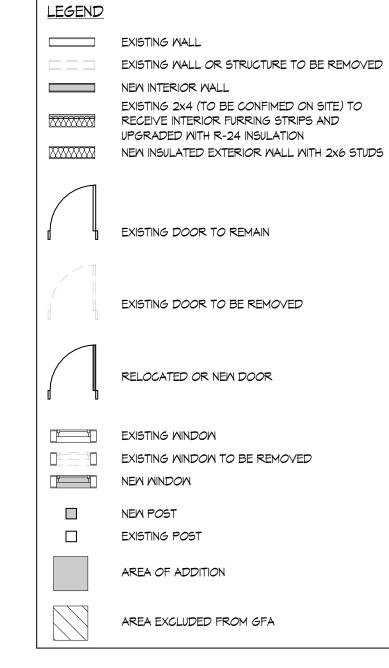

- ALL DOOR & WINDOW HEADER HEIGHTS ON MAIN FLOOR TO BE 6'-8" (MATCH EXISTING) EXCEPT DOOR "1" TO BE 7'-2"
- IF ADDITIONAL BULKHEADS OR DROPPED CEILINGS ARE REQUIRED FOR DUCTING / VENTING WHICH ARE NOT SHOWN ON THE DRAWINGS, PLEASE REPORT TO SYNTHESIS DESIGN PRIOR TO INSTALLATION
- IF DRYMALL IS REMOVED FROM AN EXISTING EXTERIOR WALL, THE WALL ASSEMBLY & INSULATION MAY BE REQUIRED TO BE BROUGHT TO CURRENT CODE STANDARDS. PLEASE REPORT TO SYNTHESIS DESIGN PRIOR TO THE COMMENCEMENT OF WORK

Drawing Title MAIN FLOOR

REVISIONS # BY

contents of this drawing are the exclusive proper of Synthesis Design Inc. and shall not be used reproduced without the consent of the Designer All dimensions shall be verified on site prior to commencement of work.

synthesis design inc. 258 east 1st street

north vancouver, bc, canada V7L 1B3 tel. (604) 980-2087 www.synthesisdesign.ca

ADDITION

_

TION Ave.

TY RENOVA

Sutherland A

North Vancouver, BC

McKIBBIN-McLART 1253

Citys Comments 11.18.2022

Date 1.03.2023 Scale 1/4" = 1'-0"

Job No. 22011

Of 10

Sheet A-3

100% COUNTABLE

1/4" = 1'-0"

EXCLUDED FROM GFA CALCULATION: COVERED DECK: 144 SQ.FT (13.38 M2) COVERED PORCH: 30 SQ.FT (2.78 M2)


MAIN FLOOR PLAN


MAIN FLOOR: 1134 SQ.FT (105.35M2)

TOTAL = 1,259 SQ.FT (116.96 M2)

MAIN FLOOR ADDITION: 125 SQ.FT (11.6M2)

Drawn PGS

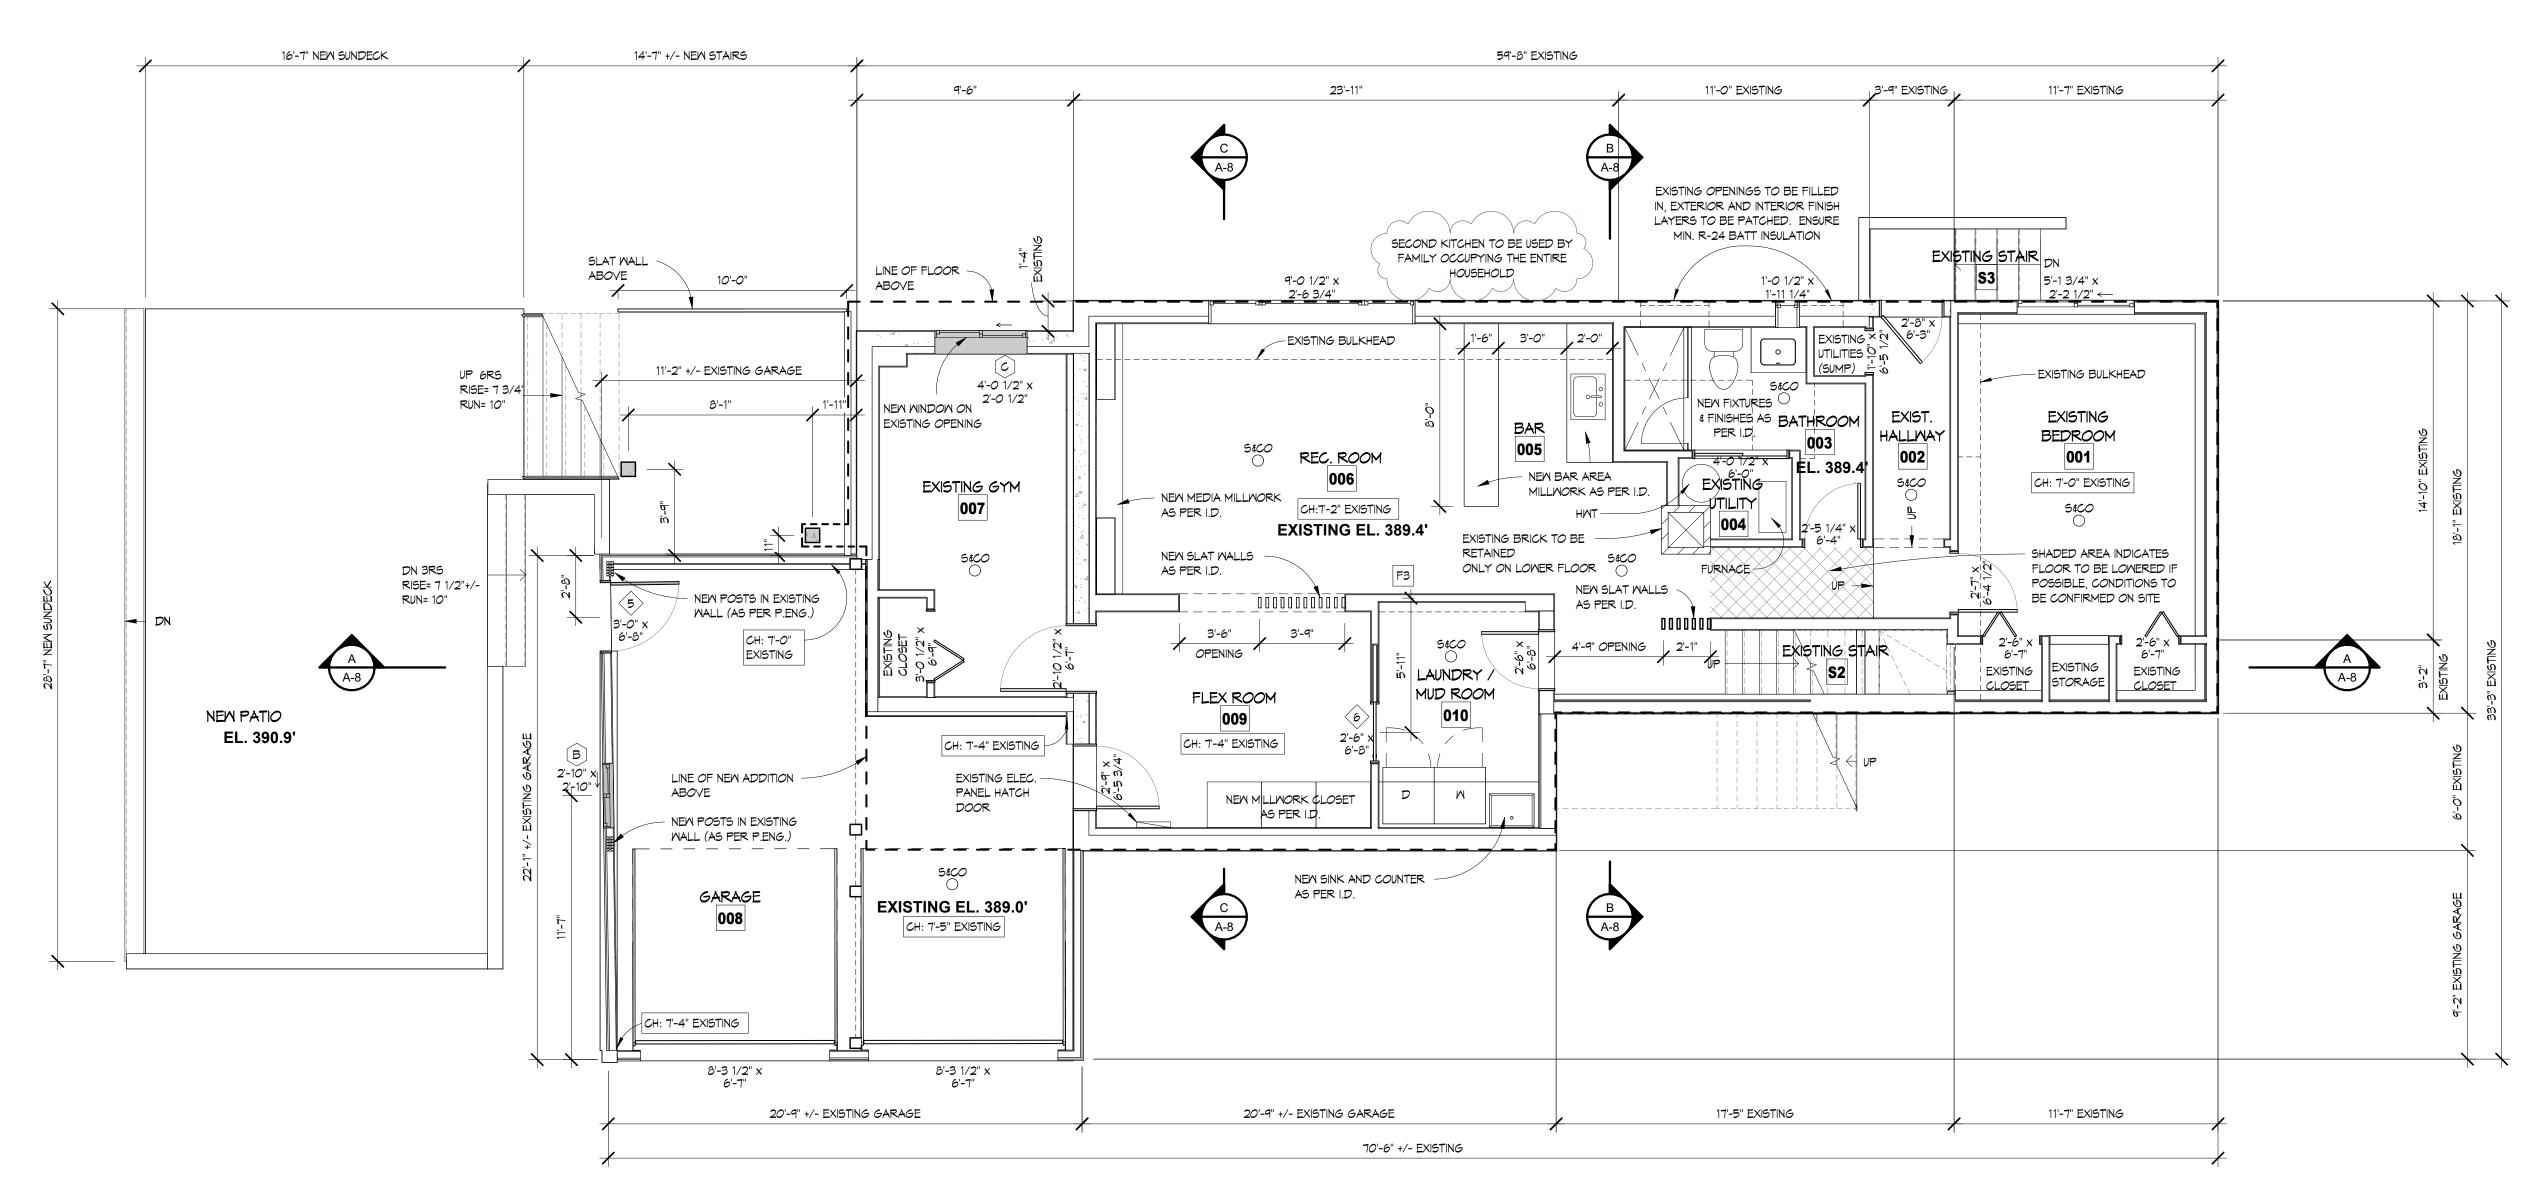

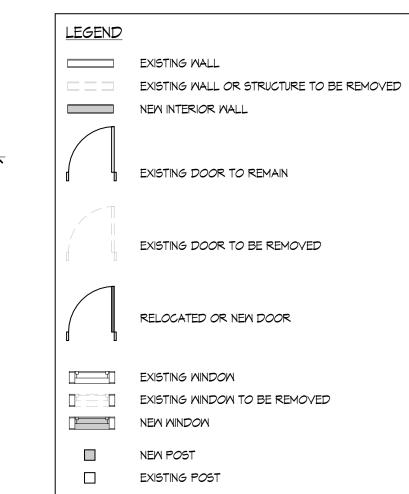

- ALL NEW DOOR & WINDOW HEADER HEIGHTS ON LOWER FLOOR TO BE 6'-8" (MATCH EXISTING) EXCEPT WINDOW "B" TO BE 6'-1".
- IF ADDITIONAL BULKHEADS OR DROPPED CEILINGS ARE REQUIRED FOR DUCTING / VENTING WHICH ARE NOT SHOWN ON THE DRAWINGS, PLEASE REPORT TO SYNTHESIS DESIGN PRIOR TO INSTALLATION
- IF DRYWALL IS REMOVED FROM AN EXISTING EXTERIOR WALL, THE WALL ASSEMBLY & INSULATION MAY BE REQUIRED TO BE BROUGHT TO CURRENT CODE STANDARDS. PLEASE REPORT TO SYNTHESIS DESIGN PRIOR TO THE COMMENCEMENT OF WORK

Drawing Title LOWER FLOOR

REVISIONS # BY

contents of this drawing are the exclusive proper of Synthesis Design Inc. and shall not be used reproduced without the consent of the Designer All dimensions shall be verified on site prior to commencement of work.

synthesis design inc. 258 east 1st street north vancouver, bc, canada V7L 1B3 tel. (604) 980-2087 www.synthesisdesign.ca

ADDITION

TION Ave.

TY RENOVA Sutherland A

McKIBBIN-McLART 1253

Citys Comments 11.18.2022

Comments 01.06.2023

Date 1.03.2023 Scale 1/4" = 1'-0"**Drawn** PGS


Sheet A-4

LOWER FLOOR PLAN 1/4" = 1'-0" TOTAL LOWER FLOOR: 1582 (146.9M2) EXCLUSIONS: 1190 SQ.FT (110.5 M2)

TOTAL: 392 SQ.FT (36.4 M2)

Job No. 22011

Of 10 Sheets

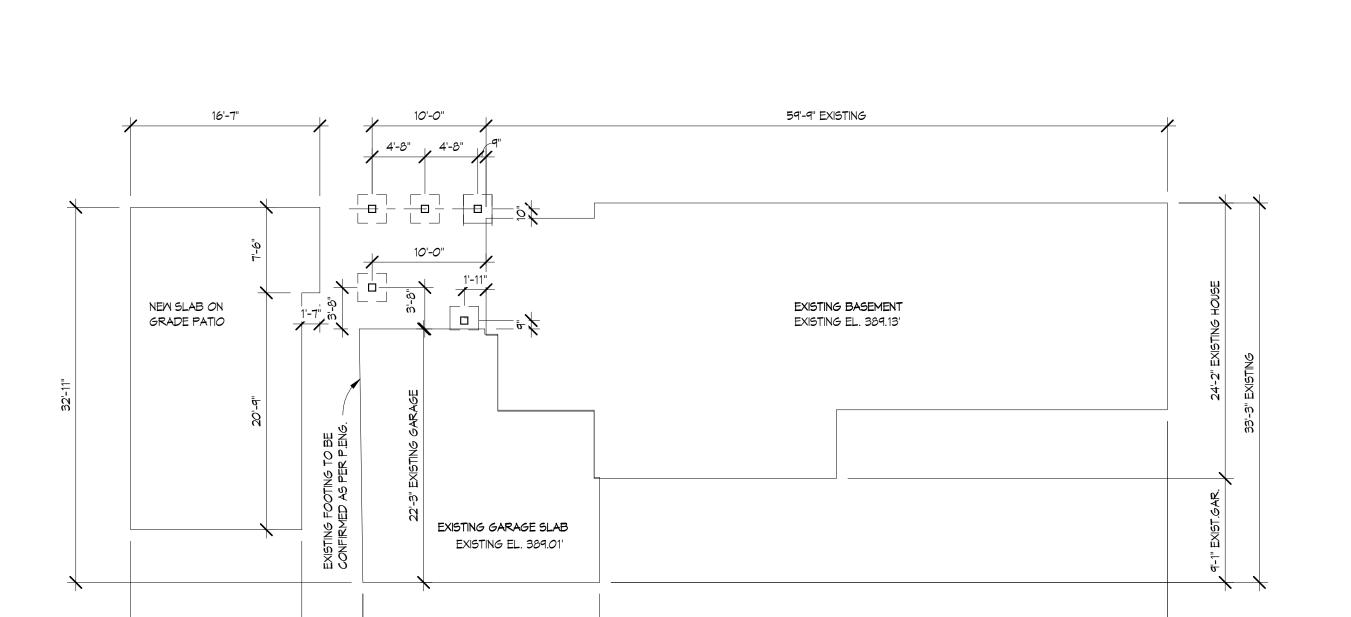

49'-9" EXISTING HOUSE

70'-6" EXISTING




15'-0"


20'-9" EXISTING GARAGE

LEGEND FOUNDATION WALL C/W RIGID INSULATION _ _ _ FOOTING SHADED AREA INDICATES NEW ROOF FOUNDATION NOTES:

1. FOUNDATION PLAN FOR LOCATION ONLY. FOR ALL TECHNICAL INFORMATION REFER TO STRUCTURAL ENGINEER DRAWINGS.

2. ALL SLAB ON GRADE ELEVATIONS TO BE MEASURED TO THE TOP OF CONCRETE.

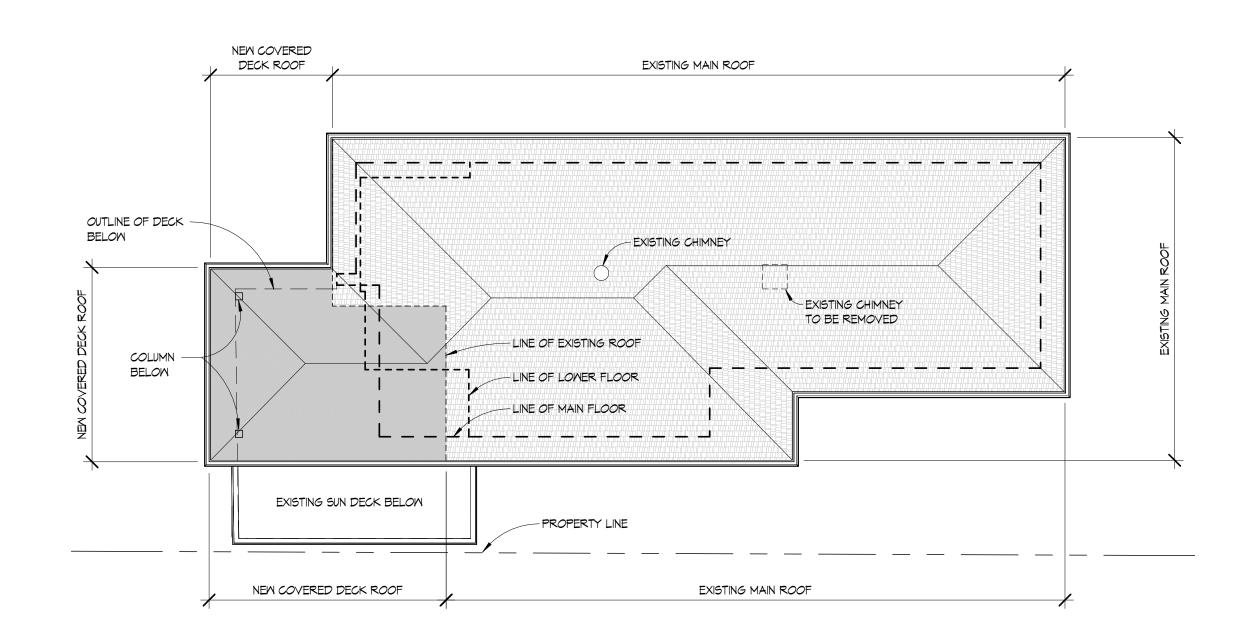

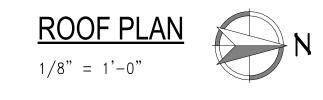

REVISIONS # BY

Copyright reserved. All contents of this drawing are the exclusive property of Synthesis Design Inc. and shall not be used or reproduced without the consent of the Designer.

All dimensions shall be verified on site prior to commencement of work.







ADDITION TION Ave. McKIBBIN-McLARTY RENOVA 1253 Sutherland

Drawing Title FOUNDATION & ROOF PLANS

Date 1.03.2023 Scale 1/8" = 1'-0"

Drawn PGS

Job No. 22011 Sheet A-5

EAST SPATIAL SEPARATION

MATERIAL LEGEND

NEW 2X8 PAINTED COMB FACED SPRUCE FASCIA BOARD THROUGHOUT

NEW 2x12 PAINTED COMB FACED SPRUCE TRIM BOARD (FLASH TOPS)

NEW 1X4 TIGHT KNOT T&G STAIN GRADE CEDAR SOFFIT (STYLE AS PER OWNER) NEW 2 1/2" PAINTED MOOD TRIM AROUND ALL NEW OPENINGS INCLUDING HEAD AND

NEW 2x2 ALUMINUM POSTS C/W HORIZONTAL METAL CABLE RAILING (STYLE AS PER

NEW SEMI-FRAMELESS GLASS RAILING C/W ALUMINUM POSTS AND TEMPERED GLASS

NEW 2x4 CEDAR SLAT WALL, WITH 1" SPACING. PAINTED TO MATCH SOFFIT (AS PER

NEW STAIR C/W 3" THICK STAIN GRADE CEDAR TREADS AND 3x12 CEDAR STRINGERS &

NEW 12" ANODIZED ALUMINUM NUMBERS C/W STAND-OFFS (STYLE AS PER OWNER)

NEW T&G PAINTED VERTICAL MOOD SIDING (MATCH EXISTING)

NEW PAINTED STUCCO (MATCH EXISTING)

OMNER) (CONFIRM WITH BUILDING INSPECTOR)

NEW 8x8 STAIN GRADE CEDAR COLUMN (AS PER P.ENG.)

NEW STONE VENEER FEATURE MALL (STYLE AS PER OWNER)

NEW FIBRE GLASS LAMINATE SHINGLES (MATCH EXISTING)

NEW VINYL FLOORING OVER EXISTING DECK (STYLE AS PER OWNER)

SILL FLASHING (MATCH EXISTING)

NEM 5" GUTTER THROUGHOUT

PANELS (STYLE AS PER OWNER)

OPEN RISERS (STYLE AS PER OWNER)

AREA OF FACE

906 sq.ft. (84.2 m2)

LIMITING DISTANCE 33.6 ft. (10.2 m)

AREA OF OPENING

83.5 sq.ft.

<u>CONFORMS</u> YES

ALLOWABLE OPENINGS

84% x 906 ft.sq. = 761 sq.ft.



REVISIONS # BY

Copyright reserved. All contents of this drawing

are the exclusive proper of Synthesis Design Inc. and shall not be used of

reproduced without the consent of the Designer All dimensions shall be

verified on site prior to

commencement of work.

synthesis design inc. 258 east 1st street north vancouver, bc, canada V7L 1B3 tel. (604) 980-2087 www.synthesisdesign.ca

Citys Comments 11.18.2022 City Eng. Comments 01.06.2023


Drawing Title NORTH & EAST ELEVATIONS

Date 1.03.2023 Scale 1/4" = 1'-0"

Drawn PGS **Job No**. 22011

Of 10

Sheet A-6

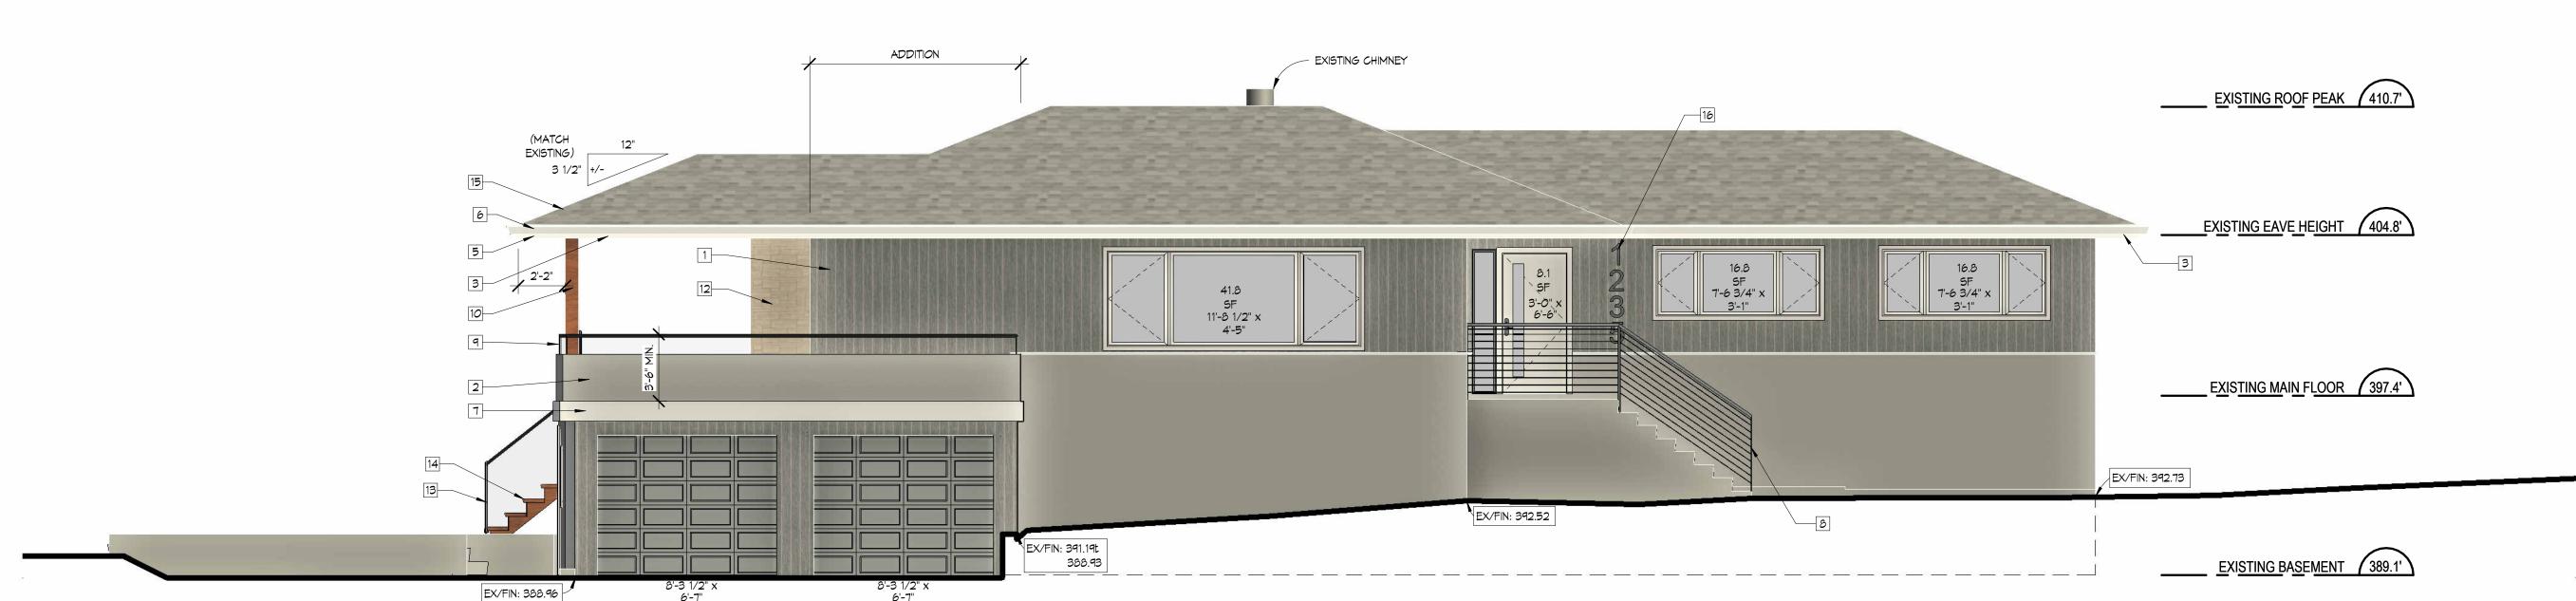

EAST ELEVATION

1/4" = 1'-0"

EXISTING ROOF PEAK 410.7' - PROPERTY LINE PROPERTY LINE -EXISTING EAVE HEIGHT 404.8' EXISTING MAIN FLOOR 397.4' 7 - EXISTING RAILING Y_____ EX/FIN: 392.67 EX/FIN: 392.73 EX/FIN: 392.52 ENSSURE WALKWAY SLOPES MIN. 2% TOWARD THE ROAD EXISTING BASEMENT 389.1'

NORTH ELEVATION


1/4" = 1'-0"

WEST ELEVATION

1/4" = 1'-0"

MEST SPATIAL SEPARATION AREA OF FACE 876.5 sq.ft. (81.4 m2) LIMITING DISTANCE 6.75 ft. (2.1 m) <u>ALLOWABLE OPENINGS</u> 9.5% x 876.5 ft.sq. = 82.8 sq.ft. AREA OF OPENING 66.7 sq.ft.

CONFORMS YES

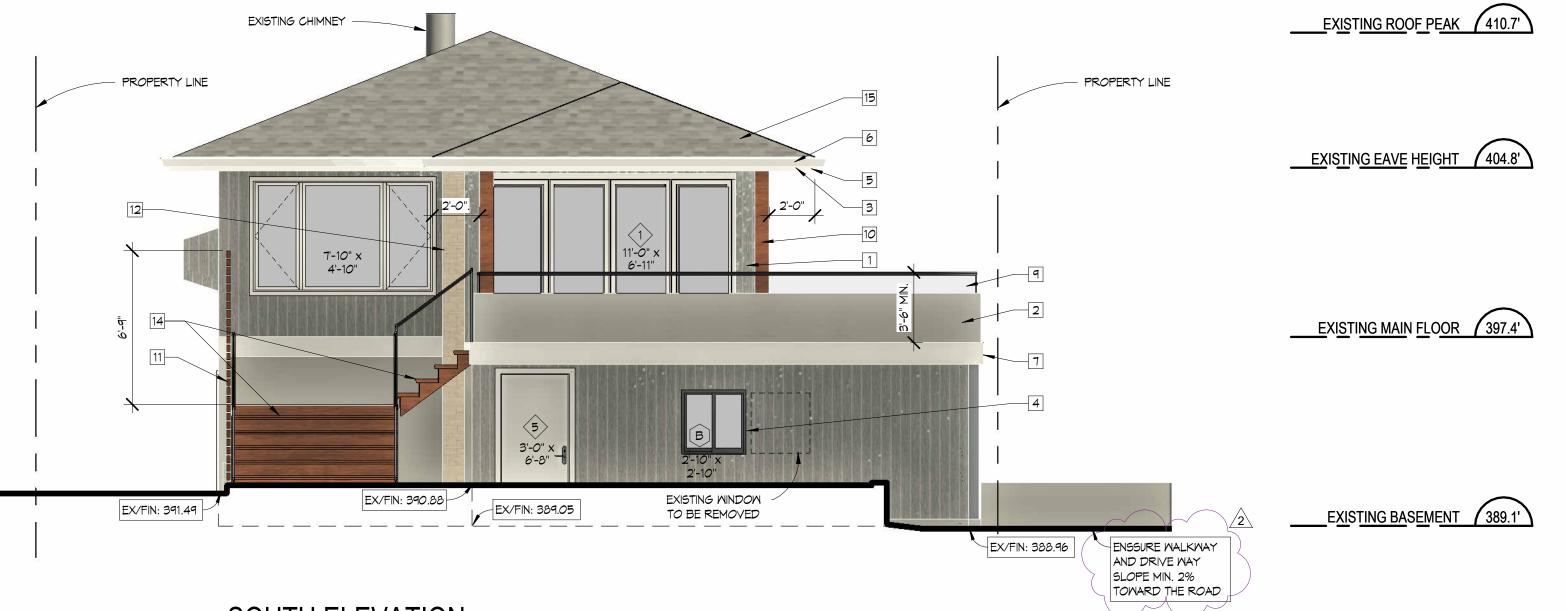

	MATERIAL LEGEND
	NEW T&G PAINTED VERTICAL MOOD SIDING (MATCH EXISTING)
2	NEW PAINTED STUCCO (MATCH EXISTING)
3	NEW 1x4 TIGHT KNOT T&G STAIN GRADE CEDAR SOFFIT (STYLE AS PER OWNER)
1	NEW 2 $1/2$ " PAINTED WOOD TRIM AROUND ALL NEW OPENINGS INCLUDING HEAD AND SILL FLASHING (MATCH EXISTING)
5	NEW 2x8 PAINTED COMB FACED SPRUCE FASCIA BOARD THROUGHOUT
÷	NEW 5" GUTTER THROUGHOUT
1	NEW 2x12 PAINTED COMB FACED SPRUCE TRIM BOARD (FLASH TOPS)
}	NEW 2x2 ALUMINUM POSTS C/W HORIZONTAL METAL CABLE RAILING (STYLE AS PER OWNER) (CONFIRM WITH BUILDING INSPECTOR)
1	NEW SEMI-FRAMELESS GLASS RAILING C/W ALUMINUM POSTS AND TEMPERED GLASS PANELS (STYLE AS PER OWNER)
0	NEW 8x8 STAIN GRADE CEDAR COLUMN (AS PER P.ENG.)
1	NEW 2x4 CEDAR SLAT WALL, WITH 1" SPACING. PAINTED TO MATCH SOFFIT (AS PER OWNER)
2	NEW STONE VENEER FEATURE WALL (STYLE AS PER OWNER)
3	NEW VINYL FLOORING OVER EXISTING DECK (STYLE AS PER OWNER)
4	NEW STAIR C/W 3" THICK STAIN GRADE CEDAR TREADS AND $3x12$ CEDAR STRINGERS OPEN RISERS (STYLE AS PER OWNER)
5	NEW FIBRE GLASS LAMINATE SHINGLES (MATCH EXISTING)

NEW 12" ANODIZED ALUMINUM NUMBERS C/W STAND-OFFS (STYLE AS PER OWNER)

SOUTH ELEVATION

1/4" = 1'-0"

Citys Comments
11.18.2022
City Eng.
Comments
01.06.2023

REVISIONS # BY

Copyright reserved. All contents of this drawing are the exclusive proper of Synthesis Design Inc. and shall not be used a reproduced without the consent of the Designer.

All dimensions shall be verified on site prior to commencement of work.



synthesis design inc. 258 east 1st street north vancouver, bc, canada V7L 1B3 tel. (604) 980-2087 www.synthesisdesign.ca

ATION / ADDITION Ave. McKIBBIN-McLARTY RENOVA 1253 Sutherland


Drawing Title SOUTH & WEST ELEVATIONS


Date 1.03.2023 Scale 1/4" = 1'-0"

Drawn PGS Job No. 22011


Sheet A-7

Of 10 Sheets

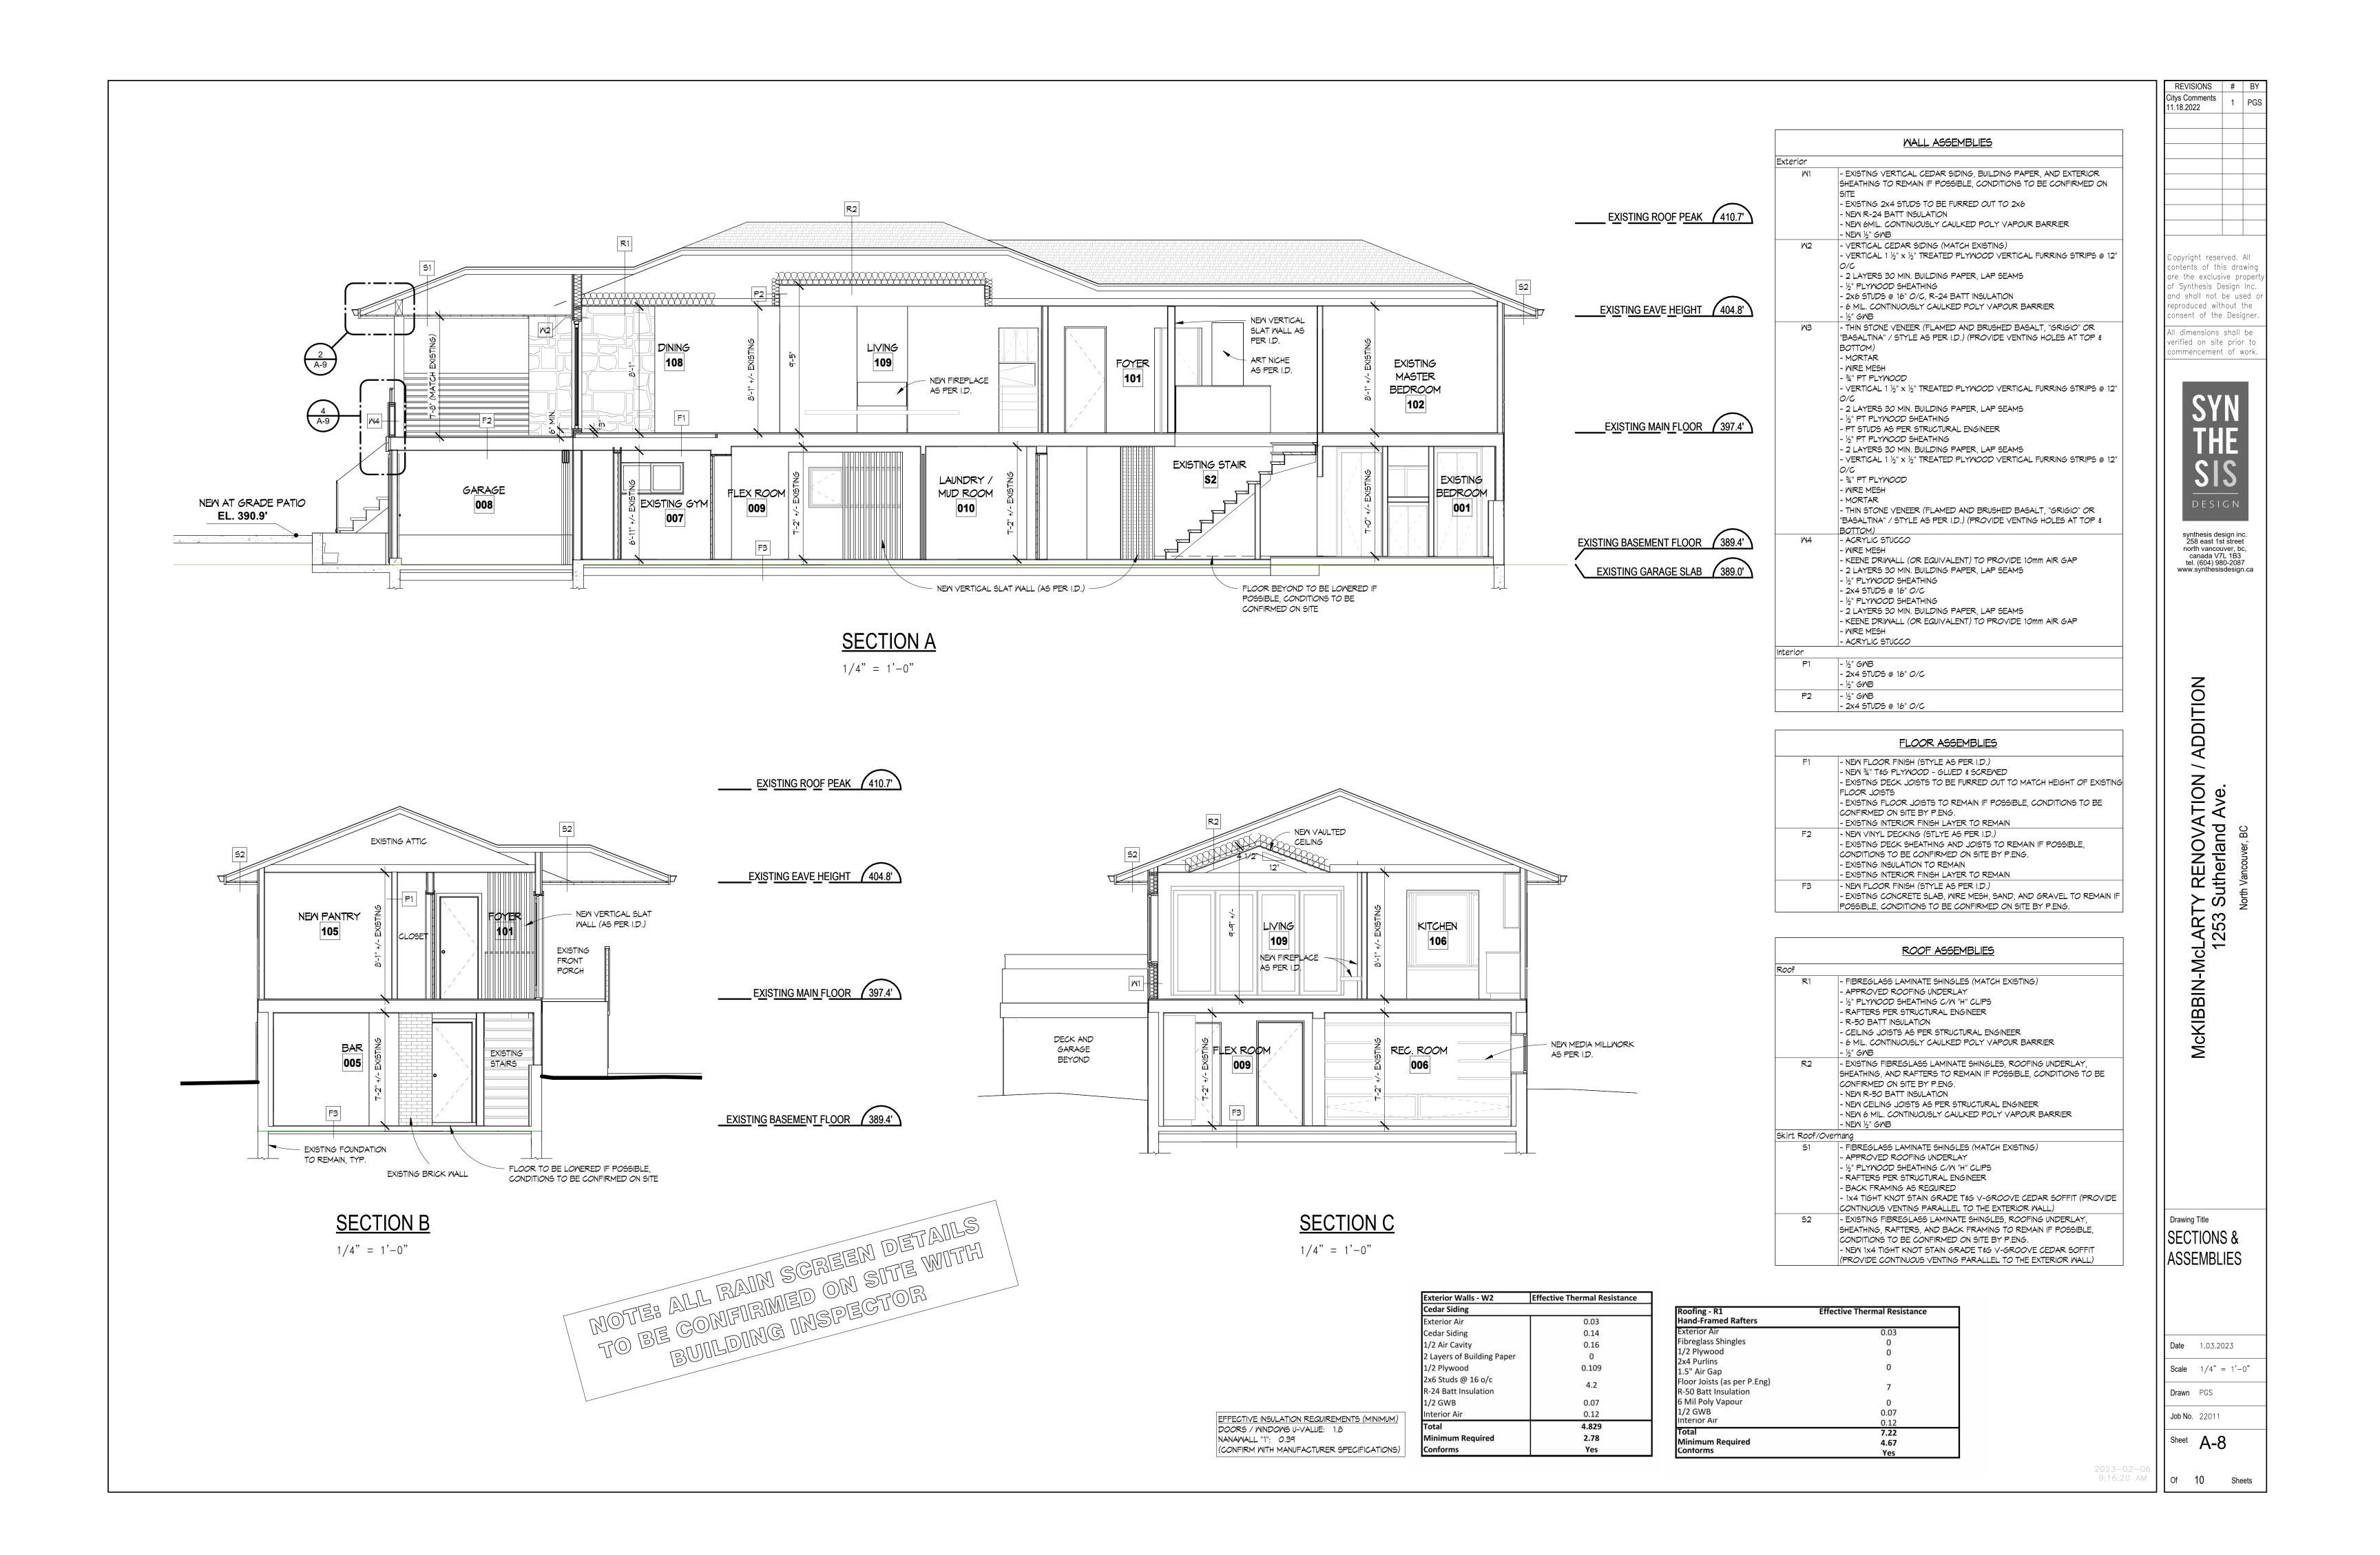


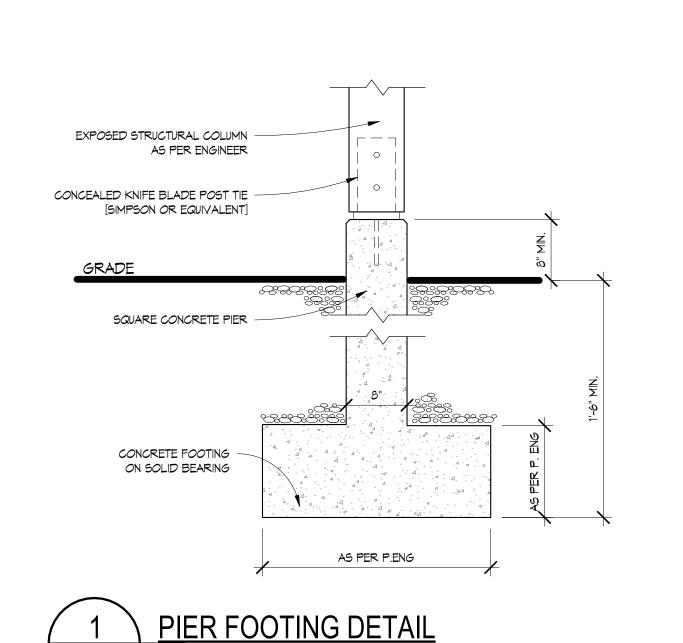


1" = 1'-0"

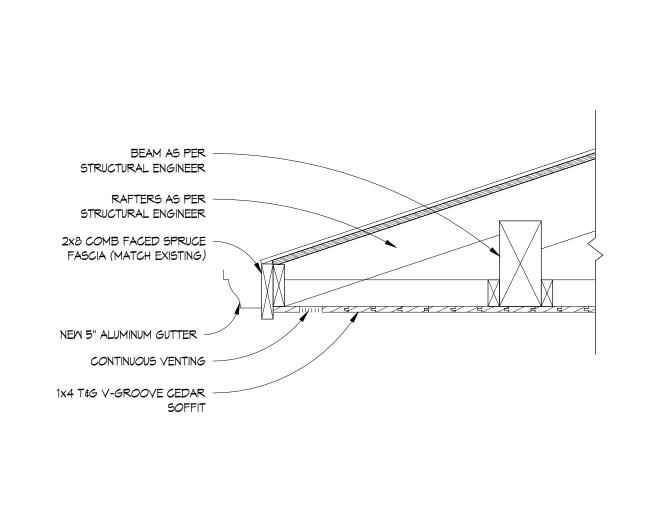

ROOF VENT DETAIL

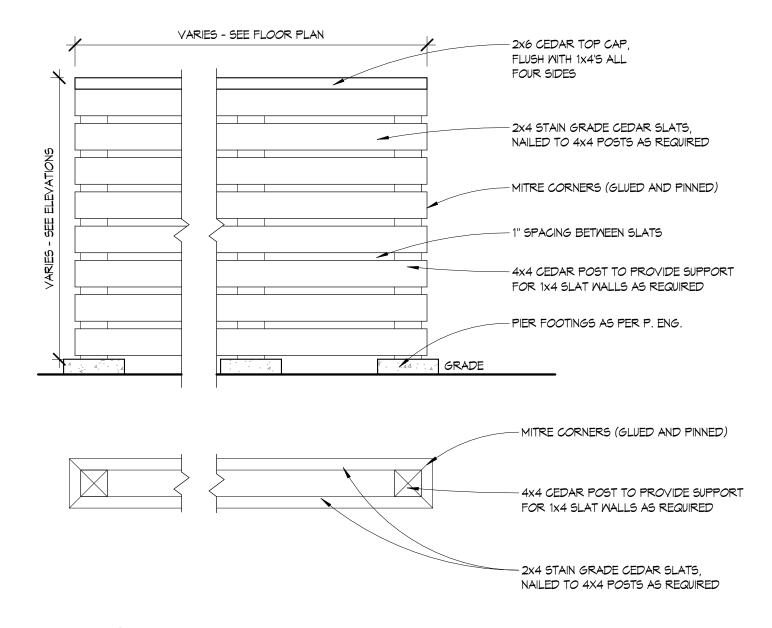

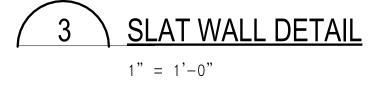

DO NOT ORDER DOORS UNTIL ROUGH DIMENSIONS ARE CONFIRMED ON SITE

				DOOR	SCHE	EDULE	
ID	COUNT	WIDTH	HEIGHT	FAMILY	MATERIAL	ASSEMBLY	NOTES
1	1	11'-0"	6'-11"	Exterior, Nana Wall	Wood & tempered glass	Solid core	Stain grade, weather stripping, style as per I.D.
2	2	2'-6"	6'-8"	Interior, Single Swing	Wood	Solid core	Paint grade, style as per I.D. (match existing
3	1	2'-4"	6'-8"	Interior, Single Swing	Wood	Solid core	Paint grade, style as per I.D. (match existing)
4	1	2'-5"	6'-6"	Interior, Single Swing	Wood	Solid core	Existing door in new opening
5	1	3'-0"	6'-8"	Exterior, Swing, Single	Fibreglass	Solid core	Weather stripping, style as per I.D. (match existing)
6	1	2'-6"	6'-8"	Interior, Pocket, Single	Wood	Solid core	Paint grade, style as per I.D. (match existing)

DO NOT ORDER WINDOWS UNTIL ROUGH DIMENSIONS ARE CONFIRMED ON SITE


 DO NOT SCALE DRAWINGS WINDOWS SUPPLIER TO ENSURE ALL APPLICABLE WINDOWS MEET EGRESS REQUIREMENTS


	WINDOW SCHEDULE								
ID	COUNT	WIDTH	HEIGHT	FAMILY	MATERIAL	NOTES			
Α	1	2'-4"	2'-10"	Single Hung, Single	Vinyl	Obscure glass, style as per I.D. (match existing)			
В	1	2'-10"	2'-10"	Sliding, Double	Vinyl	Style as per I.D. (match existing)			
С	1	4'-0 1/2"	2'-0 1/2"	Sliding, Double	Vinyl	Style as per I.D. (match existing)(Use existing opening)			
TOTA	11 · 3								

EFFECTIVE INSULATION REQUIREMENTS (MINIMUM)
DOORS / WINDOWS U-VALUE: 1.8 NANAWALL "1": 0.39 (CONFIRM WITH MANUFACTURER SPECIFICATIONS)

CAP FLASHING SLOPE TO DRAIN — PEEL & STICK MEMBRANE POLYURETHANE CAULK FLASHING -- SOLID BLOCKING AS PER P.ENG. 1/4" GAP MIN.-— TEMPERED GLASS RAILING C/W STAND-OFF FITTINGS EXTERIOR WALL ASSEMBLY (SEE A-8) -PROVIDE VENTING HOLES -INSECT SCREEN -- NEW VINYL DECKING, STYLE AS PER I.D. EXTERIOR NEW 2x12 TRIM -BOARD (FLASH TOP) EXISTING SHEATHING TO REMAIN -IF POSSIBLE, CONDITIONS TO BE CONFIRMED ON SITE EXISTING JOISTS -EXISTING GARAGE EXISTING GARAGE MALL INTERIOR




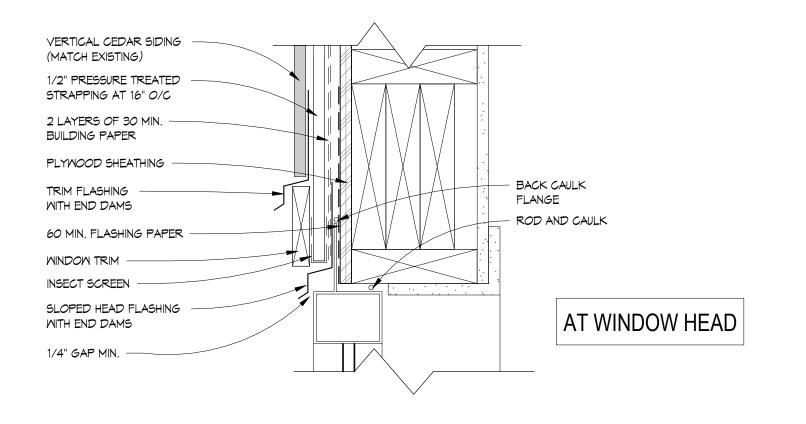


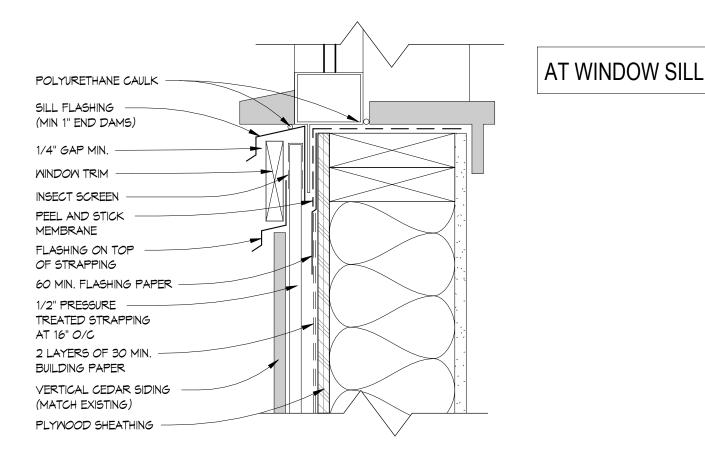



3" = 1'-0"

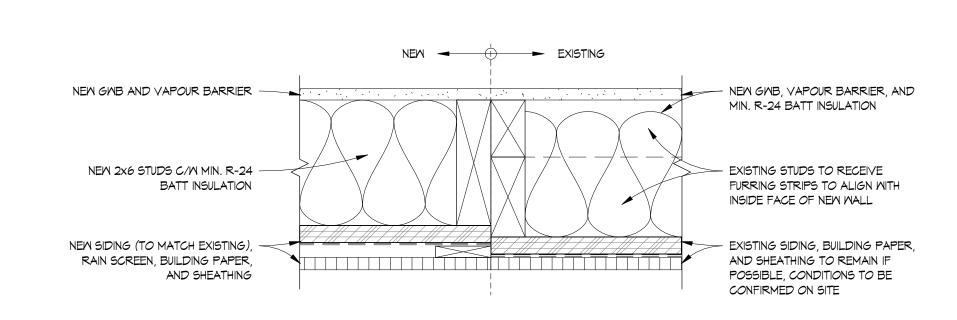

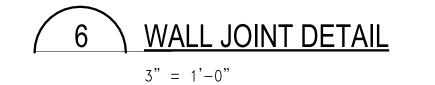

synthesis design inc. 258 east 1st street north vancouver, bc, canada V7L 1B3 tel. (604) 980-2087 www.synthesisdesign.ca
McKIBBIN-McLARTY RENOVATION / ADDITION 1253 Sutherland Ave.
Drawing Title DETAILS & SCHEDULES
Date 1.03.2023
Scale As indicated
Drawn PGS
Job No. 22011
Sheet A-9

Citys Comments 11.18.2022

Copyright reserved. All contents of this drawing

are the exclusive proper of Synthesis Design Inc.

and shall not be used


reproduced without the consent of the Designer

All dimensions shall be

verified on site prior to

ommencement of work.

2023-02-06 9:16:22 AM Of 10 Sheets

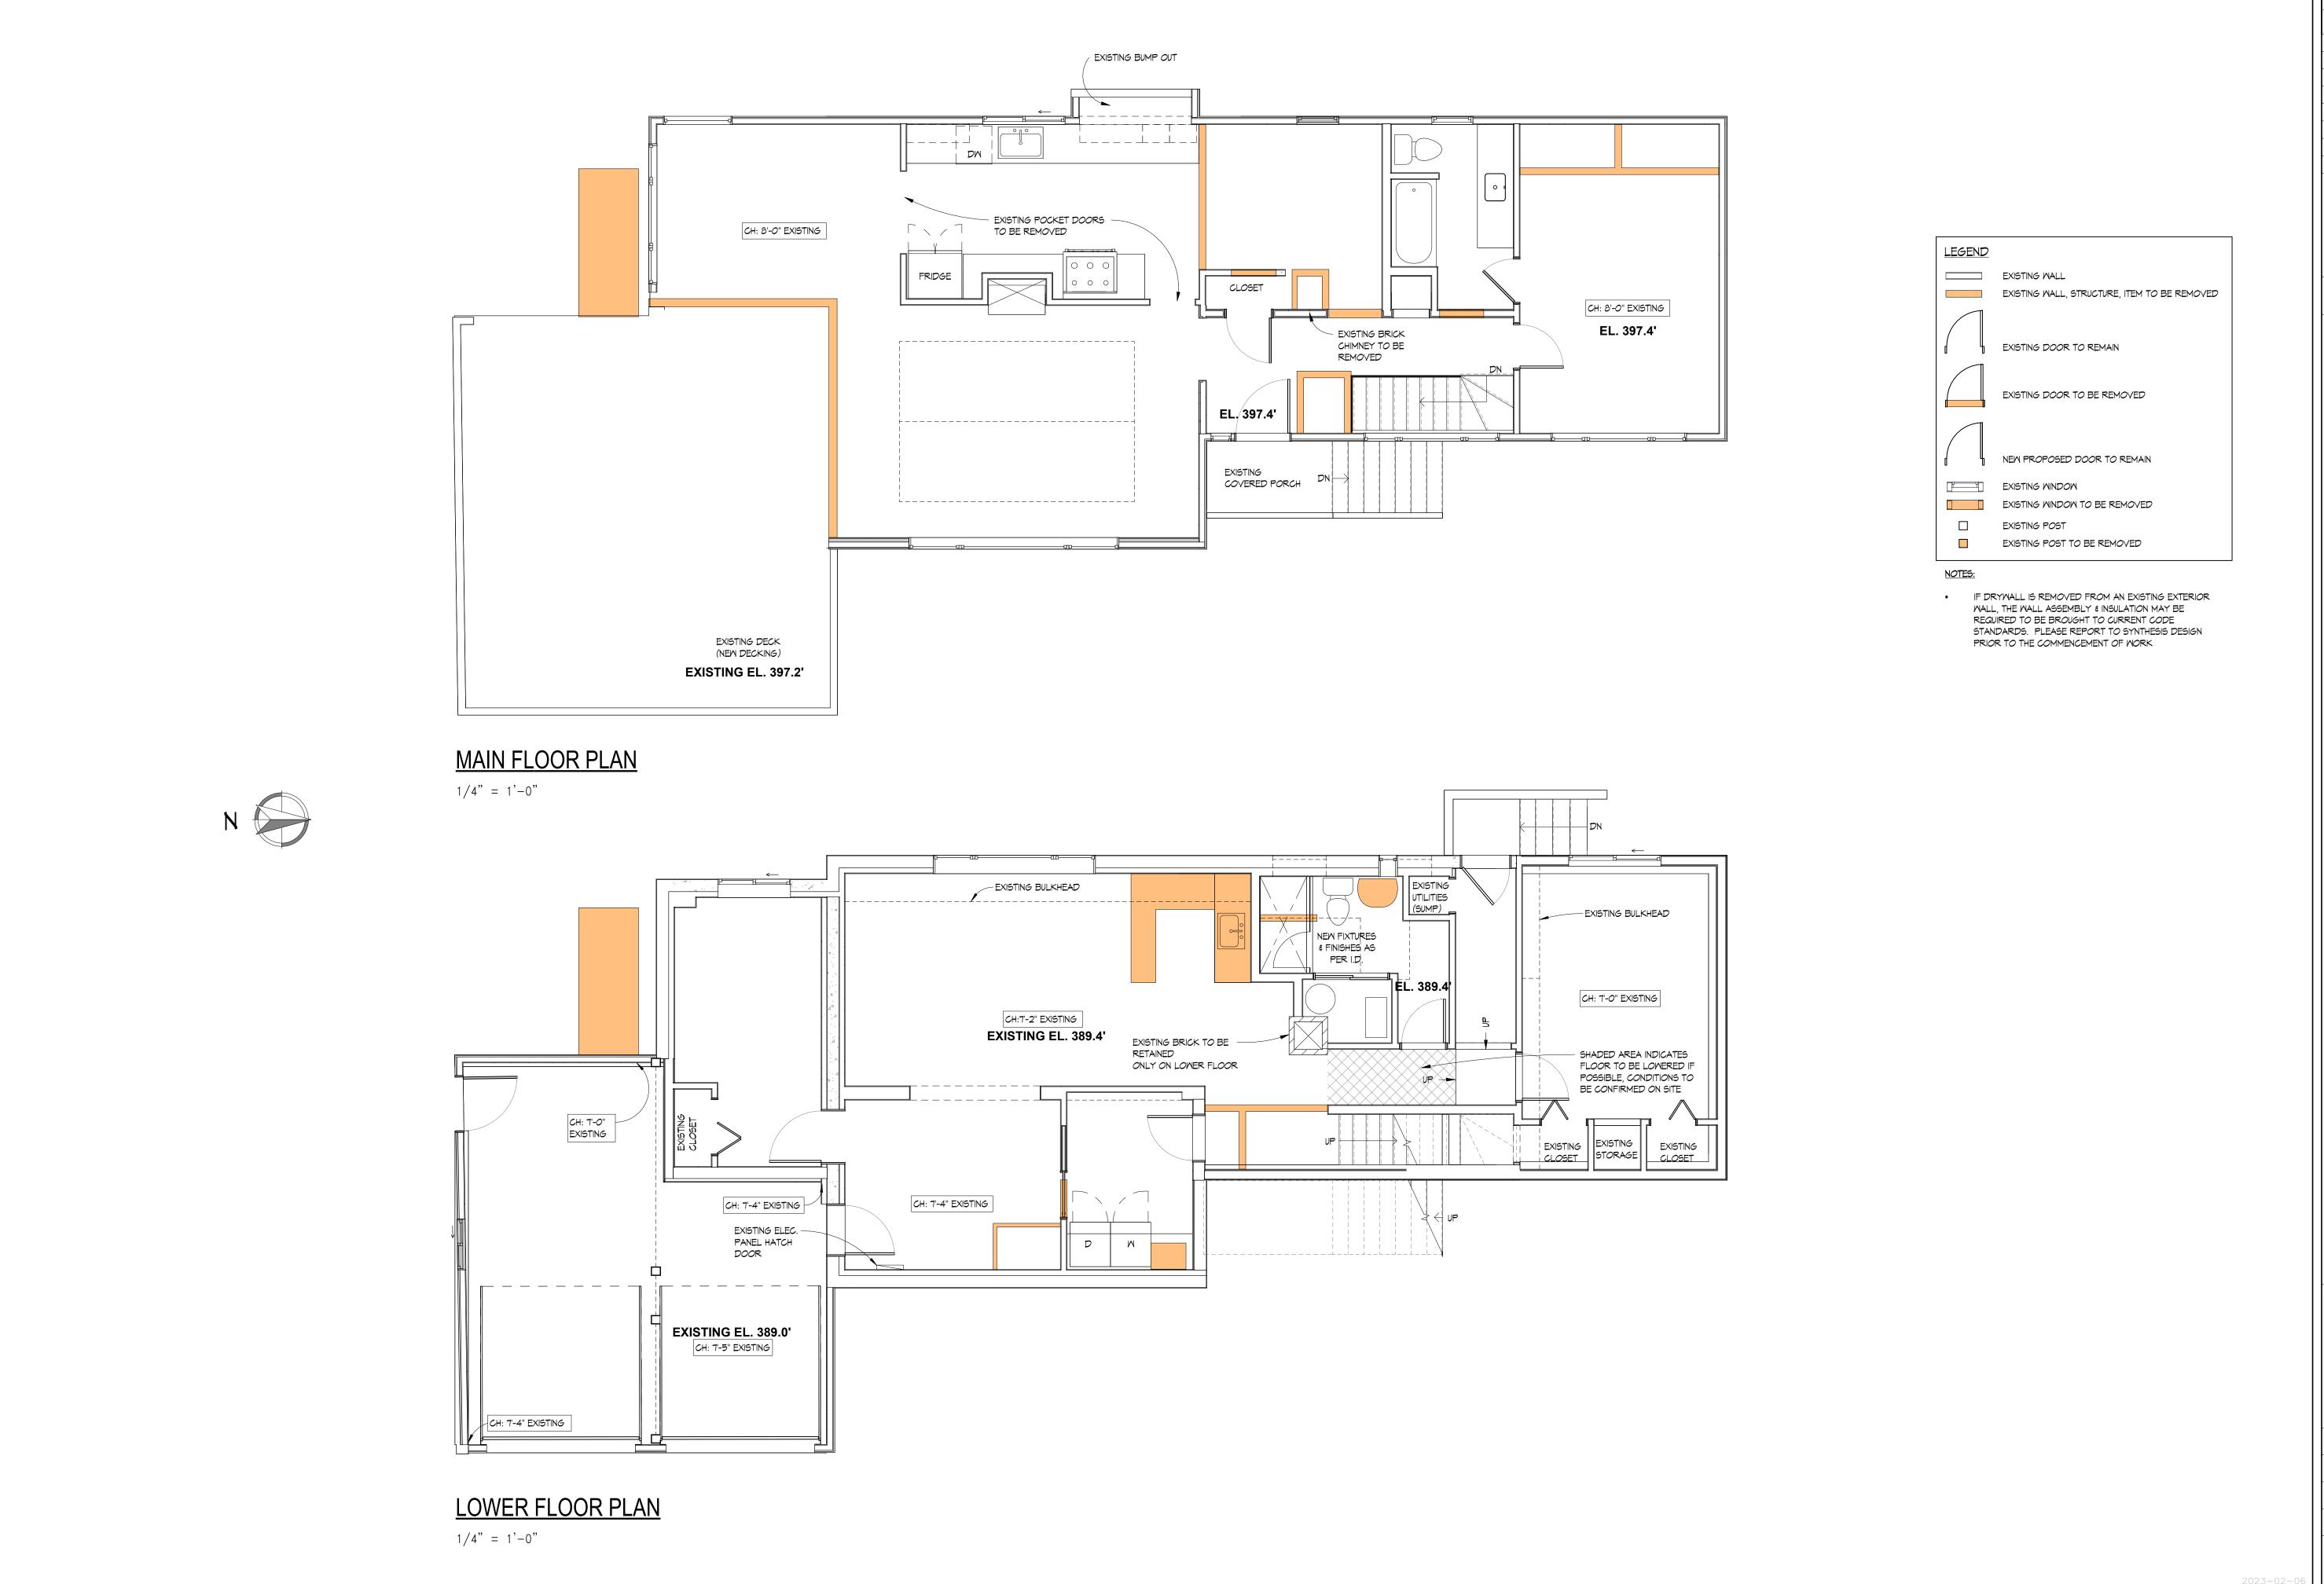

Citys Comments 11.18.2022

Copyright reserved. All contents of this drawing are the exclusive proper of Synthesis Design Inc. and shall not be used o reproduced without the consent of the Designer

All dimensions shall be verified on site prior to commencement of work.



synthesis design inc. 258 east 1st street north vancouver, bc, canada V7L 1B3 tel. (604) 980-2087 www.synthesisdesign.ca

ADDITION

TION Ave. McKIBBIN-McLARTY RENOVA 1253 Sutherland

Drawing Title MAIN FLOOR DEMO

Date 1.03.2023 Scale 1/4" = 1'-0"

Drawn PGS Job No. 22011

Sheet A-10

Of 10