LANDSCAPE - BASEMENT AND FIRST FLOOR PLAN

SCALE: 1/8" = 1'-0"

ST. PATRICKS AVENUE

2 LANDSCAPE - ROOF TOP PLAN

SCALE: 1/8" = 1'-0"

## NOTES:

- ALL PLANT MATERIAL SHALL MEET OR EXCEED STANDARDS REQUIRED BY BCNTA OR BCSLA GUIDELINES.
   REFER TO ARBORIST REPORT AND DRAWINGS FOR ALL RELATED TREE REMOVAL AND TREE RETENTION
- 2. REFER TO ARBORIST REPORT AND DRAWINGS FOR ALL RELATED TREE REMOVAL AND TREE RETENTION REQUIREMENTS.
- 3. TOPSOIL SUPPLIED SHALL BE FROM A REPUTABLE SOURCE. A FULL ANALYSIS OF THE TOPSOIL WILL BE REQUIRED AT THE CONTRACTOR'S EXPENSE, SUBMIT TO LANDSCAPE CONSULTANT FOR APPROVAL.
- 4. AMMEND TOPSOIL PER SOIL ANALYSIS RECOMMENDATIONS PIOR TO SPREADING ON SITE. REJECTED TOPSOIL SHALL BE REMOVED OFF SITE IMMEDIATELY AT THE LANDSCAPE CONTRACTORS EXPENSE.
- 5. TOPSOIL DEPTHS FOR PLANTING AS FOLLOWS:
- A. GRASSED AREAS: 350MM B. GROUND COVERS: 450MM
- C. SHRUBS: 500-600MM D. TREE PITS: 25CU METERS PER TREE PIT PER TREE
- 6. ALL SHRUB PLANTING AREAS SHALL HAVE GROUND COVERS 14" O.C.
- 2" DEPTH OF 1"MINUS COMPOST MULCH TO BE INSTALLED IN ALL SHRUB PLANTING AREAS.
   ON SITE IRRIGATION SYSTEM (AUTOMATIC) SHALL BE DESIGN BUILD TO BE COORDINATED BY GENERAL
- CONTRACTOR. IRRIGATION TO BE PROVIDED FOR ALL PLANTING BEDS.
- 9. OFF SITE IRRIGATION SYSTEM TO BE SEPARATE
- 10. ROCK AND BOULDER MATERIALS

  ALL BOULDERS SHALL BE SMOOTH FINISH SOURCED FROM RIVER OR FIELD. DO NOT SUPPLY STRAIGHT OR

  SPLIT FACED STONE, THEY WILL BE REJECTED. PROVIDE JPEG PHOTO OF STONE TO LANDSCAPE ARCHITECT

  FOR APPROVAL. BOULDERS TO BE EMBEDDED INTO GRADE DO NOT REST ON SURFACE.
- SIZES: A: 2'-0" TO 2'-6" DIAMETER B: 1'-0" TO 2'-0" DIAMETER
- 11. PAVING TYPES AND MATERIALS AS FOLLOWS:
   OFF SITE SIDEWALKS, CAST IN PLACE CONCRETE W/BROOM FINISH, INSTALL SAW CUT CONTROL JOINT EVERY 8'. ISOLATION JOINT EVERY 28'.
- PARKING AREA: PERMEABLE UNIT PAVERS
   SIDEYARDS: STANDARD CONCRETE PAVING WITH BROOM FINISH NO TROWELED EDGES. SAW CUT EVERY 8'
   ROOF LEVEL PRIVATE PATIOS: 2'X2' CONC. UNIT PAVERS W/ PLASTIC PEDESTALS. ABBOTSFORD CONCRETE PRODUCT OR EQUIVALENT, MODEL: SATURNA, COLOR: CHARCOAL
- 12. SITE GRADING: REFER TO ARCHITECTURAL AND CIVIL ENGINEERING DWGS FOR SITE GRADING OF ROADS, AND RETAINING WALLS. AREA DRAINS AND SUB-SURFACE PIPING TO BE COORDINATED WITH CIVIL GRADING FOR ALL LANDSCAPED AREAS TO ENSURE POSITIVE DRAINAGE. NO PONDING OF STORM WATER ALLOWED ON SITE.
- 13. STORM WATER MANAGEMENT BY CIVIL ENGINEERING.14. REFER TO ARBORIST'S REPORT FOR ALL MATTERS RELATED TO TREE PROTECTION, TREE ASSESSMENT AND TREE MANAGEMENT PROCEDURES.
- 15. ROOF TOP PATIO PLANTERS TO BE PRE-MANUFACTURED, ALUMINUM, GALVANIZED METAL. COMPLETE WITH DRAIN HOLF

## PLANT LIST:

KEY	QTY.	BOTANICAL NAME	COMMON NAME	SIZE	COND.
NSD	4	NYSSA SYLVATICA	BLACK TUPELO	7CM CAL.	B & B
QPD	2	QUERCUS PULUSTRIS	PIN OAK	7CM CAL.	B & B
APD	3	ACER PALMATUM	JAPANESE MAPLE	2.75M HT.	B & B
HCD	9	HIBISCUS COELESTIS	SHRUBBY ALTHEA	2.5 M HT.	B & B
TOC	13	TAXUS MEDIA HICKSII	HICKS YEW	1.75 M HT.	B & B
CJ	3	CAMELLIA JAPONINCA MOSHIO FLAME	JAPANESE CAMELLIA	#5	B & B
MA	20	MAHONIA AQUIFOLIUM	OREGON GRAPE	#3	CONTAINER
NT	25	NASELLA TENUISSIMA	MEXICAN FEATHER GRASS	#3	CONTAINER
PM	13	POLYSTICHUM MUNITEM	WESTERN SWORD FERN	#3	CONTAINER
P0	12	PRUNUS LAUROSERASUS OTTO LUYKEN	OTTO LUYKEN LAUREL	#3	
PP	10	PINUS MUGO PUMILIO	DWARF MUGO PINE	#2	CONTAINER
RD	10	RHODODENDRON DORA AMETEIS	DORA AMETEIS RHODO.	#3	CONTAINER
RU	10	RHODODEDRON UNIQUE	UNIQUE RHODO.	#3	CONTAINER
V0	3	VAXCCINIUM OVATUM	EVERGREEN HUCKLEBERRY	#3	CONTAINER
LA	34	LAVANDULA ANGUSTIFOLIA	LAVANDULA ANGUSTIFOLIA	#2	CONTAINER
HS	51	HEMEROCALIS STELLA D'ORO	DAY LILY	#1	CONTAINER
EC	6	ECHINACEA PURPUREA 'MAGNUS'	MAGNUS CONEFLOWER	#1	CONTAINER
CZ	9	COREOPSIS VERTICILLATA ZAGREB	ZAGREB TICKSEED	#1	CONTAINER

K	F	V	
1/	ᆫ		

1 LAWN

2' X 2' CONCRETE UNIT PAVERS PERMEABLE

2 PLANTING BED

TING BED 9 IRRIGATION STUB OUT

PROPOSED DECIDUOUS TREE

6' HT. WOOD FENCE/SCREEN

5 RETAING WALL, CONC. PLANTER


CONCRETE PAVING BROOM FINISH decorative P

PATIO FURNITURE - NOT IN DP. PROVIDED BY STRATA CORP.

PLANTER PRE FABRICATED

7 UNIT PAVERS - PERMEABLE

BBQ - STATION

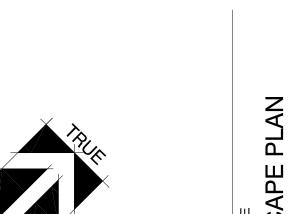

MARUYAMA

LANDSCAPE ARCHITECTS

DATE

FEB. 26, 20

DESIGN

JZ, RM

DATE
FEB .26, 2023

DESIGN
JZ, RMM

DRAWN
RMM


CHECKED
RMM

SCALE
AS SHOWN

JOB NO.
M2305

SHEET TITLE
LANDSCAPE PLAI

SHEET NO.

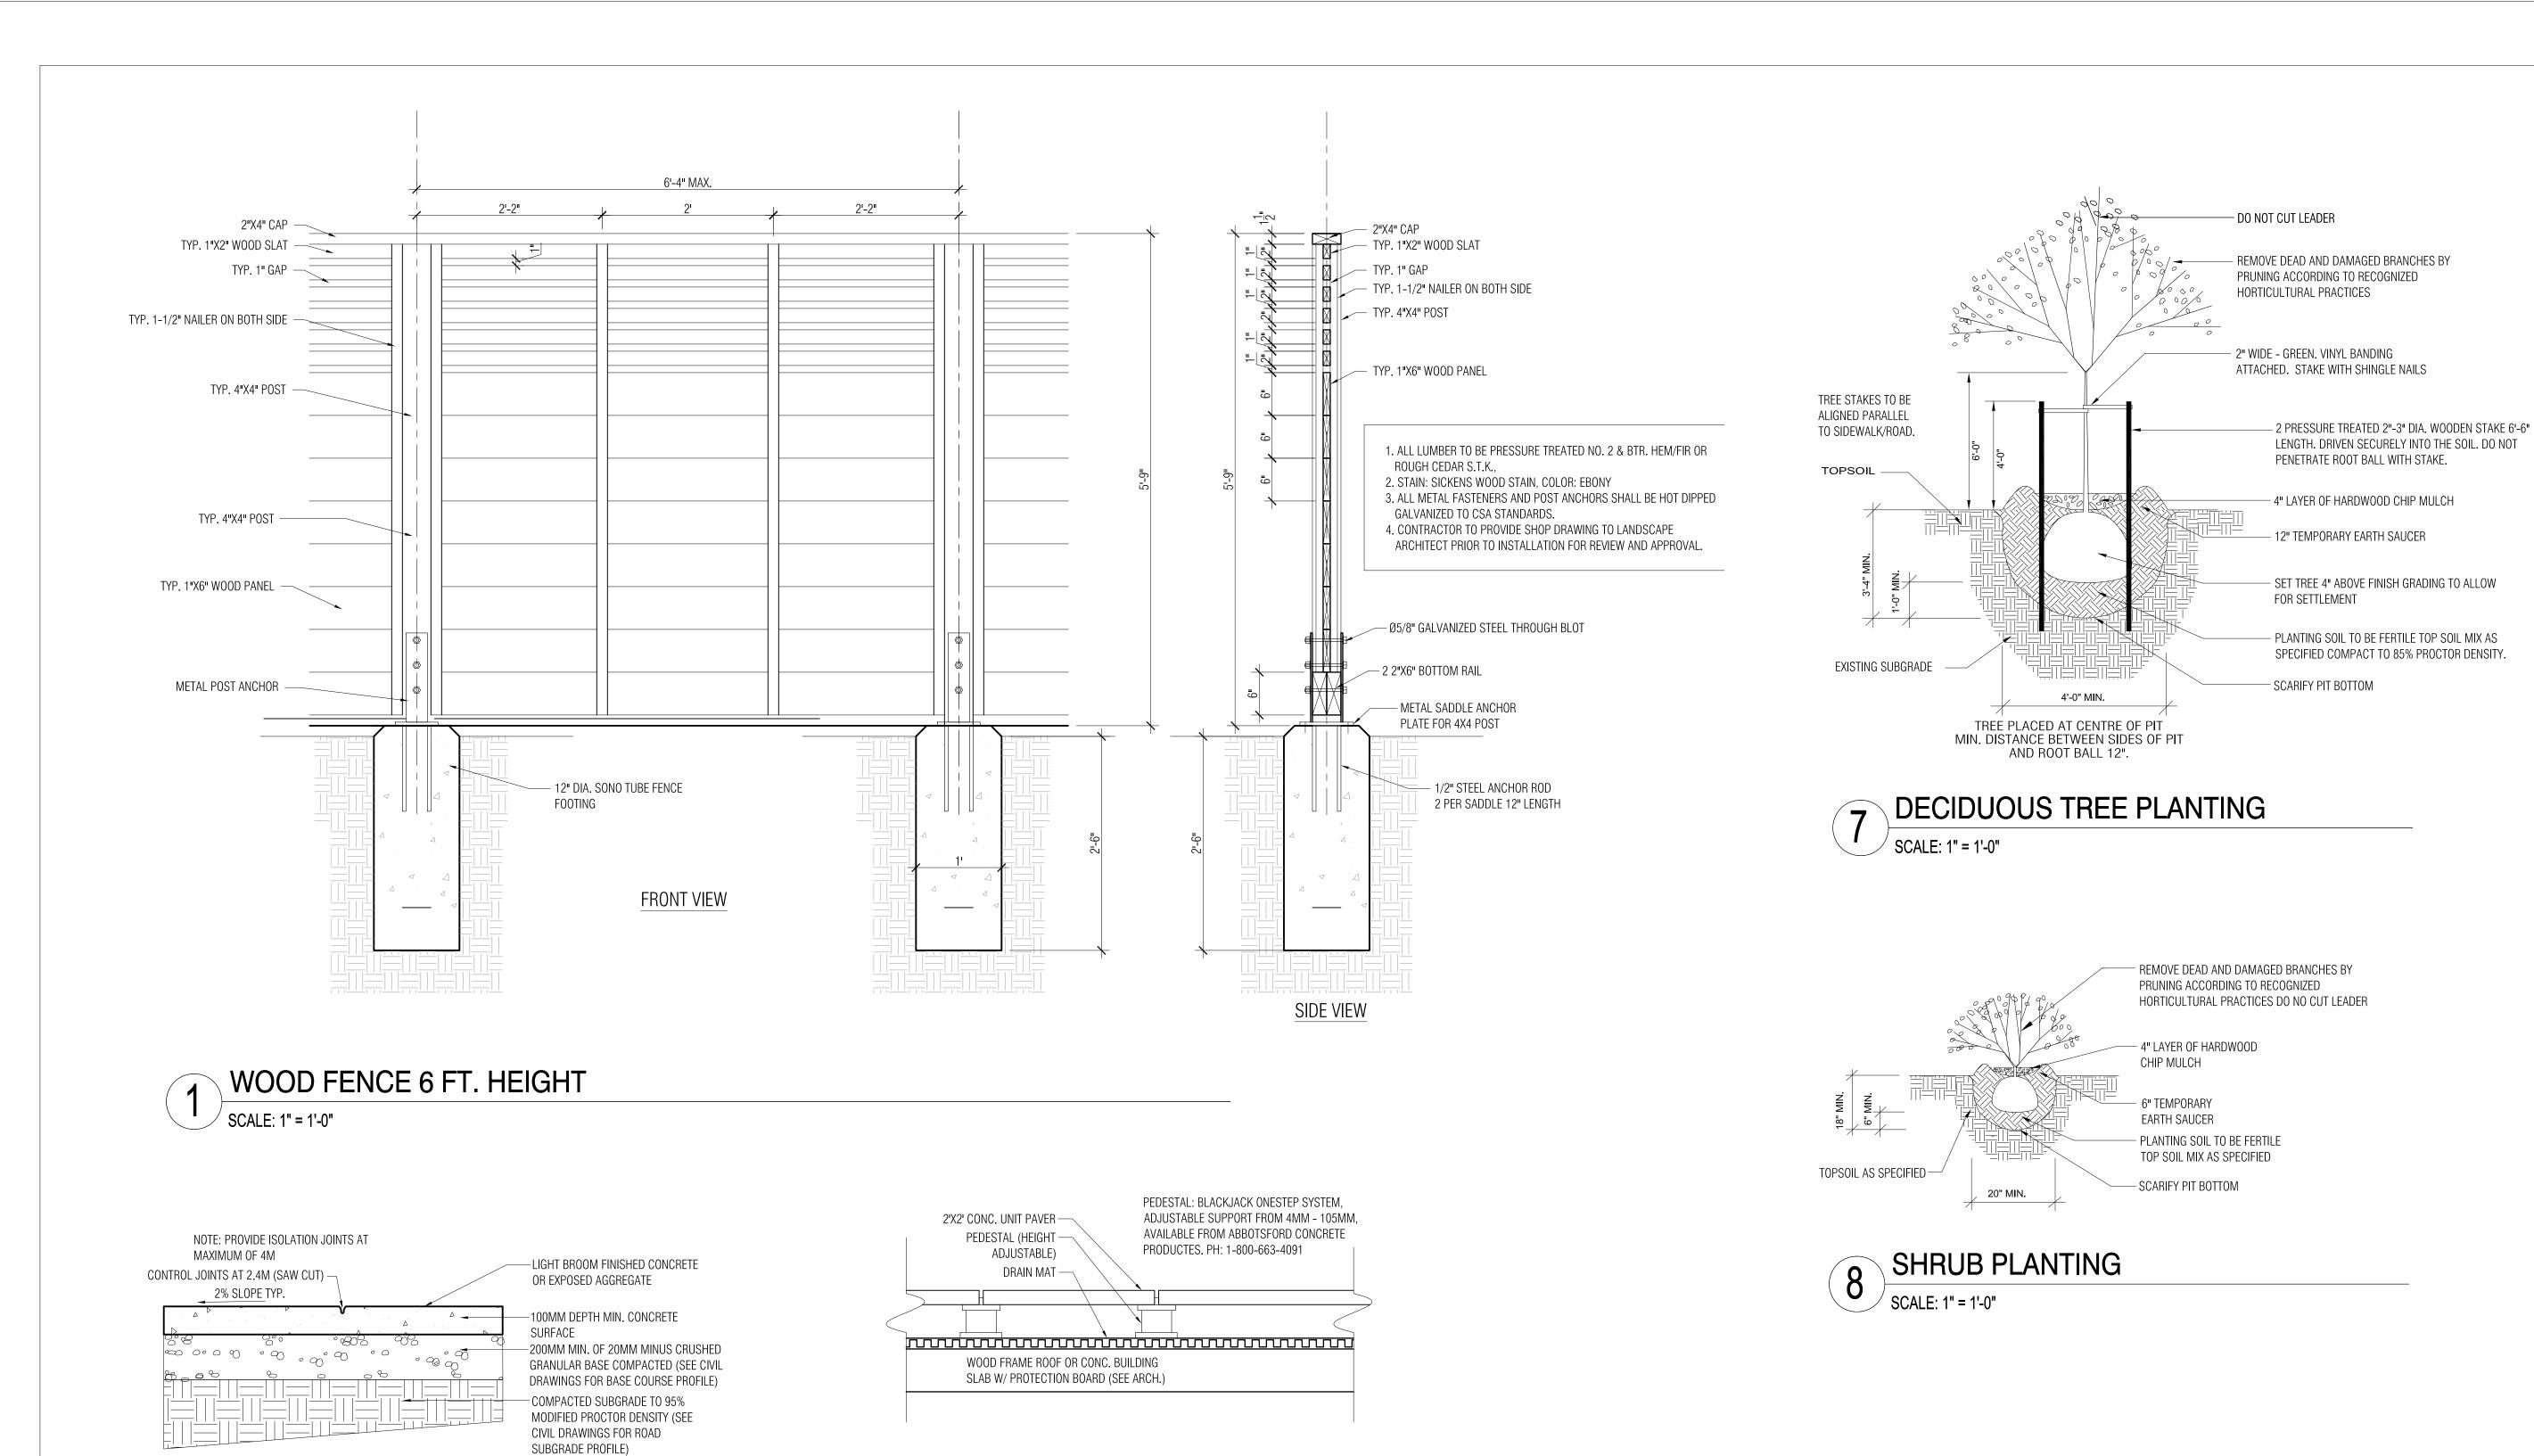

2X2 UNIT PAVING ON ROOF TOP

− 6"-8" DEPTH OF 1"-4" DIA.

– 2"X6" PRESSURE TREATED

— ADJACENT WALKWAY

WOOD EDGING

WASHED RIVER ROCK

BUILDING OUTLINE

SCALE: 1" = 1'-0"

**GRANULAR BALLAST** 

CONCRETE PAVING ON GRADE

UNIT PAVING ON GRADE

UNIT PAVED SURFACE SLOPE 2% TO DRAIN

COMPACTED BASE COURSE OF 1/4" CLEAR

CRUSH OPEN-GRADED BEDDING COURSE

— 6" DEPTH BASE COURSE OF 3/4" MINUS

GRANULAR COMPACTED TO 95% M.P.D.

- COMPACTED SUBGRADE TO 95% M.P.D.

1/8" DIA. CLEAR AGGREGATE JOINT STABILIZER

SCALE: 1" = 1'-0"

LOPMENT E, NORTH V,

**DEVE** AVENU

TOWNHOUSE | 269 ST. PATRICK |

LANDSCAPE ARCHITECTS	
DATE	FEB .26, 2023
DESIGN	JZ, RMM
DRAWN	RMM
CHECKED	RMM
SCALE	AS SHOWN
JOB NO.	M2305

BOULDERS / GRANULAR BALLAST SCALE: 1" = 1'-0"

—FILTER FABRIC

— 2"X6" PRESSURE TREATED

- ADJACENT WALKWAY

WOOD EDGING

LARGE BOULDERS EMBEDDED

8" DEPTH OF 1"-4" DIA.
WASHED RIVER ROCK

INTO THE RIVER ROCK BED

— BUILDING OUTLINE