



LONSDALE RESIDENTAL APARTMENT

2612 LONSDALE AVE, NORTH VANCOUVER

RE-ISSUED FOR BP APPLICATION

ISSUE DATE: Issue Date SHEET LIST

ARCHITECTURAL

A00.00 COVER PAGE

A00.02 PERSPECTIVES

A00.20 ZONING BYLAW A00.21 BC CODE ANALYSIS

A00.22 BC CODE ANALYSIS- ACCESSIBILITY

A00.24 BC CODE ANALYSIS- PLANS A A00.25 BC CODE ANALYSIS- PLANS B

A00.30 CONSTRUCTION ASSEMBLIES

A00.31 CONSTRUCTION ASSEMBLIES

A01.01 SITE PLAN

A01.20 FIRE ACCESS PLAN

A02.11 SURVAY PLAN A02.12 PARKING PLAN

A02.13 GROUND FLOOR PLAN

A02.14 SECOND FLOOR PLAN A02.15 THIRD FLOOR PLAN

A02.16 FORTH FLOOR PLAN A02.17 FIFTH FLOOR PLAN

A02.18 ROOF PLAN

A03.10 BUILDING SECTIONS A03.11 BUILDING SECTIONS

A03.12 BUILDING SECTIONS A03.13 BUILDING SECTIONS

A03.20 WALL SECTION

A03.21 WALL SECTION A04.10 ELEVATION

A04.11 ELEVATION A05.00 UNIT FLOOR PLANS

A05.01 UNIT FLOOR PLANS A05.02 UNIT FLOOR PLANS

A05.03 UNIT FLOOR PLANS A05.04 UNIT FLOOR PLANS

A05.05 UNIT FLOOR PLANS A05.10 ACCESSIIBLE WASHROOM LAYOUT-TYP.

A06.20 STAIR 1 PLAN AND SECTION

A06.21 STAIR 2 PLAN AND SECTION A06.22 EXT.STAIR1 PLAN AND SECTION



PROJECT TEAM

OWNER ARCHITECT of RECORD

GARDENIA HOLDINGS OWNER: REZA ABEDI EMAIL: rezabedi@hotmail.com

BUILDING DESIGN

CODE AND SPRINKLERED

BMAC TECHNOLOGIES AND CONSULTING INC

PRINCIPAL IN CHARGE: FARZAD HEMMATI

220-8208 Swenson Way Delta, B.C. V4G 1J6

PHONE: 604.544.7564

EMAIL: FarzadH@bmactc.com

PHONE: (604)218-3515

MA ARCHITECTS LTD. 2025 WILLINGDON AVE, #900

BURNABY,BC PHONE: (604)780-3243 EMAIL: info@m-aarchitects.com PRINCIPAL IN CHARGE: ALI PEYMANI

MECHANICAL

EPRO CONSULTS # 206, 32625 South Fraser Way, Abbotsford, BC, V2T1X8 PHONE: (778)242-8111 EMAIL: gbrar@eproconsultants.ca PRINCIPAL IN CHARGE: GURJOT BRAR, P.Eng.

CIVIL

CIVILTECK EMAIL: kaz@civilteck.ca
PRINCIPAL IN CHARGE: KAZEM ESKOCH

LANDSCAPE **DURANTE KRUEK LTD** 102-1637 WEST 5TH AVENUE VANCOUVER, BC, V6J 1N5 PHONE: 604.684.4611 PRINCIPAL IN CHARGE: PETER KREUK

ARBORIST

BUILDING ENVELOPE BMAC TECHNOLOGIES AND CONSULTING INC

STRUCTURAL

#208 - 1730 w 2nd ave,

Vancouver, V6J1H6

PHONE: (778)-998-0709

TECH LEAD: Daniel Ray

ELECTRICAL

PHONE: (778)242-8111

206, 32625 South Fraser Way, Abbotsford, BC, V2T1X8

EMAIL: gbrar@eproconsultants.ca
PRINCIPAL IN CHARGE: GURJOT BRAR, P.Eng.

EPRO CONSULTS

SURVEY

JRG BUILDING ENGINEERING INC.

PRINCIPAL IN CHARGE: Flavio Paes

220-8208 Swenson Way Delta,B.C V4G 1J6 PHONE: 604-544-7564 EMAIL: farzadh@bmactc.com PRINCIPAL IN CHARGE: FARZAD HEMMATI

MA ARCHITECTS LTD.

2025 Willingdon Avenue #900, Burnaby, BC. V5C 0J3
OFFICE: +1 (778)-372-8650, +1 (778)-372-8651
CELL: +1 (604)-780-3243, +1 (604)-780-6461
EMAIL: INFO@M-AARCHITECTS.COM
WWW.M-AARCHITECTS.COM

2023/01/10 ISSUED FOR CLIENT REVIEW 2022/12/09 ISSUED FOR CONSULT. USES

ISSUES AND REVISIONS

COPYRIGHT NOTICE: All rights reserved. All ideas, designs, drawings and reproductions either in print or electronic format, are the property of MA ARCHITECTS Ltd., and are an instrument of service that may not be used, forwarded to others, transmitted, downloaded or reproduced either in print or electronic format, without the express written permission of the copyright owner.

Written dimensions shall have precedence over scaled dimensions. Contractors shall verify and be responsible for all dimensions and conditions on the job; shall request clarification of errors, discrepancies, or doubtful information contained in contract drawings and documents. Failure to obtain such clarification renders the Contractor responsible for any resulting improper work and the cost of rectification. This drawing shall not be used for construction purposes until it is issued for the purpose.

LONSDALE

RESIDENTAL **APARTMENT**

PROJECT ADDRESS

PROJECT NAME

2612 LONSDALE AVE, NORTH VANCOUVER

DRAWING TITLE

COVER PAGE

SCALE	1" = 60'-0"
DRAWN	SH
CHECKED	AP
PROJECT NO.	22042

DRAWING NO.

THIS DRAWING IS PROPERTY OF MA ARCHITECTS LTD. AND SHOULD NOT BE COPIED OR DISTRIBUTED
WITHOUT PRIOR WRITTEN CONSENT.





MA ARCHITECTS LTD.

OFFICE
2025 Willingdon Avenue #900, Burnaby, BC. V5C 0J3
OFFICE: +1 (778)-372-8650, +1 (778)-372-8651
CELL: +1 (604)-780-3243, +1 (604)-780-6461
EMAIL: INFO@M-AARCHITECTS.COM
WWW.M-AARCHITECTS.COM

SOUTHEAST SIDE

NORTHEAST SIDE







5 2023/01/27 ISSUED FOR LEGAL DOC.
4 2023/01/23 ISSUED FOR CONSULTANT
3 2023/01/19 ISSUED FOR CLIENT REVIEW
2 2023/01/10 ISSUED FOR CLIENT REVIEW
1 2022/12/09 ISSUED FOR CONSULT. USES
NO. DATE Y/M/D DESCRIPTION

ISSUES AND REVISIONS

SEAL

COPYRIGHT NOTICE:
All rights reserved. All ideas, designs, drawings and reproductions either in print or electronic format, are the property of MA ARCHITECTS Ltd., and are an instrument of service that may not be used, forwarded to others, transmitted, downloaded or reproduced either in print or electronic format, without the express written permission of the copyright owner.

Written dimensions shall have precedence over scaled dimensions. Contractors shall verify and be responsible for all dimensions and conditions on the job; shall request clarification of errors, discrepancies, or doubtful information contained in contract drawings and documents. Failure to obtain such clarification renders the Contractor responsible for any resulting improper work and the cost of rectification. This drawing shall not be used for construction purposes until it is issued for the purpose.

PROJECT NAME

LONSDALE RESIDENTAL APARTMENT

PROJECT ADDRESS

2612 LONSDALE AVE, NORTH VANCOUVER

DRAWING TITLE

PERSPECTIVES

270			
	SCALE		
	DRAWN	SH	
	CHECKED	AP	
in.	PROJECT NO.	22042	

DRAWING NO.

A00.02

A. BUILDING INFORMATION

CIVIC ADDRESS: 2612 LONSDALE AVE, NORTH VANCOUVER, BC. LEGAL DISCRIPTION: LOT: A - 2; BLOCK:229; DL:545; PLAN:2969

LOT AREA: 8245 FT2 / 765.98 M2
PARCEL ID NUMBER: 013-287-877
OCP DESIGNATION: LAND USE CODE: R5

B. ZONING BYLAW ANALYSIS (CITY OF NORTH VANCOUVER)

ZONING: RM-1 (MEDIUM DENSITY RESIDENTIAL)

REQUIRED SETBACKS:

FRONT LOT LINE (FROM LONSDALE AVE): 12.00FT
SIDE YARD (NORTH): 8.00FT
SIDE YARD (SOUTH): 8.00FT
REAR YARD (BACKLANE): 10.00FT

PROPOSED HEIGHT: 51'-11 3/4" FT

SITE AREA: 8,245ft²

PERMITTED FSR: 2.6%
PERMITTED FLOOR AREA: 21,437ft²

PROPOSED FLOOR AREA: 18,304ft²

	AREA	PERMITTED FSR	PERMITTED FLOOR AREA	PROPOSED FSR	PROPOSED FLOOR AREA
GROSS SITE AREA	8,245 ft ²	2.6	21,437 ft ²	2.22	18,328 ft ²
DEDUCTION ROAD	770 ft²				
NET SITE AREA	7,475 ft ²				

LEVEL	OCCUPANCY	AREA (SM)	AREA (SF)	ADABTABLE UNIT AREA REDUCTION	TOTAL FLOOR AREA
GROUND FLOOR	AMENITY	29.44 m²	317 ft²)		
GROUND FLOOR	BICYCLE STOR.	23.82 m ²	256 ft ²		
GROUND FLOOR	COMMON AREA	54.60 m ²	588 ft ²	0 ft²	588 ft²
GROUND FLOOR	DECK UNIT B	23.23 m ²	250 ft ²		
GROUND FLOOR	DECK UNIT B-1	17.03 m²	183 ft²		
GROUND FLOOR	DECK UNIT D	13.31 m²	143 ft ²		
GROUND FLOOR	ELECROOM	1.11 m ²	12 ft ²		
GROUND FLOOR	LOBBY	8.39 m²	90 ft ²		
GROUND FLOOR	MECHANICHAL ROOM	1.01 m ²	11 ft ²		
GROUND FLOOR	UNIT 101	55.18 m²	594 ft²	0 ft²	594 ft²
GROUND FLOOR	UNIT 102	61.77 m ²	665 ft ²	0 ft²	665 ft ²
GROUND FLOOR	UNIT 103	104.69 m²	1,127 ft ²	20 ft ²	1,107 ft²
SKOOND I LOOK	31411 100	393.58 m ²	4,236 ft ²	2011	2,954 ft ²
		333.30 111	4,200 It		2,954 10
ND FLOOR PLAN	COMMON AREA	47.81 m²	515 ft ²	0 ft²	515 ft²
ND FLOOR PLAN	DECK UNIT A	5.49 m ²	59 ft ²		
ND FLOOR PLAN	DECK UNIT A-1	9.25 m ²	100 ft ²		
ND FLOOR PLAN	DECK UNIT E	5.32 m ²	57 ft ²		
ND FLOOR PLAN	DECK UNIT F-1	9.57 m ²	103 ft ²		
ND FLOOR PLAN	DECK UNIT F-2	9.57 m ²	103 ft ²		
ND FLOOR PLAN	UNIT 201	48.87 m²	526 ft ²	0 ft ²	526 ft ²
ND FLOOR PLAN	UNIT 202	53.93 m ²	580 ft ²	20 ft ²	560 ft ²
ND FLOOR PLAN	UNIT 203	48.05 m ²	517 ft ²	0 ft ²	517 ft ²
ND FLOOR PLAN	UNIT 205	52.43 m ²	564 ft ²	20 ft ²	544 ft ²
ND FLOOR PLAN	UNIT 206	54.26 m ²	584 ft ²	0 ft ²	584 ft²
ND FLOOR PLAN	UNIT 206	54.27 m ²	584 ft ²	0 ft ²	584 ft²
		398.83 m²	4,293 ft ²		3,831 ft²
RD FLOOR	COMMON AREA	47.83 m²	515 ft ²	0 ft²	515 ft²
RD FLOOR	DECK UNIT A	5.51 m ²	59 ft ²	0 11	01010
RD FLOOR	DECK UNIT E-1	5.32 m ²	57 ft ²		
RD FLOOR	UNIT 301	48.87 m ²	526 ft²	0 ft²	526 ft²
RD FLOOR	UNIT 302	53.93 m ²	580 ft ²	0 ft²	580 ft ²
RD FLOOR	UNIT 303	48.05 m ²	517 ft ²	0 ft ²	517 ft ²
RD FLOOR	UNIT 304	54.23 m ²	584 ft²	0 ft ²	584 ft ²
RD FLOOR	UNIT 305	52.41 m ²	564 ft ²	20 ft ²	544 ft ²
RD FLOOR	UNIT 306	54.26 m ²	584 ft²	0 ft ²	584 ft²
IND FLOOR	UNIT 300	370.41 m ²	3,987 ft ²	O II	3,850 ft ²
ITH FLOOR	COMMON AREA	47.81 m²	515 ft²	0 ft²	515 ft ²
ITH FLOOR	DECK UNIT C-1	9.54 m²	103 ft²		
TH FLOOR	UNIT 401	76.23 m²	820 ft ²	0 ft²	820 ft ²
TH FLOOR	UNIT 402	74.64 m²	803 ft ²	0 ft²	803 ft ²
TH FLOOR	UNIT 403	106.30 m ²	1,144 ft²	20 ft ²	1,124 ft ²
TH FLOOR	UNIT 404	54.26 m ²	584 ft²	0 ft²	584 ft ²
		368.77 m ²	3,969 ft ²		3,847 ft ²

NOT

5TH FLOOR

PROPOSED FLOOR AREA

COMMON AREA

DECK UNIT D-1

DECK UNIT D-1

UNIT 501

UNIT 502

UNIT 503

UNIT 504

FLOOR AREA MEASURED TO THE EXTREME OUTER LIMITS OF THE BUILDING, INCLUDING ALL SUITES AND ALL AREAS GIVING ACCESS THERETO, SUCH AS CORRIDORS, LOBBY, STAIRWELLS (INCLUDING ANY AREA UNDER STAIRWELLS), ELEVATOR SHAFTS, BUT EXCLUDING: BASEMENT SPACE CONTAINING COMMON ELECTRICAL, MECHANICAL, ELEVATOR MACHINE ROOM, RECYCLING AND GARBAGE ROOMS; AMENITY AREA PROVIDED FOR THE COMMON USE; 20 SQ.FT. FOR EACH LEVEL 2 ADAPTABLE DESIGN DWELLING UNIT AND BALCONIES UP TO 10% GROSS FLOOR AREA.

1,905.54 m² 20,511 ft²

47.83 m²

5.47 m²

9.28 m²

76.18 m²

74.59 m²

54.27 m²

106.33 m²

373.95 m²

515 ft²

59 ft²

100 ft²

820 ft²

803 ft²

1,145 ft²

584 ft²

4,025 ft²

803 ft²

1,125 ft²

584 ft²

3,846 ft²

18,328 ft²

RESIDENTIAL UNITS				
LEVEL	TOTAL UNITS	ONE BEDROOM	2 BEDROOMS	3 BEDROOMS
L1	3	1	1	1
L2	6	6	0	0
L3	6	6	0	0
L4	4	1	2	1
_L5	4	1	2	1
TOTAL	23	15	5	3
%	100%	65.22%	21.73%	13.04%

		ADAP	TABLE DESI	GN UNIT LIST			
					EXCL. FLOOR	AREA	CALCULATED
LEVEL	UNIT ADDRESS	UNIT TYPE	BEDROOM	ADAPTABLE	AREA	(SF)	UNIT AREA (SF
	T	· · · · ·	1.55	T	0.50		
GROUND FLOOR	UNIT 100	UNIT B	1BR	No	0 ft²	594 ft²	594 ft²
GROUND FLOOR	UNIT 102	UNIT B-1	2BR	No	O ft ²	665 ft ²	665 ft ²
GROUND FLOOR	UNIT 103	UNIT D	3BR	Yes	20 ft²	1127 ft²	1107 ft²
					20 ft ²	2386 ft ²	2366 ft ²
2ND FLOOR PLAN	UNIT 201	UNIT F2	1BR	No	0 ft²	526 ft ²	526 ft²
2ND FLOOR PLAN	UNIT 202	UNIT E	1BR	Yes	20 ft ²	580 ft ²	560 ft ²
2ND FLOOR PLAN	UNIT 203	UNIT F-1	1BR	No	0 ft²	517 ft ²	517 ft ²
2ND FLOOR PLAN	UNIT 204	UNIT A	1BR	No	0 ft²	581 ft ²	581 ft²
2ND FLOOR PLAN	UNIT 205	UNIT A-1	1BR	Yes	20 ft ²	564 ft ²	544 ft ²
2ND FLOOR PLAN	UNIT 206	UNIT A	1BR	No	O ft ²	584 ft ²	584 ft²
					40 ft ²	3354 ft ²	3314 ft²
3RD FLOOR	UNIT 301	UNIT F2	1BR	No	0 ft²	526 ft²	526 ft²
3RD FLOOR	UNIT 302	UNIT E-1	1BR	No	O ft²	580 ft ²	580 ft ²
3RD FLOOR	UNIT 303	UNIT F-1	1BR	No	O ft ²	517 ft ²	517 ft ²
3RD FLOOR	UNIT 304	UNIT A	1BR	No	O ft ²	582 ft ²	582 ft ²
3RD FLOOR	UNIT 305	UNIT A-1	1BR	Yes	20 ft ²	564 ft ²	544 ft ²
3RD FLOOR	UNIT 306	UNIT A	1BR	No	O ft ²	584 ft ²	584 ft²
					20 ft ²	3354 ft ²	3334 ft²
4TH FLOOR	UNIT 401	UNIT C-2	2BR	No	0 ft²	820 ft²	820 ft ²
4TH FLOOR	UNIT 402	UNIT C-1	2BR	No	O ft²	803 ft ²	803 ft ²
4TH FLOOR	UNIT 403	UNIT D-1	3BR	Yes	20 ft ²	1144 ft ²	1124 ft²
4TH FLOOR	UNIT 404	UNIT A	1BR	No	0 ft²	584 ft ²	584 ft ²
					20 ft ²	3351 ft ²	3331 ft²
5TH FLOOR	UNIT 501	UNIT C-2	2BR	No	0 ft²	820 ft ²	820 ft²
5TH FLOOR	UNIT 502	UNIT C-1	2BR	No	0 ft²	804 ft ²	804 ft ²
5TH FLOOR	UNIT 503	UNIT D-1	3BR	Yes	20 ft ²	1144 ft ²	1124 ft²
5TH FLOOR	UNIT 504	UNIT A	1BR	No	O ft ²	584 ft ²	584 ft²
	•		1		20 ft ²	3351 ft ²	3331 ft²
23					120 ft ²	15796 ft ²	15676 ft ²


PARKING CALCULATION				
	FULL SIZE	SMALL CAR	ACCESSIBLE	
LEVEL				
P-1 PARKING UNDERGROUND	5	5	2	
SURFACE PARKING(1 CAR SHARE =4 STALLS)	4			

PARKING REQUIREMENTS							
	PARKING PER UNIT	# OF RESIDENTIAL UNITS	PARKING REQUIRED	PARKING PROVIDED			
RENTAL APARTMENT RESIDENTIAL USE	0.60	23	14	10			
VISITOR	0.10	23	2	2			
PARKING REDUCTION(CAR SHARE 1=4 STALLS)				-4			
TOTAL RESIDENTIAL PARKING			16	12			

PARKING PROVIDED IN THIS PROJECT 16 (REQUIRED PARKING) - 4 (CAR SHARE REDUCTION) = 12 STALLS

TOTAL

BICYCLE PARKING REQUIREMENTS							
PARKING PER UNIT	# OF RESIDENTIAL UNITS	PARKING REQUIRED	PARKING PROVIDED				
1.50	23	35	39				
		6	6				
		41	45				
	PARKING PER UNIT	PARKING PER UNIT # OF RESIDENTIAL UNITS	PARKING PER UNIT # OF RESIDENTIAL UNITS PARKING REQUIRED 1.50 23 35 6				

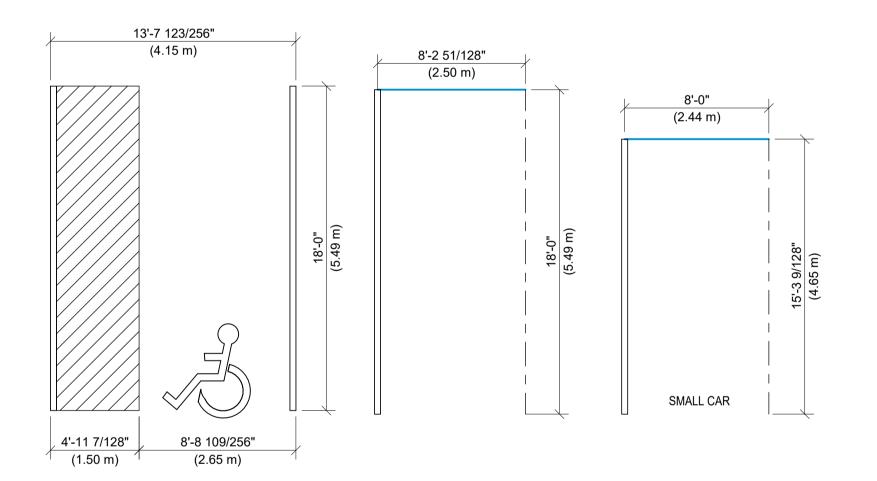

PARKING STALL

3/16" = 1'-0"



OFFICE
2025 Willingdon Avenue #900, Burnaby, BC. V5C 0J3
OFFICE: +1 (778)-372-8650, +1 (778)-372-8651
CELL: +1 (604)-780-3243, +1 (604)-780-6461
EMAIL: INFO@M-AARCHITECTS.COM
WWW.M-AARCHITECTS.COM

5 2023/01/27 ISSUED FOR LEGAL DOC.

NO. DATE Y/M/D DESCRIPTION

ISSUES AND REVISIONS

SEAL

4 2023/01/23 ISSUED FOR CONSULTANT
3 2023/01/19 ISSUED FOR CLIENT REVIEW
2 2023/01/10 ISSUED FOR CLIENT REVIEW
1 2022/12/09 ISSUED FOR CONSULT. USES

COPYRIGHT NOTICE:
All rights reserved. All ideas, designs, drawings and reproductions either in print or electronic format, are the property of MA ARCHITECTS Ltd., and are an instrument of service that may not be used, forwarded to others, transmitted, downloaded or reproduced either in print or electronic format, without the express written permission of the copyright owner.

Written dimensions shall have precedence over scaled dimensions. Contractors shall verify and be responsible for all dimensions and conditions on the job; shall request clarification of errors, discrepancies, or doubtful information contained in contract drawings and documents. Failure to obtain such clarification renders the Contractor responsible for any resulting improper work and the cost of rectification. This drawing shall not be used for construction purposes until it is issued for the purpose.

PROJECT NAME

LONSDALE RESIDENTAL APARTMENT

PROJECT ADDRESS

2612 LONSDALE AVE, NORTH VANCOUVER

DRAWING TITLE

ZONING BYLAW

SCALE	As indicated
DRAWN	SH
CHECKED	AP
PROJECT NO.	22042

DRAWING NO.

A00.20

THIS DRAWING IS PROPERTY OF MA ARCHITECTS LTD. AND SHOULD NOT BE COPIED OR DISTRIBUTED WITHOUT PRIOR WRITTEN CONSENT.

PROJECT DESCRIPTION: 2612 LONSDALE AVE, NORTH VANCOUVER, BC. **NUMBER OF STOREYS:** SIX (6) STOREYS

BUILDING AREA: MAJOR OCCUPANCY 3.1.2.1.(1):

GROUP C RESIDENTIAL OCCUPANCIES

GROUP F3 STORAGE GARAGE* *3.2.1.2.(1): STORAGE GARAGE CONSIDERED AS A SEPARATE BUILDING

|BLDG AREA m² | BLDG AREA ft²

NUMBER OF STOREYS 5 STORYS RESIDENTIAL 1 STORY STORAGE GARAGE

FACING STREETS TWO STREETS*

*3.2.2.10.(3) BUILDING CONSIDERED TO FACE 1 STREET WHERE NOT LESS THAN 10% OF BUILDING PERIMETER IS LOCATED WITHIN 15 m OF A STREET.

3.1.8.7 LOCATION OF FIRE DAMPERS AND SMOKE DAMPERS:

(1) EXCEPT AS PROVIDED IN ARTICLE 3.1.8.8., A FIRE DAMPER HAVING A FIRE-PROTECTION RATING CONFORMING TO SENTENCE 3.1.8.4.(2) SHALL BE INSTALLED IN CONFORMANCE WITH ARTICLE 3.1.8.10. IN DUCTS OR AIR-TRANSFER OPENINGS THAT PENETRATE AN ASSEMBLY REQUIRED TO BE A FIRE SEPARATION. (2) EXCEPT AS PROVIDED IN ARTICLE 3.1.8.9., A SMOKE DAMPER OR A COMBINATION SMOKE/FIRE DAMPER SHALL BE INSTALLED IN CONFORMANCE WITH ARTICLE 3.1.8.11. IN DUCTS OR AIR-TRANSFER OPENINGS THAT PENETRATE AN ASSEMBLY REQUIRED TO BE A FIRE SEPARATION, WHERE THE FIRE SEPARATION (a) SEPARATES A PUBLIC CORRIDOR.

(b) CONTAINS AN EGRESS DOOR REFERRED TO IN SENTENCE 3.4.2.4.(2), (c) SERVES AN ASSEMBLY, CARE, TREATMENT, DETENTION OR RESIDENTIAL OCCUPANCY, OR (d) IS INSTALLED TO MEET THE REQUIREMENTS OF CLAUSE 3.3.1.7.(1)(B) OR SENTENCE 3.3.3.5.(4).

3.1.8.17 TEMPERATURE RISE LIMIT FOR DOORS:

(1)THE MAXIMUM TEMPERATURE RISE ON THE OPAQUE PORTION OF THE UNEXPOSED SIDE OF A DOOR USED ÀS A CLOSURE IN A FIRE SEPARATION IN A LOCATION SHOWN IN TABLE 3.1.8.17. SHALL CONFORM TO THE TABLE WHEN TESTED IN CONFORMANCE WITH SENTENCE 3.1.8.4.(1).

3.1.9.1 FIRE STOPS

(1): PENETRATIONS OF A FIRE SEPARATION OR A MEMBRANE REQUIRED TO HAVE A F.R.R. SHALL BE: (1)(a): SEALED BY A FIRESTOP (TESTED TO CAN/ULC-S115 STANDARDS), W/ AN 'F' RATING EQUAL TO THE F.R.R. REQUIRED FOR A CLOSURE IN THE FIRE SEPARATION, IN CONFORMANCE W/ T.3.1.8.4.

(1)(b): CAST IN PLACE OR (1)(c): TIGHTLY FITTED.

(2): PENETRATIONS OF THE ARTICLE 3.2.1.2., 2.0HR F.R.R. HORIZONTAL FIRE SEPARATION SHALL BE SEALED W/ A 2.0HR F.R.R. 'FT' RATED FIRESTOP SYSTEM TESTED TO CAN/ULCS115

3.1.17 OCCUPANT LOAD: BCBC 2012, DIV. B-PART 3, TABLE 3.1.17.1

TOTAL 102 PERSONS

RESIDENTIAL OCCUPANCY							
Level	Name	OCCUPANCY GROUP	Area	NO. OF BED ROOMS	OCCUPANT LOAD		
5TH FLOOR	UNIT 501	С	76 m²	2	4		
5TH FLOOR	UNIT 502	С	75 m²	2	4		
5TH FLOOR	UNIT 503	С	106 m²	3	6		
5TH FLOOR	UNIT 504	C	54 m²	1	2		
					16		
4TH FLOOR	UNIT 401	С	76 m²	2	4		
4TH FLOOR	UNIT 402	С	75 m²	2	4		
4TH FLOOR	UNIT 403	С	106 m²	3	6		
4TH FLOOR	UNIT 404	С	54 m²	1	2		
					16		
3RD FLOOR	UNIT 301	С	49 m²	1	2		
3RD FLOOR	UNIT 302	С	54 m²	1	2		
3RD FLOOR	UNIT 303	С	48 m²	1	2		
3RD FLOOR	UNIT 304	С	54 m²	1	2		
3RD FLOOR	UNIT 305	С	52 m²	1	2		
3RD FLOOR	UNIT 306	С	54 m²	1	2		
					12		
2ND FLOOR PLAN	UNIT 201	С	49 m²	1	2		
2ND FLOOR PLAN	UNIT 202	С	54 m²	1	2		
2ND FLOOR PLAN	UNIT 203	С	48 m²	1	2		
2ND FLOOR PLAN	UNIT 205	С	52 m²	1	2		
2ND FLOOR PLAN	UNIT 206	С	54 m²	1	2		
2ND FLOOR PLAN	UNIT 206	С	54 m²	1	2		
					12		
GROUND FLOOR	UNIT 101	С	55 m²	1	2		
GROUND FLOOR	UNIT 102	С	62 m²	2	4		
GROUND FLOOR	UNIT 103	С	105 m²	3	6		
			•	·	12		
RESIDENTIAL TOTAL C	CCUPANCY:				68		

OTHER GROUPS OCCUPANCY								
Level	Name	OCCUPANCY GROUP	Area	AREA PER PERSON	OCCUPANT LOAD			
GROUND FLOOR	AMENITY	Α	29.44 m ²	1.85 m ²	16			
GROUND FLOOR	BICYCLE STOR.	F3	23.82 m ²	46.00 m ²	1			
GROUND FLOOR	LOBBY	Α	8.39 m²	1.85 m²	5			
	21							
PARKING LEVEL L	BICYCLE STOR.	F3	49.39 m²	46.00 m ²	1			
PARKING LEVEL L	BICYCLE STOR.	F3	24.69 m²	46.00 m²	1			
PARKING LEVEL L	PPARKING SPACE	F3	506.87 m ²	46.00 m²	11			
13								

3.2.2 MAJOR OCCUPANCY CLASSIFICATION:

TOTAL OF OTHER GROUPS OCCUPANCY:

3.2.2.50. GROUP C (RESIDENTIAL), SPRINKLERED	41101475	
OTOREVO:	ALLOWED	PROPOSED
STOREYS:	6	5
BUILDING AREA:	1,800 m ²	1,778.06 m ²
CONSTRUCTION:	COMB. OR NON-COMB.	COMBUSTIBLE
FIRE RESISTANCE RATINGS:		
FLOORS	1 HR	1 HR
LOADBEARING WALLS, COLUMNS & ARCHES	1 HR	1 HR
ROOF:	1 HR	1 HR
3.2.1.2 STORAGE GARAGE AS SEPARATED BUILDING (1) ROOF OF STORAGE GARAGE WILL BE CONSTRUCTED AS F	FIRE SEPARATION OF 2HR I	FRR AND

(2)(a) THE STORAGE GARAGE IS SPRINKLED THROUGHOUT PROPOSED CONSTRUCTION: NON-COMBUSTIBLE NON-COMBUSTIBLE FIRE RESISTANCE RATINGS: LOADBEARING WALLS, COLUMNS & ARCHES 2 HR

2 HR

3.2.3 SPATIAL SEPARATION AND EXPOSURE PROTECTION

3.2.3.1 LIMITING DISTANCES

DIRECTION	FACING	LIMITING DISTANCE	
EAST	LONSDALE AVE	>9 m ((29.5 ft.)	
NORTH	PROPERTY LINE	2.44 m (8.0 ft.)	
SOUTH	PROPERTY LINE	2.44 m (8.0 ft.)	
WEST	LANE	7.3 m (23.9 ft.)	

TABLE 3.2.3.1.-D AND TABLE 3.2.3.7 - UNPROTECTEC OPENING LIMITS AND CONSTRUCTION SPECIFICATIONS FOR BUILDING THAT IS SPRINKLERED

	ELEVATION	WALL	۸۵۵۸	LIMITING	LIMITING	U	INPROTECT	ED OPENI	OPENINGS MINI			
ELEVATION	AND UNIT	AREA	AREA (SM)	DISTANCE	DISTANCE	ALLO	OWED	PRO	POSED	MIN. FIRE RATING	CONSTRUCTION TYPE	CLADDING TYPE
	NUMBER	(SF)	(OIVI)	(FT)	(M)	%	SQ FT	%	SQ FT	IVATING		
EAST	ELEVATION	3,220.00	299.15	23.95'	7.30 m	100.00	3,220.00			45 min	Combustible or Noncombustible	Noncombustible
NORTH	UNIT 203	270.87	25.16	8.00'	2.44 m	34.55	93.59	16.37	44.34	45 min	Combustible or Noncombustible	Noncombustible
NORTH	UNIT 204	302.45	28.10	8.00'	2.44 m	32.54	98.42	14.69	44.44	45 min	Combustible or Noncombustible	Noncombustible
NORTH	UNIT 303	270.87	25.16	8.00'	2.44 m	34.55	93.59	16.37	44.34	45 min	Combustible or Noncombustible	Noncombustible
NORTH	UNIT 304	302.45	28.10	8.00'	2.44 m	32.54	98.42	14.69	44.44	45 min	Combustible or Noncombustible	Noncombustible
NORTH	UNIT 102	270.87	25.16	8.00'	2.44 m	34.55	93.59	14.41	39.03	45 min	Combustible or Noncombustible	Noncombustible
NORTH	UNIT 502	270.87	25.16	8.00'	2.44 m	34.55	93.59	19.75	53.50	45 min	Combustible or Noncombustible	Noncombustible
NORTH	UNIT 503	302.45	28.10	8.00'	2.44 m	32.54	98.42	14.69	44.44	45 min	Combustible or Noncombustible	Noncombustible
SOUTH	UNIT 101	280.69	26.08	8.00'	2.44 m	34.67	97.32	6.53	18.34	45 min	Combustible or Noncombustible	Noncombustible
SOUTH	UNIT 201	268.87	24.98	8.00'	2.44 m	34.67	93.22	16.49	44.33	45 min	Combustible or Noncombustible	Noncombustible
SOUTH	UNIT 206	303.81	28.22	8.00'	2.44 m	32.44	98.56	14.64	44.48	45 min	Combustible or Noncombustible	Noncombustible
SOUTH	UNIT 206	303.81	28.22	8.00'	2.44 m	32.44	98.56	14.64	44.48	45 min	Combustible or Noncombustible	Noncombustible
SOUTH	UNIT 301	268.87	24.98	8.00'	2.44 m	34.67	93.22	16.49	44.33	45 min	Combustible or Noncombustible	Noncombustible
SOUTH	UNIT 306	303.81	28.22	8.00'	2.44 m	32.44	98.56	14.64	44.48	45 min	Combustible or Noncombustible	Noncombustible
SOUTH	UNIT 401	268.87	24.98	8.00'	2.44 m	34.67	93.22	19.90	53.50	45 min	Combustible or Noncombustible	Noncombustible
SOUTH	UNIT 404	303.81	28.22	8.00'	2.44 m	32.44	98.56	14.64	44.48	45 min	Combustible or Noncombustible	Noncombustible
SOUTH	UNIT 501	268.87	24.98	8.00'	2.44 m	34.67	93.22	16.49	44.33	45 min	Combustible or Noncombustible	Noncombustible
SOUTH	UNIT 504	303.81	28.22	8.00'	2.44 m	32.44	98.56	14.64	44.48	45 min	Combustible or Noncombustible	Noncombustible
WEST	ELEVATION			29.53'	9.00 m	100.00				45 min	Combustible or Noncombustible	Noncombustible

* LIMITING DISTANCE MORE THAN 7 METERS AND WALL AREA LESS THAN 50 m² IS ALLOWED FOR 100% UNPROTECTED OPENINGS (TABLE 3.2.3.1.-D) * * LIMITING DISTANCE MORE THAN 9 METERS IS ALLOWED FOR 100% UNPROTECTED OPENINGS (TABLE 3.2.3.1.-D)

3.2.4 FIRE ALARM & DETECTION SYSTEMS

3.2.4.1.(1) FIRE ALARM SYSYTEM IS REQUIRED

3.2.4.2.(1) - DIV. B: CONTINUITY OF THE FIRE ALARM SYSTEM IS REQUIRED

3.2.4.8.(2) - DIV. B: SIGNALS TO FIRE DEPARTMENT WATERFLOW INDICATING DEVICES SHALL BE DESIGNED TO NOTIFY THE FIRE DEPT. WHEN AN ALARM IS INITIALIZED IN CONFORMANCE W/ CAN/ULC-S561 FIRE ALARM & DETECTION SYSTEMS

3.2.4.9.(1) ANNUNCIATOR PANEL IS TO BE INSTALLED IN PROXIMITY TO BUILDING ENTRANCE 3.2.4.10.(1) - DIV. B: ELECTRICAL SUPERVISION IS REQUIRED FOR THE FIRE ALARM SYSTEM

3.2.4.12 SMOKE DETECTORS

(1)(d): TO BE INSTALLED IN GROUP C PUBLIC CORRIDORS (1)(e): TO BE INSTALLED IN EXIT STAIRS

(1)(g): TO BE INSTALLED IN ELEVATOR MACHINE ROOMS (4): SMOKE DETECTORS IN (1)(g) UPON ACTUATION, SHALL RECALL THE ELEVATOR

3.2.4.16. - DIV. B: SYSTEM MONITORING FOR WATERFLOW DETECTING DEVICES IS REQUIRED 3.2.4.17. - DIV. B: MANUAL PULL STATIONS ARE REQUIRED ON EVERY FLOOR LEVEL NEAR:

(1)(a): EVERY PRINCIPAL ENTRANCE

(1)(b): EVERY REQUIRED EXIT

(1)(c): EVERY OTHER EXIT FACILITY THAT HAS BEEN DESIGNED AS AN EXIT AND HAS ALL THE FEATURES OF A REQUIRED EXIT. 3.2.5.16.(1) - DIV. B: PORTABLE FIRE EXTINGUISHERS SHALL BE PROVIDED AND INSTALLED PER THE BC FIRE CODE

3.2.4.20. - DIV. B: VISUAL SIGNALS ARE REQUIRED

3.2.4.21.(1) - DIV. B: SMOKE ALARMS CONFORMING TO CAN/ULC-S531, ARE TO BE INSTALLED IN CONFORMANCE W/ CAN/ULC-S553, W/IN EACH DWELLING UNIT AND:

(3)(a)&(b): INSTALLED W/IN EACH SLEEPING ROOM AND IN A LOCATION BETWEEN THE SLEEPING ROOM AND THE REST OF THE STOREY

(5): INSTALLED ON OR NEAR THE CEILING (7)(c): INSTALLED W/ PERMANENT CONNECTIONS TO AN ELECTRICAL CIRCUIT C/W BATTERY BACKUP CAPABLE OF 7 DAY NORMAL USE AND 4 MINUTES OF ALARM (9): TO BE INTERCONNECTED W/IN THE DWELLING UNIT

3.2.5 PROVISIONS FOR FIRE FIGHTING

3.2.5.3 ROOF ACCESS IS REQUIRED - 610mm X 910mm ROOF ACCESS HATCH WITH A FIXED LADDER IS PROVIDED IN STAIR A AND STAIR B.

3.2.5.4.(1)(a) FIRE ACCESS ROUTE - AN ACCESS ROUTE IS PROVIDED TO THE BUILDING FACE HAVING THE PRINCIPAL ENTRANCE 3.2.5.6 ACCESS ROUTE DESIGN:

(1)(a): CLEAR WIDTH OF 6.0m PROVIDED

(1)(c): OVERHEAD CLEARANCE OF 5.0m PROVIDED

(1)(d): GRADIENT CHANGE NOT MORE THAN 1 IN12.5 OVER A MIN. DISTANCE OF 15m

(1)(e): CONCRETE OR ASPHALT SURFACE TO BE DESIGNED TO SUPPORT EXPECTED FIRE FIGHTING EQUIPMENT LOADS (1)(f): TURNAROUND IS LESS THAN 90m

(1)(a): CONNECTED WITH A PUBLIC THOROUGHFARE

3.2.5.12 AUTOMATIC SPRINKLER SYSTEMS (1): AUTOMATIC SPRINKLER SYSTEM SHALL BE DESIGNED, CONSTRUCTED, INSTALLED AND TESTED IN CONFORMANCE WITH NFPA13

(6): SPRINKLERS SHALL NOT TO BE OMMITTED IN ANY ROOM OR CLOSET IN THE STOREY IMMEDIATELY BELOW A ROOF ASSEMBLY. (7): FAST RESPONSE SPRINKLERS SHALL BE INSTALLED IN RESIDENTIAL OCCUPANCIES

(8): SPRINKLERS INSTALLED IN ELEVATOR MACHINE ROOMS SHALL HAVE A TEMPERATURE RATING NOT LESS THAT REQUIRED FOR AN INTERMEDIATE TÉMPERATURE CLASSIFICATION AND SHALL BE PROTECTED AGAINST DAMAGE.

3.2.5.14 SPRINKLER SERVICE SPACE (1): AUTOMATIC SPRINKLER SYSTEM IS INSTALLED IN THE UG MECHANICAL ROOM

(2): WATERFLOW DETECTING DEVICES ARE REQUIRED (SEE SPRINKLER DWGS)

(3)(a): WATERFLOW DETECTING DEVICES ARE TO BE CONNECTED TO THE FIRE ALARM SYSTEM, (SEE SPRINKLER DWGS)

3.2.5.15.(2) FIRE DEPARTMENT CONNECTION: 14m (45m MAX.) UNOBSTRUCTED DISTANCE BETWEEN THE FIRE DEPARTMENT CONNECTION & THE FIRE HYDRANT PROVIDED

3.3.4 RESIDENTIAL OCCUPANCY FIRE SEPARATION

3.3.4.2 SUITS OF RESIDENTIAL OCCUPANCY SHALL BE SEPERATED FROM EACH OTHER AND THE REMINDER OF BUILDING BY 1 HR FRR

3.3.4.3 STORAGE ROOMS (1) SPRINKLERS SHALL BE INSTALLED IN STORAGE ROOMS

(2) STORAGE ROOMS SHALL BE SEPARATED FROM REMINDER OF BUILDING BY FIRE SEPARATION FRR 1HR 3.3.4.8 PROTECTION OF OPENABLE WINDOWS

(2) WINDOW OPENINGS LOCATED HIGHER THAN 1070mm ABOVE THE FINISHING FLOOR

3.3.5.6 STORAGE GARAGE SEPARATION

3.3.5.4 STORAGE GARAGE

(1): A VESTIBULE, CONFORMING TO 3.3.5.7.(4)(a), IS REQUIRED BETWEEN THE STORAGE GARAGE AND THE STAIRWELLS & THE ELEVATOR (4): NATURAL OR MECHANICAL VENTILATION IS TO BE PROVIDED TO THE STORAGE GARAGE TO PREVENT EXCESSIVE ACCUMULATION OF CARBON MONOXIDE, EXHAUST FUMES OR FLAMMABLE & TOXIC VAPOURS.

(5): 2.0m MIN. CLEAR HEIGHT IS REQUIRED (7): SPRINKLERS ARE REQUIRED.

3.3.5.6.(1) STORAGE GARAGE SHAL BE SEPARATED FROM OTHER OCCUPANCIES BY 1.5 FRR FIRE SEPARATION 3.3.5.7 VESTIBULES

(3) STORAGE GARAGE ACCESS TO BUILDING THROUGH A VESTIBULE (4)(a) 2.47m LONG (MIN 1.8M)

(4)(c) SELF-CLOSING WITH NO HOLD-OPEN DEVICES

3.4 EXITS

3.4.2.1 MINIMUM NUMBER OF EXITS

(1) EVERY FLOOR AREA INTENDED FOR OCCUPANCY SHALL BE SERVED BY AT LEAST 2 EXITS.

3.4.2.3 DISTANCE BETWEEN EXITS (1)(a) DISTANCE BETWEEN TWO EXITS SHAL BE ONE HALF THE MAXIMUM DIAGONAL DIMENTION OF FLOOR PLAN AND LOT MAKE THAN 9m

	DISTANCE BETWEE	N EXITS
Level	LENGTH (M)	DIAGONAL DIMENSION OF FLOOR LEVEL
		W 10 V
PARKING LEVEL L	36.09 m	37.13
GROUND FLOOR	8.38 m	24.98
2ND FLOOR PLAN	8.31 m	24.98
3RD FLOOR	8.31 m	24.98
4TH FLOOR	8.31 m	24.98
5TH FLOOR	8.31 m	24.98

3.4.2.5 LOCATION OF EXITS (TRAVEL DISTANCE)

(1)(c): ALLOWED: 45m MAX. IN PARKADE & RESIDENTIAL FLOOR LEVELS PROVIDED: <45m TRAVEL DISTANCE

TRAVEL DISTANCE					
Base Level	LABEL	Length(M)			
PARKING LEVEL L	A	26.23 m			
PARKING LEVEL L	В	31.14 m			
PARKING LEVEL L	С	22.38 m			
PARKING LEVEL L	D	27.60 m			
GROUND FLOOR	A	1.65 m			
GROUND FLOOR	В	1.68 m			
2ND FLOOR PLAN	A	7.88 m			
3RD FLOOR	A	7.88 m			
4TH FLOOR	A	7.88 m			
5TH FLOOR	A	7.88 m			

TABLE 3.4.3.2.A EXIT WIDTH

CORRIDORS:	REQUIRED: 1,100 mm	PROVIDED: 1,500 mm
STAIRS:	REQUIRED: 1,100 mm	PROVIDED: 1,140 mm
DOORWAYS:	REQUIRED: 800 mm	PROVIDED: 870 mm

3.4.3.3 EXIT WIDTH REDUCTION

(1)EXCEPT AS PERMITTED BY SENTENCES (2) AND (4), NO FIXTURE, TURNSTILE OR CONSTRUCTION SHALL PROJECT INTO OR BE FIXED WITHIN THE REQUIRED.

(2) SWINGING DOORS IN THEIR SWING SHALL NOT REDUCE THE REQUIRED WIDTH OF EXIT STAIRS OR LANDINGS TO LESS THAN 750 MM OR REDUCE THE WIDTH OF AN EXIT PASSAGEWAY TO LESS THAN THE MINIMUM REQUIRED WIDTH. (3)DOORS SHALL BE INSTALLED SO THAT, WHEN OPEN, THEY DO NOT DIMINISH NOR OBSTRUCT THE REQUIRED WIDTH OF THE EXIT.

(4)HANDRAILS AND CONSTRUCTION BELOW HANDRAILS, INCLUDING HANDRAIL SUPPORTS AND STAIR STRINGERS, SHALL NOT PROJECT MORE THAN 100 MM INTO THE REQUIRED WIDTH OF A MEANS OF EGRESS.

3.4.4.1 FIRE RESISTANCE RATING OF EXIT SEPARATIONS

(1)(a&b):PARKADE STAIRS = 2.0HR F.R.R. FIRE SEPARATION RESIDENTIAL LEVEL STAIRS = 1.0HR F.R.R. FIRE SEPARATION

3.4.5.1 EXIT SIGNS

(1)(a&b): EVERY EXIT DOOR SHALL HAVE AN EXIT SIGN PLACED OVER OR ADJACENT TO IT

3.4.5.2 SIGNS FOR STAIRS AND RAMPS AT EXIT LEVEL (1): AT THE EXIT LEVELS OF STAIRS #1&2, A SIGN SHALL BE CLEARLY POSTED INDICATING THAT THERE IS NO EXIT BELOW THIS LEVEL

3.4.6.16 DOOR RELEASE HARDWARE (2)(b): PANIC HARDWARE IS REQUIRED ON ALL EXTERIOR EXIT DOORS, AS THE BUILDING HAS AN OCCUPANT LOAD GREATER THAN 100

3.4.6.19 FLOOR NUMBERING (1): ARABIC NUMERALS INDICATING THE ASSIGNED FLOOR NUMBER SHALL:

(1)(a): BE PERMANENTLY MOUNTED ON STAIR SIDE OF THE WALL AT LATCH SIDE OF DOORS TO THE EXIT SHAFT

(1)(b): BE NOT LESS THAN 60mm HIGH, RAISED 0.7mm ABOVE THE SURFACE (1)(c): BE 1500mm ABOVE THE FLOOR, AND NOT MORE THAN 300mm FROM THE DOOR

(1)(d): BE IN CONTRASTING IN COLOUR TO THE SURFACE TO WHICH IT IS BEING APPLIED

3.5 VERTICAL TRANSPORTATION

3.5.4.2 FLOOR NUMBERING

(1): ARABIC NUMERALS INDICATING THE FLOOR NUMBER SHALL BE MOUNTED ON BOTH JAMBS OF THE ELEVATOR DOOR ENTRANCE IN CONFORMANCE W/ APPENDIX. E OF ASME A17.1/CSA-B44.

T.3.5.3.1 FIRE SEPARATIONS FOR VERTICAL TRANSPORTATION SPACE

ELEVATOR: (PARKADE LEVEL) REQUIRED: 2.0HR PROVIDED: 2.0HR (RESIDENTIAL LEVELS) REQUIRED: 1.0HR PROVIDED: 1.0HR

3.6.2 SERVICE ROOMS

3.6.2.1 FIRE SEPARATION AROUND SERVICE ROOMS

(1) EXCEPT AS PERMITTED BY SENTENCES (2), (8), (9) AND (10), FUEL-FIRED APPLIANCES SHALL BE INSTALLED IN SERVICE ROOMS SEPARATED FROM THE RÉMAINDER OF THE BUILDING BY FIRE SEPARATIONS HAVING A FIRE-RESISTANCE RATING NOT LESS THAN 1 H.

(6) ELECTRICAL EQUIPMENT THAT IS REQUIRED TO BE LOCATED IN A SERVICE ROOM ACCORDING TO THE ELECTRICAL SAFETY REGULATION SHALL BE INSTALLED IN A SERVICE ROOM SEPARATED FROM THE REMAINDER OF THE BUILDING BY A FIRE SEPARATION HAVING

A FIRE-RESISTANCE RATING NOT LESS THAN 1 H. (8) WHERE A SERVICE ROOM CONTAINS A LIMITED QUANTITY OF SERVICE EQUIPMENT, AND THE SERVICE EQUIPMENT NEITHER CONSTITUTES A FIRE HAZARD NOR IS ESSENTIAL TO THE OPERATION OF FIRE SAFETY SYSTEMS IN THE BUILDING, THE REQUIREMENTS FOR A FIRE SEPARATION

3.6.2.5. COMBUSTIBLE REFUSE STORAGE

SHALL NOT APPLY.

(1) EXCEPT AS REQUIRED BY SENTENCE 3.6.3.3.(9), A ROOM FOR THE STORAGE OF COMBUSTIBLE REFUSE SHALL BE

(a) SEPARATED FROM THE REMAINDER OF THE BUILDING BY A FIRE SEPARATION WITH A FIRE-RESISTANCE RATING NOT LESS THAN 1 H, AND (b) SPRINKLERED.

3.6.3.1 FIRE SEPARATION FOR VERTICAL SERVICE SPACES

T3.6.3.1.(1) FIRE SEPARATION FOR VERTICAL SERVICE SPACES REQUIRED: 1HR PROVIDED: 1 HR

5.8 SOUND TRANSMISSION

LESS THAN 55.

BUILDING ENVELOPE REQUIREMENTS:

5.8.1.1. REQUIRED PROTECTION

(1) EXCEPT AS PROVIDED IN SENTENCE (2), A DWELLING UNIT SHALL BE SEPARATED FROM EVERY OTHER SPACE IN A BUILDING IN WHICH NOISE MAY BE

(1)(a) A SEPARATING ASSEMBLY AND ADJOINING CONSTRUCTIONS, WHICH, TOGETHER, PROVIDE AN APPARENT SOUND TRANSMISSION CLASS (ASTC) RATING NOT LESS THAN 47. OR

(1)(b) A SEPARATING ASSEMBLY THAT PROVIDES A SOUND TRANSMISSION CLASS (STC) RATING OF NOT LESS THAN 50 AND ADJOINING

CONSTRUCTIONS THAT CONFORM TO ARTICLE 9.11.1.4. (2) CONSTRUCTION SEPARATING A DWELLING UNIT FROM AN ELEVATOR SHAFT OR A REFUSE CHUTE SHALL HAVE AN STC RATING NOT

HEAT TRANSFER, AIR LEAKAGE, VAPOUR DIFFUSION TO MEET THE REQUIREMENTS OF BCBC 2018, SECTION 5.3 TO 5.7.

ASHRAE: 90.1-2019 CLIMATE ZONE: 4C

DOOR AND WINDOW OPENINGS TO COMPLY WITH TABLE 5.5-4 OF ASHRAE 90.1-2019

AT DRAWN CHECKED Checker PROJECT NO. 22042

2025 Willingdon Avenue #900, Burnaby, BC. V5C 0J3 T: 604.780.6461 604.780.3243 WWW.M-AARCHITECTS.COM WWW.MAARCHITECTSLTD.COM

MA ARCHITECTS LTD

NO. DATE Y/M/D DESCRIPTION

ISSUES AND REVISIONS

SEAL

2023/01/27 ISSUED FOR LEGAL DOC.

2023/01/23 ISSUED FOR CONSULTANT

2023/01/19 ISSUED FOR CLIENT REVIEW

2023/01/10 ISSUED FOR CLIENT REVIEW

2022/12/09 ISSUED FOR CONSULT. USES

COPYRIGHT NOTICE: All rights reserved. All ideas, designs, drawings and reproductions either in print or electronic format, are the property of MA ARCHITECTS Ltd., and are an instrument of service that may not be used, forwarded to others, transmitted, downloaded or reproduced either in print or electronic format, without the express written permission of the copyright owner.

Written dimensions shall have precedence over scaled dimensions. Contractors shall verify and be responsible for all dimensions and conditions on the job; shall request clarification of errors, discrepancies, or doubtful information contained in contract drawings and documents. Failure to obtain such clarification renders the Contractor responsible for any resulting improper work and the cost of rectification.

PROJECT NAME

LONSDALE RESIDENTAL **APARTMENT**

PROJECT ADDRESS 2612 LONSDALE AVE, NORTH

VANCOUVER

BC CODE ANALYSIS

SCALE 1/4" = 1'-0" DRAWING NO.

THIS DRAWING IS PROPERTY OF MA ARCHITECTS LTD. AND SHOULD NOT BE COPIED OR DISTRIBUTED WITHOUT PRIOR WRITTEN CONSENT

GENERAL CLASSIFICATION AND CODE COMPLIANCE **BC BUILDING CODE 2018**

3.8 ACCESSIBILITY

3.8.3.2. ACCESSIBLE PATH OF TRAVEL

(1) EXCEPT AS REQUIRED ELSEWHERE IN THIS PART OR AS PERMITTED BY ARTICLE 3.8.3.6. PERTAINING TO DOORWAYS, AN ACCESSIBLE PATH OF TRAVEL SHALL (1)(a) EXCEPT FOR HANDRAILS, THAT ARE PERMITTED TO PROJECT NOT MORE THAN 100 MM FROM EITHER OR BOTH SIDES INTO THE CLEAR AREA, AN

UNOBSTRUCTED WIDTH OF NOT LESS THAN 1 500 MM (5) AN ACCESSIBLE PATH OF TRAVEL SHALL BE EQUIPPED TO PROVIDE ILLUMINATION IN ACCORDANCE WITH SENTENCES 3.2.7.1.(1) AND (2). (SEE ALSO SENTENCE 3.2.7.1.(3) AND ARTICLE 9.34.2.7.)

3.8.3.6. DOORWAYS AND DOORS

(2) EVERY DOORWAY THAT IS LOCATED IN AN ACCESSIBLE PATH OF TRAVEL SHALL HAVE A CLEAR WIDTH NOT LESS THAN 850 MM (3) DOORWAYS IN AN ACCESSIBLE PATH OF TRAVEL TO AT LEAST ONE BATHROOM WITHIN AN ACCESSIBLE SUITE OF RESIDENTIAL OCCUPANCY SHALL HAVE A

CLEAR WIDTH NOT LESS THAN 810 MM WHEN MEASURED IN ACCORDANCE WITH CLAUSES (2)(A) AND (B).

(SEE ARTICLE 3.8.2.12. AND NOTE A-3.8.3.6.(3).) (4) DOOR-OPERATING DEVICES SHALL BE GRASPABLE AND OPERABLE

(a) IN ACCORDANCE WITH CLAUSE 3.8.3.8.(1)(C), AND (b) BE OPERABLE AT A HEIGHT BETWEEN 900 MM AND 1 100 MM ABOVE THE FLOOR

3.8.3.8. CONTROLS AND OUTLETS

(1)(A) BE MOUNTED 455 MM TO 1 200 MM ABOVE THE FLOOR

3.8.3.11. WATER-CLOSET STALLS

(1) WATER-CLOSET STALLS AND ENCLOSURES REQUIRED BY SENTENCE 3.8.2.8.(5) SHALL (a) BE NOT LESS THAN 1500 MM WIDE BY 1500 MM DEEP

(d) HAVE A WATER CLOSET LOCATED SO THAT THE DISTANCE BETWEEN THE CENTRE LINE OF THE FIXTURE AND THE WALL ON ONE SIDE ÌS 460 MM TO 480 MM,

BATHROOM:

(i) CONFORMING TO CLAUSES 3.8.3.11.(1)(A) AND (D) WITH A WATER CLOSET CONFORMING TO ARTICLE 3.8.3.13.,

(ii) PROVIDED WITH GRAB BARS CONFORMING TO CLAUSES 3.8.3.11.(1)(E) AND (F) (iii) PROVIDED WITH A LAVATORY AND MIRROR CONFORMING TO ARTICLE 3.8.3.15., AND

(iv) PROVIDED WITH A BATHTUB CONFORMING TO ARTICLE 3.8.3.17. OR A SHOWER CONFORMING TO ARTICLE 3.8.3.16., ONLY TO THE EXTENT OF PROVIDING THE SAME TYPE OF FACILITIES PROVIDED IN SLEEPING ROOMS AND BED SPACES WHERE ACCESS IS NOT REQUIRED.

3.8.5. ADAPTABLE DWELLING UNITS

3.8.5.3. BUILDING ACCESS REQUIREMENTS

(2) CORRIDORS AND PASSAGEWAYS PROVIDING ACCESS TO ADAPTABLE DWELLING UNIT ENTRANCES AND COMMON FACILITIES SHALL

(a) BE NOT LESS THAN 1 220 MM IN WIDTH, AND (b) PROVIDE A CLEAR FLOOR SPACE NOT LESS THAN 1 500 MM BY 1 500 MM

(I) ADJACENT TO THE ELEVATOR ENTRANCE, AND

(II) AT INTERVALS NOT EXCEEDING 9 M MEASURED FROM THE ELEVATOR ENTRANCE TO THE END OF THE CORRIDOR OR PASSAGEWAY. (3) EXCEPT AS PERMITTED IN SENTENCE 3.8.5.4.(1), DOORWAYS AND DOORS IN THE ACCESSIBLE PATH OF TRAVEL THROUGHOUT THE BUILDING SHALL COMPLY WITH ARTICLE 3.8.3.6.

3.8.5.4. ADAPTABLE DWELLING UNIT DOORWAYS

(1) WITHIN AN ADAPTABLE DWELLING UNIT, DOORWAYS PROVIDING ACCESS TO COMMON LIVING AREAS AND AT LEAST ONE BATHROOM AND ONE BEDROOM SHALL HAVE A CLEAR WIDTH OF NOT LESS THAN 810 MM WHEN MEASURED IN ACCORDANCE WITH CLAUSES 3.8.3.6.(2)(A) AND (B). (SEE NOTE A-3.8.5.4.(1).)

3.8.5.5. ADAPTABLE DWELLING UNIT BATHROOMS

(1) THE BATHROOM REFERRED TO IN SENTENCE 3.8.5.4.(1) SHALL BE DESIGNED TO BE ADAPTABLE FOR USE BY PERSONS USING WHEELCHAIRS BY PROVIDING (a) A DIMENSION FROM THE FRONT EDGE OF THE WATER CLOSET TO THE FACING WALL OF NOT LESS THAN 800 MM,

(b) A DIMENSION FROM THE FRONT FACE OF THE BATHTUB OR SHOWER TO THE CENTRE LINE OF THE WATER CLOSET NOT LESS THAN 510 MM, AND

(c) A CLEAR FLOOR SPACE IN FRONT OF THE LAVATORY NOT LESS THAN 760 MM WIDE BY 1 350 DEEP CENTRED ON THE LAVATORY, AND (d) A CLEAR FLOOR SPACE, EXCLUSIVE OF DOOR SWING, NOT LESS THAN 760 MM WIDE BY 1 350 MM DEEP CONNECTING TO THE

ROUTE THROUGH THE DOORWAY.

(2) WALLS ADJACENT TO THE WATER CLOSET AND BATHTUB OR SHOWER SHALL ACCOMMODATE THE FUTURE INSTALLATION OF GRAB

BARS CONFORMING TO

(a) CLAUSES 3.8.3.11.(1)(E) AND (F) FOR WATER CLOSETS. AND (b) CLAUSE 3.8.3.16.(1)(F) FOR SHOWERS OR 3.8.3.17.(1)(F) FOR BATHTUBS.

(SEE NOTE A-3.8.5.5.(2).)

3.8.5.6. ADAPTABLE DWELLING UNIT KITCHENS

(1) THE KITCHEN IN AN ADAPTABLE DWELLING UNIT SHALL BE DESIGNED SO THAT THE COOKTOP AND SINK ARE ADJACENT OR CAN HAVE A CONTINUOUS

3.8.5.7. CONTROLS, SWITCHES AND OUTLETS

1) CONTROLS AND SWITCHES INTENDED FOR OCCUPANT USE, INCLUDING ELECTRICAL, TELEPHONE, CABLE AND DATA OUTLETS SHALL BE MOUNTED 455 MM TO 1 200 MM ABOVE THE FLOOR.



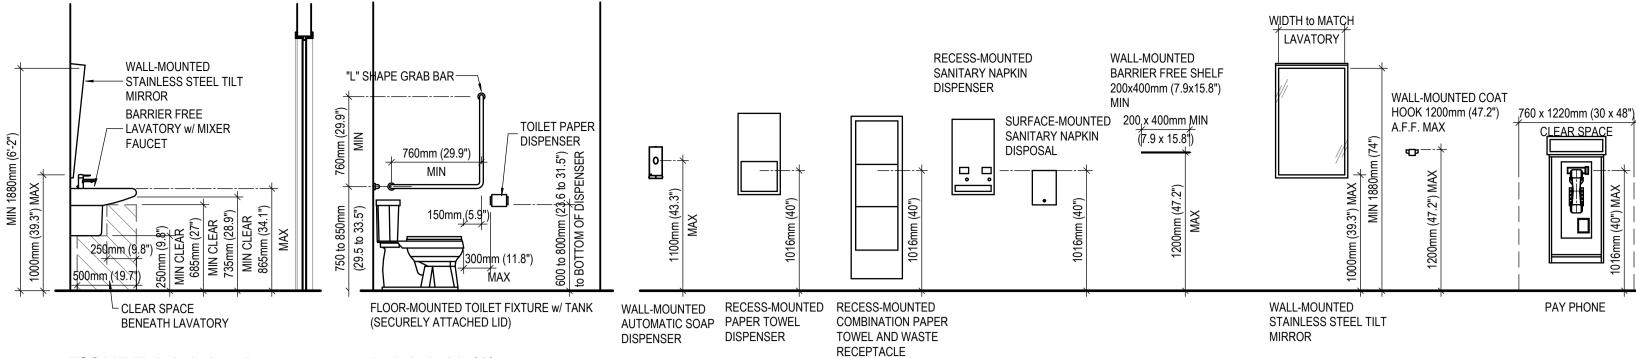


FIGURE 3.8.3.15.-A **SECTION AT LAVATORY**


A-3.8.3.13.(1) **SECTION AT TOILET**


B.C. BUILDING ACCESSIBILITY HANDBOOK 2020- FIGURE 3.8.3.15.-B WASHROOM ACCESSORIES

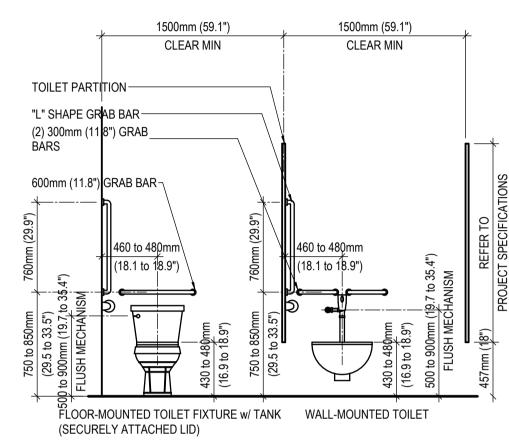

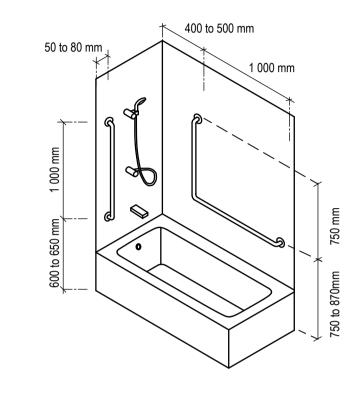


A-3.8.5.5 ADAPTABLE DWELLING UNIT BATHTUBS A-3.8.3.13.(1) TOILET STALLS

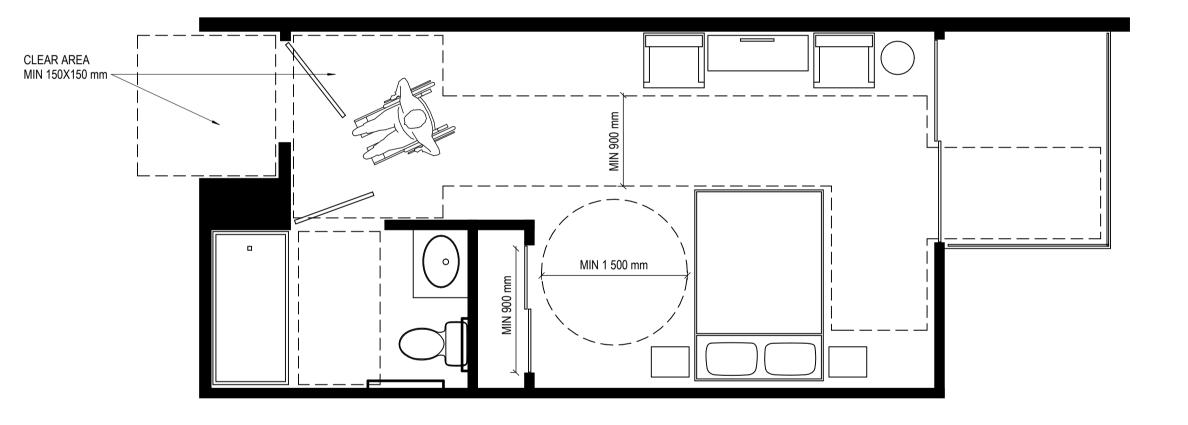

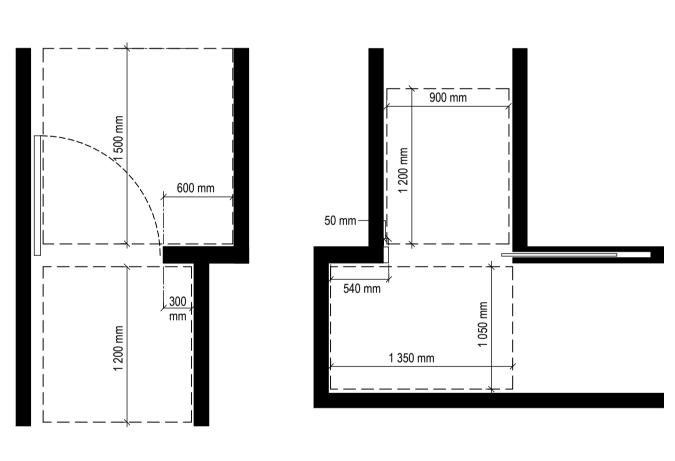

A-3.8.3.22 SLEEPING ROOM AND BED SPACES

A-3.8.3.6.(11) CLEARANCE AT DOORWAYS

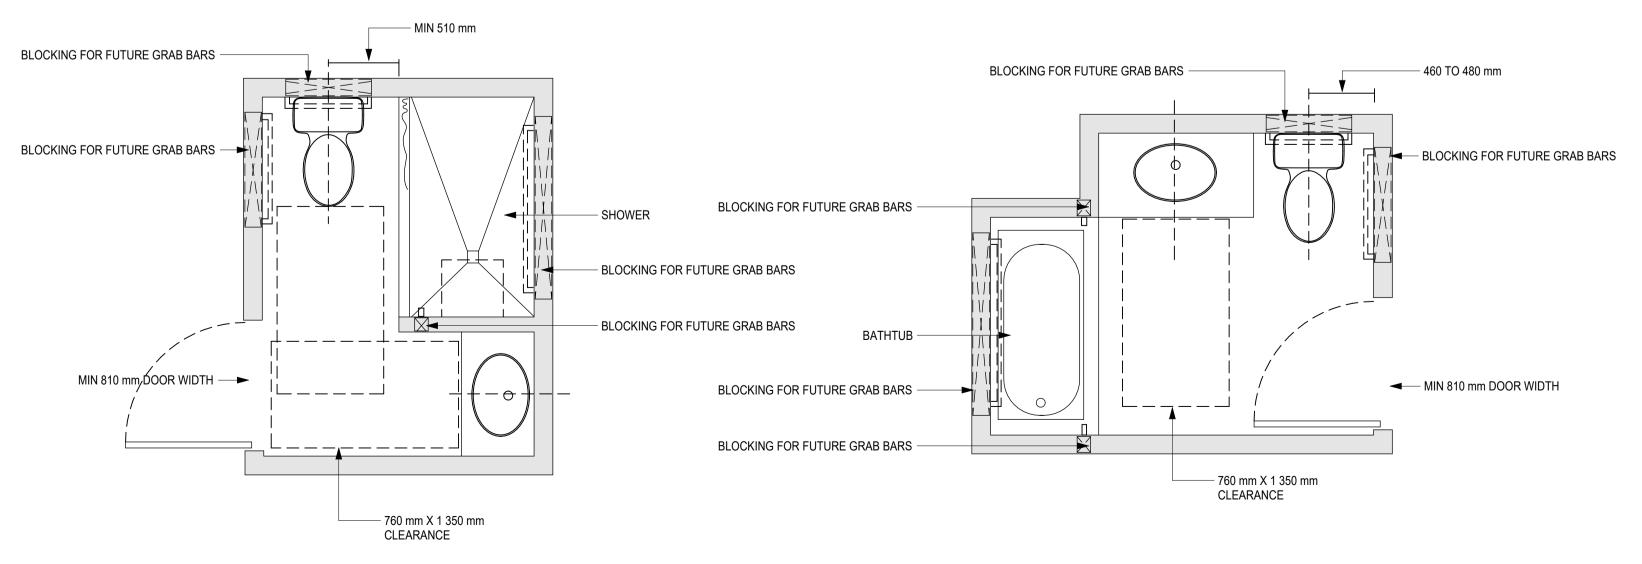

WASHROOM CLEAR SPACES

MA ARCHITECTS LTD. 2025 Willingdon Avenue #900, Burnaby, BC. V5C 0J3 T: 604.780.6461 604.780.3243 WWW.M-AARCHITECTS.COM WWW.MAARCHITECTSLTD.COM

2023/01/27 ISSUED FOR LEGAL DOC. 2023/01/23 ISSUED FOR CONSULTANT 2023/01/19 ISSUED FOR CLIENT REVIEW 2023/01/10 ISSUED FOR CLIENT REVIEW 2022/12/09 ISSUED FOR CONSULT. USES NO. DATE Y/M/D DESCRIPTION ISSUES AND REVISIONS

SEAL

COPYRIGHT NOTICE: All rights reserved. All ideas, designs, drawings and reproductions either in print or electronic format, are the property of MA ARCHITECTS Ltd., and are an instrument of service that may not be used, forwarded to others, transmitted, downloaded or reproduced either

in print or electronic format, without the express written

Written dimensions shall have precedence over scaled dimensions. Contractors shall verify and be responsible for all dimensions and conditions on the job; shall request clarification of errors, discrepancies, or doubtful information contained in contract drawings and documents. Failure to obtain such clarification renders the Contractor responsible for any resulting improper work and the cost of rectification.

permission of the copyright owner.

PROJECT NAME

LONSDALE RESIDENTAL **APARTMENT**

PROJECT ADDRESS

2612 LONSDALE AVE, NORTH VANCOUVER

DRAWING TITLE

DRAWING NO.

BC CODE ANALYSIS-**ACCESSIBILITY**

SCALE As indicated AT DRAWN CHECKED Checker PROJECT NO. 22042

> THIS DRAWING IS PROPERTY OF MA ARCHITECTS LTD. AND SHOULD NOT BE COPIED OR DISTRIBUTED
> WITHOUT PRIOR WRITTEN CONSENT.

A00.22




2025 Willingdon Avenue #900, Burnaby, BC. V5C 0J3 T: 604.780.6461 604.780.3243 WWW.M-AARCHITECTS.COM WWW.MAARCHITECTSLTD.COM



1 CODE ANALYSIS- EAST- OPENING

443.68 ft 443.68 ft

8'-0" (2.44 m) SETBACK

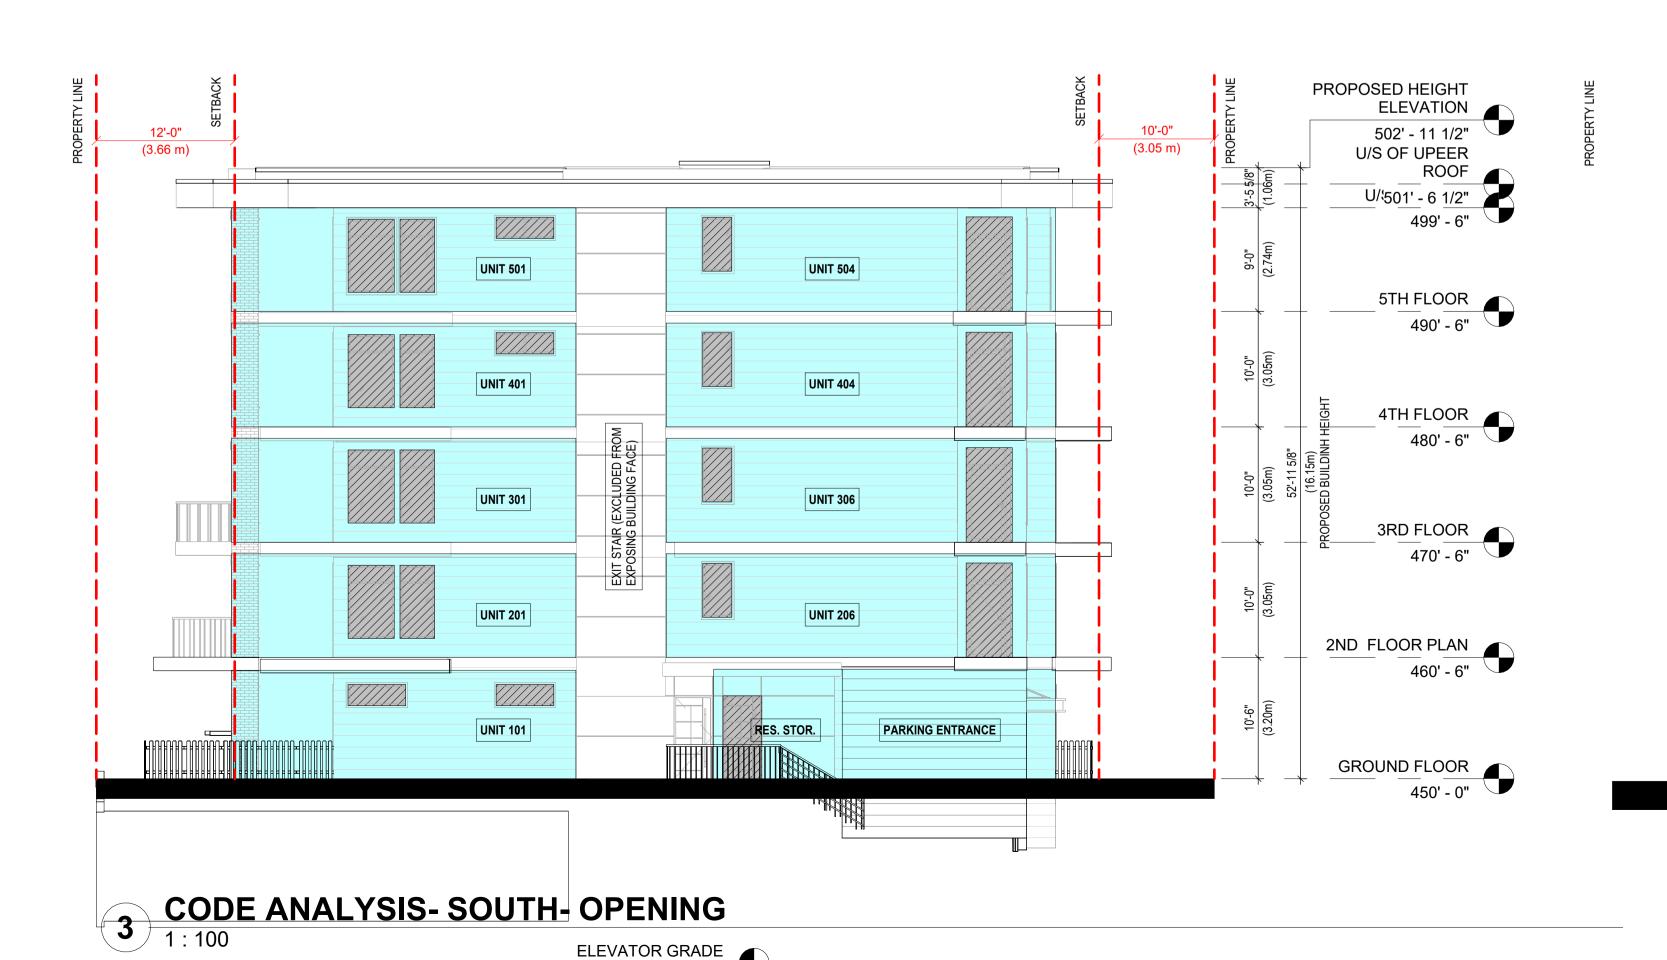

ELEVATOR GRADE
434' - 0"

2 CODE ANALYSIS- WEST- OPENING
1: 100

PROPOSED HEIGHT

8'-0" SETBACK SETBACK

449.00 ft

ELEVATION _

502' - 11 1/2"

ROOF _

499' - 6"

501' - 6 1/2"

U/S OF ROOF

5TH FLOOR 490' - 6"

4TH FLOOR

3RD FLOOR 470' - 6"

460' - 6"

451' - 0 1/2"

450' - 0"

2ND FLOOR PLAN

AVARAGE GRADE

GROUND FLOOR

PARKING LEVEL L


ELEVATOR GRADE 1/2

439' - 0" PARKING LEVEL

434' - 0"

480' - 6"

U/S OF UPEER

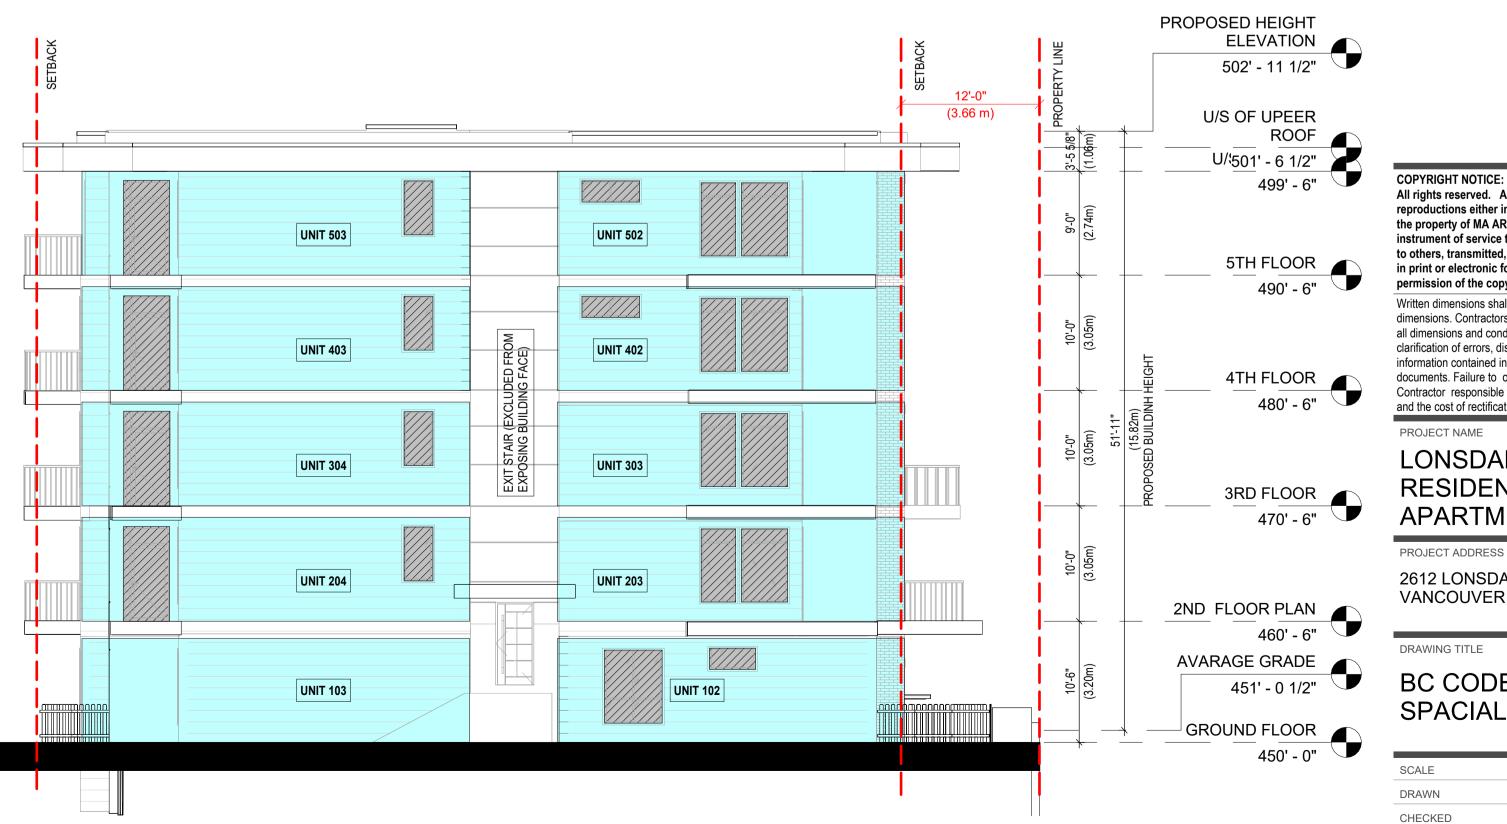

4 CODE ANALYSIS- NORTH- OPENING
1: 100

All rights reserved. All ideas, designs, drawings and reproductions either in print or electronic format, are the property of MA ARCHITECTS Ltd., and are an instrument of service that may not be used, forwarded to others, transmitted, downloaded or reproduced either in print or electronic format, without the express written permission of the copyright owner. Written dimensions shall have precedence over scaled dimensions. Contractors shall verify and be responsible for all dimensions and conditions on the job; shall request clarification of errors, discrepancies, or doubtful information contained in contract drawings and

2023/01/27 ISSUED FOR LEGAL DOC. 2023/01/23 ISSUED FOR CONSULTANT

2023/01/19 ISSUED FOR CLIENT REVIEW 2023/01/10 ISSUED FOR CLIENT REVIEW

2022/12/09 ISSUED FOR CONSULT. USES

NO. DATE Y/M/D DESCRIPTION

ISSUES AND REVISIONS

documents. Failure to obtain such clarification renders the Contractor responsible for any resulting improper work and the cost of rectification. PROJECT NAME

LONSDALE RESIDENTAL **APARTMENT**


PROJECT ADDRESS 2612 LONSDALE AVE, NORTH VANCOUVER

BC CODE ANALYSIS-SPACIAL SEPARATION

SCALE 1:100 AP DRAWN CHECKED Checker PROJECT NO. 22042

DRAWING NO. A00.23

THIS DRAWING IS PROPERTY OF MA ARCHITECTS LTD. AND SHOULD NOT BE COPIED OR DISTRIBUTED
WITHOUT PRIOR WRITTEN CONSENT.

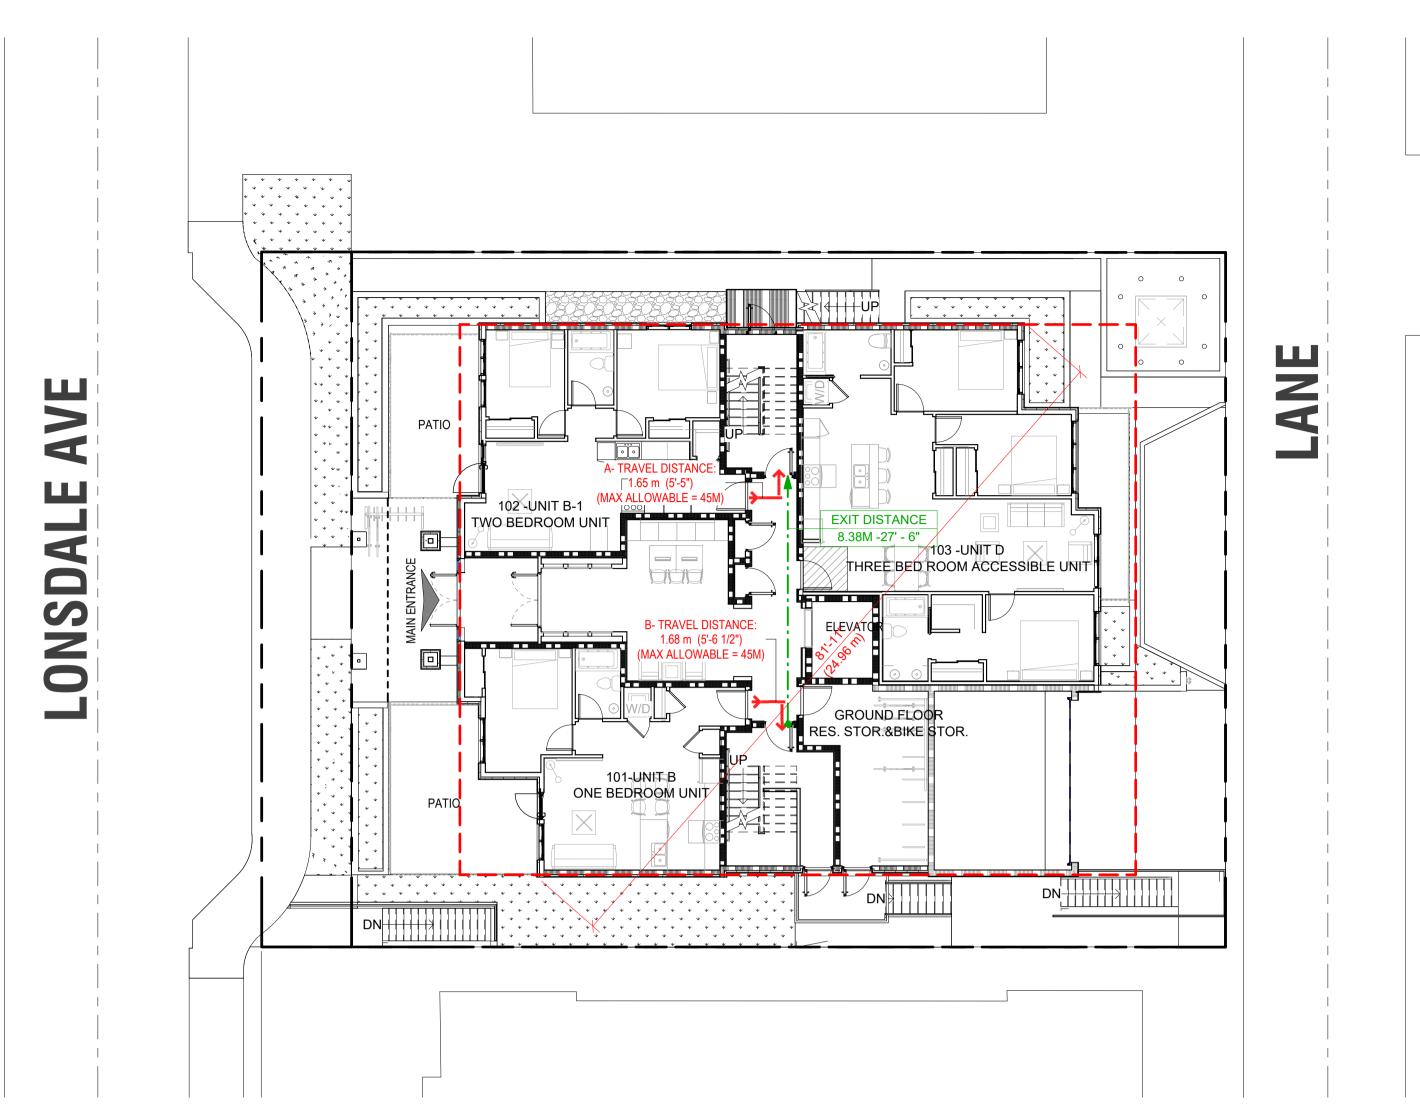

FIRE SEPARATION LEGEND 0 HR FRR FIRE SEPARATION 3/4 HR FRR FIRE SEPARATION 1 HR FRR FIRE SEPARATION 1.5 HR FRR FIRE SEPARATION 2 HR FRR FIRE SEPARATION

1 CODE ANALYSIS- GROUND FLOOR
3/32" = 1'-0"

CANOPY BELOW 203 -UNIT F-1 ONE BED ROOM UNIT 204 -UNIT A ONE BED ROOM UNIT 202 -UNIT E 205 -UNIT A-1 ONE BED ROOM ACCISSIBLE UNIT ONE BED ROOM ACCESSIBLE UNIT ___7.96 m (26'-1") 🕌 X ALLOWABLE = 45M) 206 -UNIT A ONE BED ROOM UNIT 201 -UNIT F-2 ONE BED ROOM UNIT **CANOPY BELOW** PRIVACY SCREEN FROM 2TH TO 4TH

FIRE SEPARATION LEGEND 0 HR FRR FIRE SEPARATION 3/4 HR FRR FIRE SEPARATION 1 HR FRR FIRE SEPARATION

1.5 HR FRR FIRE SEPARATION 2 HR FRR FIRE SEPARATION

CODE ANALYSIS- 2ND FLOOR

09 _ **EXIT DISTANCE** RAMP DN@ 12% EV CHARGING STATION MECHANICAL ROOM 1273743.1 EV CHARGING STATION SOUTHWEST E.G 446.52'

2 CODE ANALYSIS- PARKING
3/32" = 1'-0"

NORTHWEST E.G 451.94'

303 -UNIT F-1 PATIO ONE BEDROOM UNIT 304 -UNIT A ONE BED ROOM UNIT EXIT DISTANCE 302 -UNIT E-1 305 -UNIT A-1 ONE BED ROOM ACCESSIBLE UNIT ONE BEDROOM UNIT A- TRAVEL DISTANCE: 7.88 m (25'-10") (MAX ALLOWABLE = 45M)306 UNIT A ONE BED ROOM UNIT 301 -UNIT F2 ONE BEDROOM UNIT PATIO FIRE SEPARATION LEGEND 0 HR FRR FIRE SEPARATION 3/4 HR FRR FIRE SEPARATION 1 HR FRR FIRE SEPARATION

4 CODE ANALYSIS- 3RD FLOOR
3/32" = 1'-0"

MA ARCHITECTS LTD.

2025 Willingdon Avenue #900, Burnaby, BC. V5C 0J3 T: 604.780.6461 604.780.3243 WWW.M-AARCHITECTS.COM WWW.MAARCHITECTSLTD.COM

2023/01/27 ISSUED FOR LEGAL DOC. 2023/01/23 ISSUED FOR CONSULTANT 2023/01/19 ISSUED FOR CLIENT REVIEW 2023/01/10 ISSUED FOR CLIENT REVIEW 2022/12/09 ISSUED FOR CONSULT. USES NO. DATE Y/M/D DESCRIPTION ISSUES AND REVISIONS

SEAL

FIRE SEPARATION LEGEND

0 HR FRR FIRE SEPARATION

3/4 HR FRR FIRE SEPARATION

1 HR FRR FIRE SEPARATION

1.5 HR FRR FIRE SEPARATION

2 HR FRR FIRE SEPARATION

1.5 HR FRR FIRE SEPARATION

2 HR FRR FIRE SEPARATION

COPYRIGHT NOTICE:

All rights reserved. All ideas, designs, drawings and reproductions either in print or electronic format, are the property of MA ARCHITECTS Ltd., and are an instrument of service that may not be used, forwarded to others, transmitted, downloaded or reproduced either in print or electronic format, without the express written permission of the copyright owner.

Written dimensions shall have precedence over scaled dimensions. Contractors shall verify and be responsible for all dimensions and conditions on the job; shall request clarification of errors, discrepancies, or doubtful information contained in contract drawings and documents. Failure to obtain such clarification renders the Contractor responsible for any resulting improper work and the cost of rectification.

PROJECT NAME

LONSDALE RESIDENTAL **APARTMENT**

PROJECT ADDRESS

2612 LONSDALE AVE, NORTH VANCOUVER


DRAWING TITLE

BC CODE ANALYSIS-PLANS A

SCALE As indicated AP DRAWN CHECKED Checker PROJECT NO. 22042


DRAWING NO. A00.24

THIS DRAWING IS PROPERTY OF MA ARCHITECTS LTD. AND SHOULD NOT BE COPIED OR DISTRIBUTED WITHOUT PRIOR WRITTEN CONSENT.

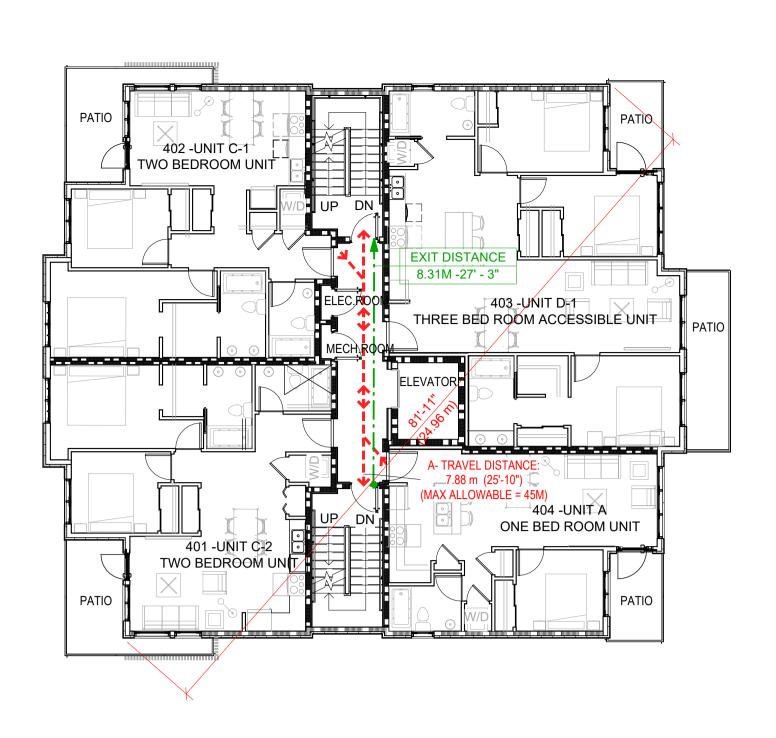

FIRE SEPARATION LEGEND 0 HR FRR FIRE SEPARATION 3/4 HR FRR FIRE SEPARATION 1 HR FRR FIRE SEPARATION 1.5 HR FRR FIRE SEPARATION 2 HR FRR FIRE SEPARATION

1 CODE ANALYSIS- 4TH FLOOR 3/32" = 1'-0"

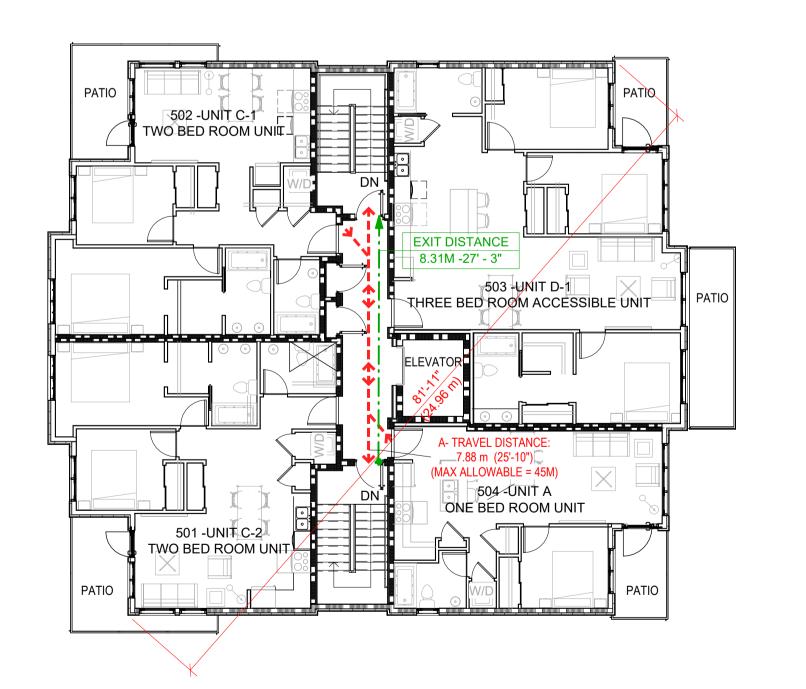

FIRE SEPARA	TION LEGEND
	0 HR FRR FIRE SEPARATION
	3/4 HR FRR FIRE SEPARATION
	1 HR FRR FIRE SEPARATION
	1.5 HR FRR FIRE SEPARATION
	2 HR FRR FIRE SEPARATION

CODE ANALYSIS- 5TH FLOOR 2 CODE A

(3.65 m) SETBACK (3.05 m)SETBACK BUILDING OUTLINE -UNDER GROUND LEVEL OUTLINE -- BUILDING OUTLINE UNDER GROUND LEVEL OUTLINE SETBACK — PROPOSED NEW PROPERTY LINE EXISTING PROPERTY LINE —— / # / / PROPOSED NEW PROPERTY LINE LIMITING DISTANCE > 9M LIMITING DISTANCE 7.3M /#// *PROPERTY LINE SETBACK ----UNDER GROUND LEVEL OUTLINE — BUILDING OUTLINE -PROPOSED NEW PROPERTY LINE 3 STOREY BUILDING # 2606 LONSDALE AVE. ROOF PEAK ELEV.= 146.25 FIRE SEPARATION LEGEND 0 HR FRR FIRE SEPARATION - PROPOSED 3/4 HR FRR FIRE SEPARATION FIRE HYDRANT 1 HR FRR FIRE SEPARATION 1.5 HR FRR FIRE SEPARATION 2 HR FRR FIRE SEPARATION CODE ANALYSIS- SITE PLAN
1/8" = 1'-0"

4 STOREY BUILDING

ROOF PEAK ELEV.= 150.70

PROPOSED NEW PROPERTY LINE

UNDER GROUND LEVEL OUTLINE -

BUILDING OUTLINE —

SETBACK —

105 27TH ST.

PROPERTY LINE

(3.05 m)

MA ARCHITECTS LTD. 2025 Willingdon Avenue #900, Burnaby, BC. V5C 0J3 T: 604.780.6461 604.780.3243 WWW.M-AARCHITECTS.COM WWW.MAARCHITECTSLTD.COM

2023/01/27 ISSUED FOR LEGAL DOC. 2023/01/23 ISSUED FOR CONSULTANT 2023/01/19 ISSUED FOR CLIENT REVIEW 2023/01/10 ISSUED FOR CLIENT REVIEW 2022/12/09 ISSUED FOR CONSULT. USES NO. DATE Y/M/D DESCRIPTION

ISSUES AND REVISIONS SEAL

COPYRIGHT NOTICE: All rights reserved. All ideas, designs, drawings and reproductions either in print or electronic format, are

the property of MA ARCHITECTS Ltd., and are an instrument of service that may not be used, forwarded to others, transmitted, downloaded or reproduced either in print or electronic format, without the express written permission of the copyright owner.

Written dimensions shall have precedence over scaled dimensions. Contractors shall verify and be responsible for all dimensions and conditions on the job; shall request clarification of errors, discrepancies, or doubtful information contained in contract drawings and documents. Failure to obtain such clarification renders the Contractor responsible for any resulting improper work and the cost of rectification.

PROJECT NAME

LONSDALE RESIDENTAL **APARTMENT**

PROJECT ADDRESS

2612 LONSDALE AVE, NORTH VANCOUVER

DRAWING TITLE

BC CODE ANALYSIS-PLANS B

SCALE As indicated AP DRAWN CHECKED Checker PROJECT NO. 22042

DRAWING NO. A00.25

THIS DRAWING IS PROPERTY OF MA ARCHITECTS LTD. AND SHOULD NOT BE COPIED OR DISTRIBUTED WITHOUT PRIOR WRITTEN CONSENT.

HYDRANT



OFFICE 2025 Willingdon Avenue #900, Burnaby, BC. V5C 0J3 OFFICE: +1 (778)-372-8650, +1 (778)-372-8651
CELL: +1 (604)-780-3243, +1 (604)-780-6461
EMAIL: INFO@M-AARCHITECTS.COM
WWW.M-AARCHITECTS.COM

5 2023/01/27 ISSUED FOR LEGAL DOC. 4 2023/01/23 ISSUED FOR CONSULTANT 2023/01/19 ISSUED FOR CLIENT REVIEW 2023/01/10 ISSUED FOR CLIENT REVIEW 2022/12/09 ISSUED FOR CONSULT. USES NO. DATE Y/M/D DESCRIPTION

ISSUES AND REVISIONS

SEAL

COPYRIGHT NOTICE:

All rights reserved. All ideas, designs, drawings and reproductions either in print or electronic format, are the property of MA ARCHITECTS Ltd., and are an instrument of service that may not be used, forwarded to others, transmitted, downloaded or reproduced either in print or electronic format, without the express written permission of the copyright owner.

Written dimensions shall have precedence over scaled dimensions. Contractors shall verify and be responsible for all dimensions and conditions on the job; shall request clarification of errors, discrepancies, or doubtful information contained in contract drawings and documents. Failure to obtain such clarification renders the Contractor responsible for any resulting improper work and the cost of rectification. This drawing shall not be used for construction purposes until it is issued for the purpose.

PROJECT NAME

LONSDALE RESIDENTAL **APARTMENT**

PROJECT ADDRESS

2612 LONSDALE AVE, NORTH VANCOUVER


DRAWING TITLE

SITE PLAN

	SCALE	1/8" = 1'-0"
	DRAWN	SH
	CHECKED	AP
	PROJECT NO.	22042



1 SITE PLAN
1/8" = 1'-0"

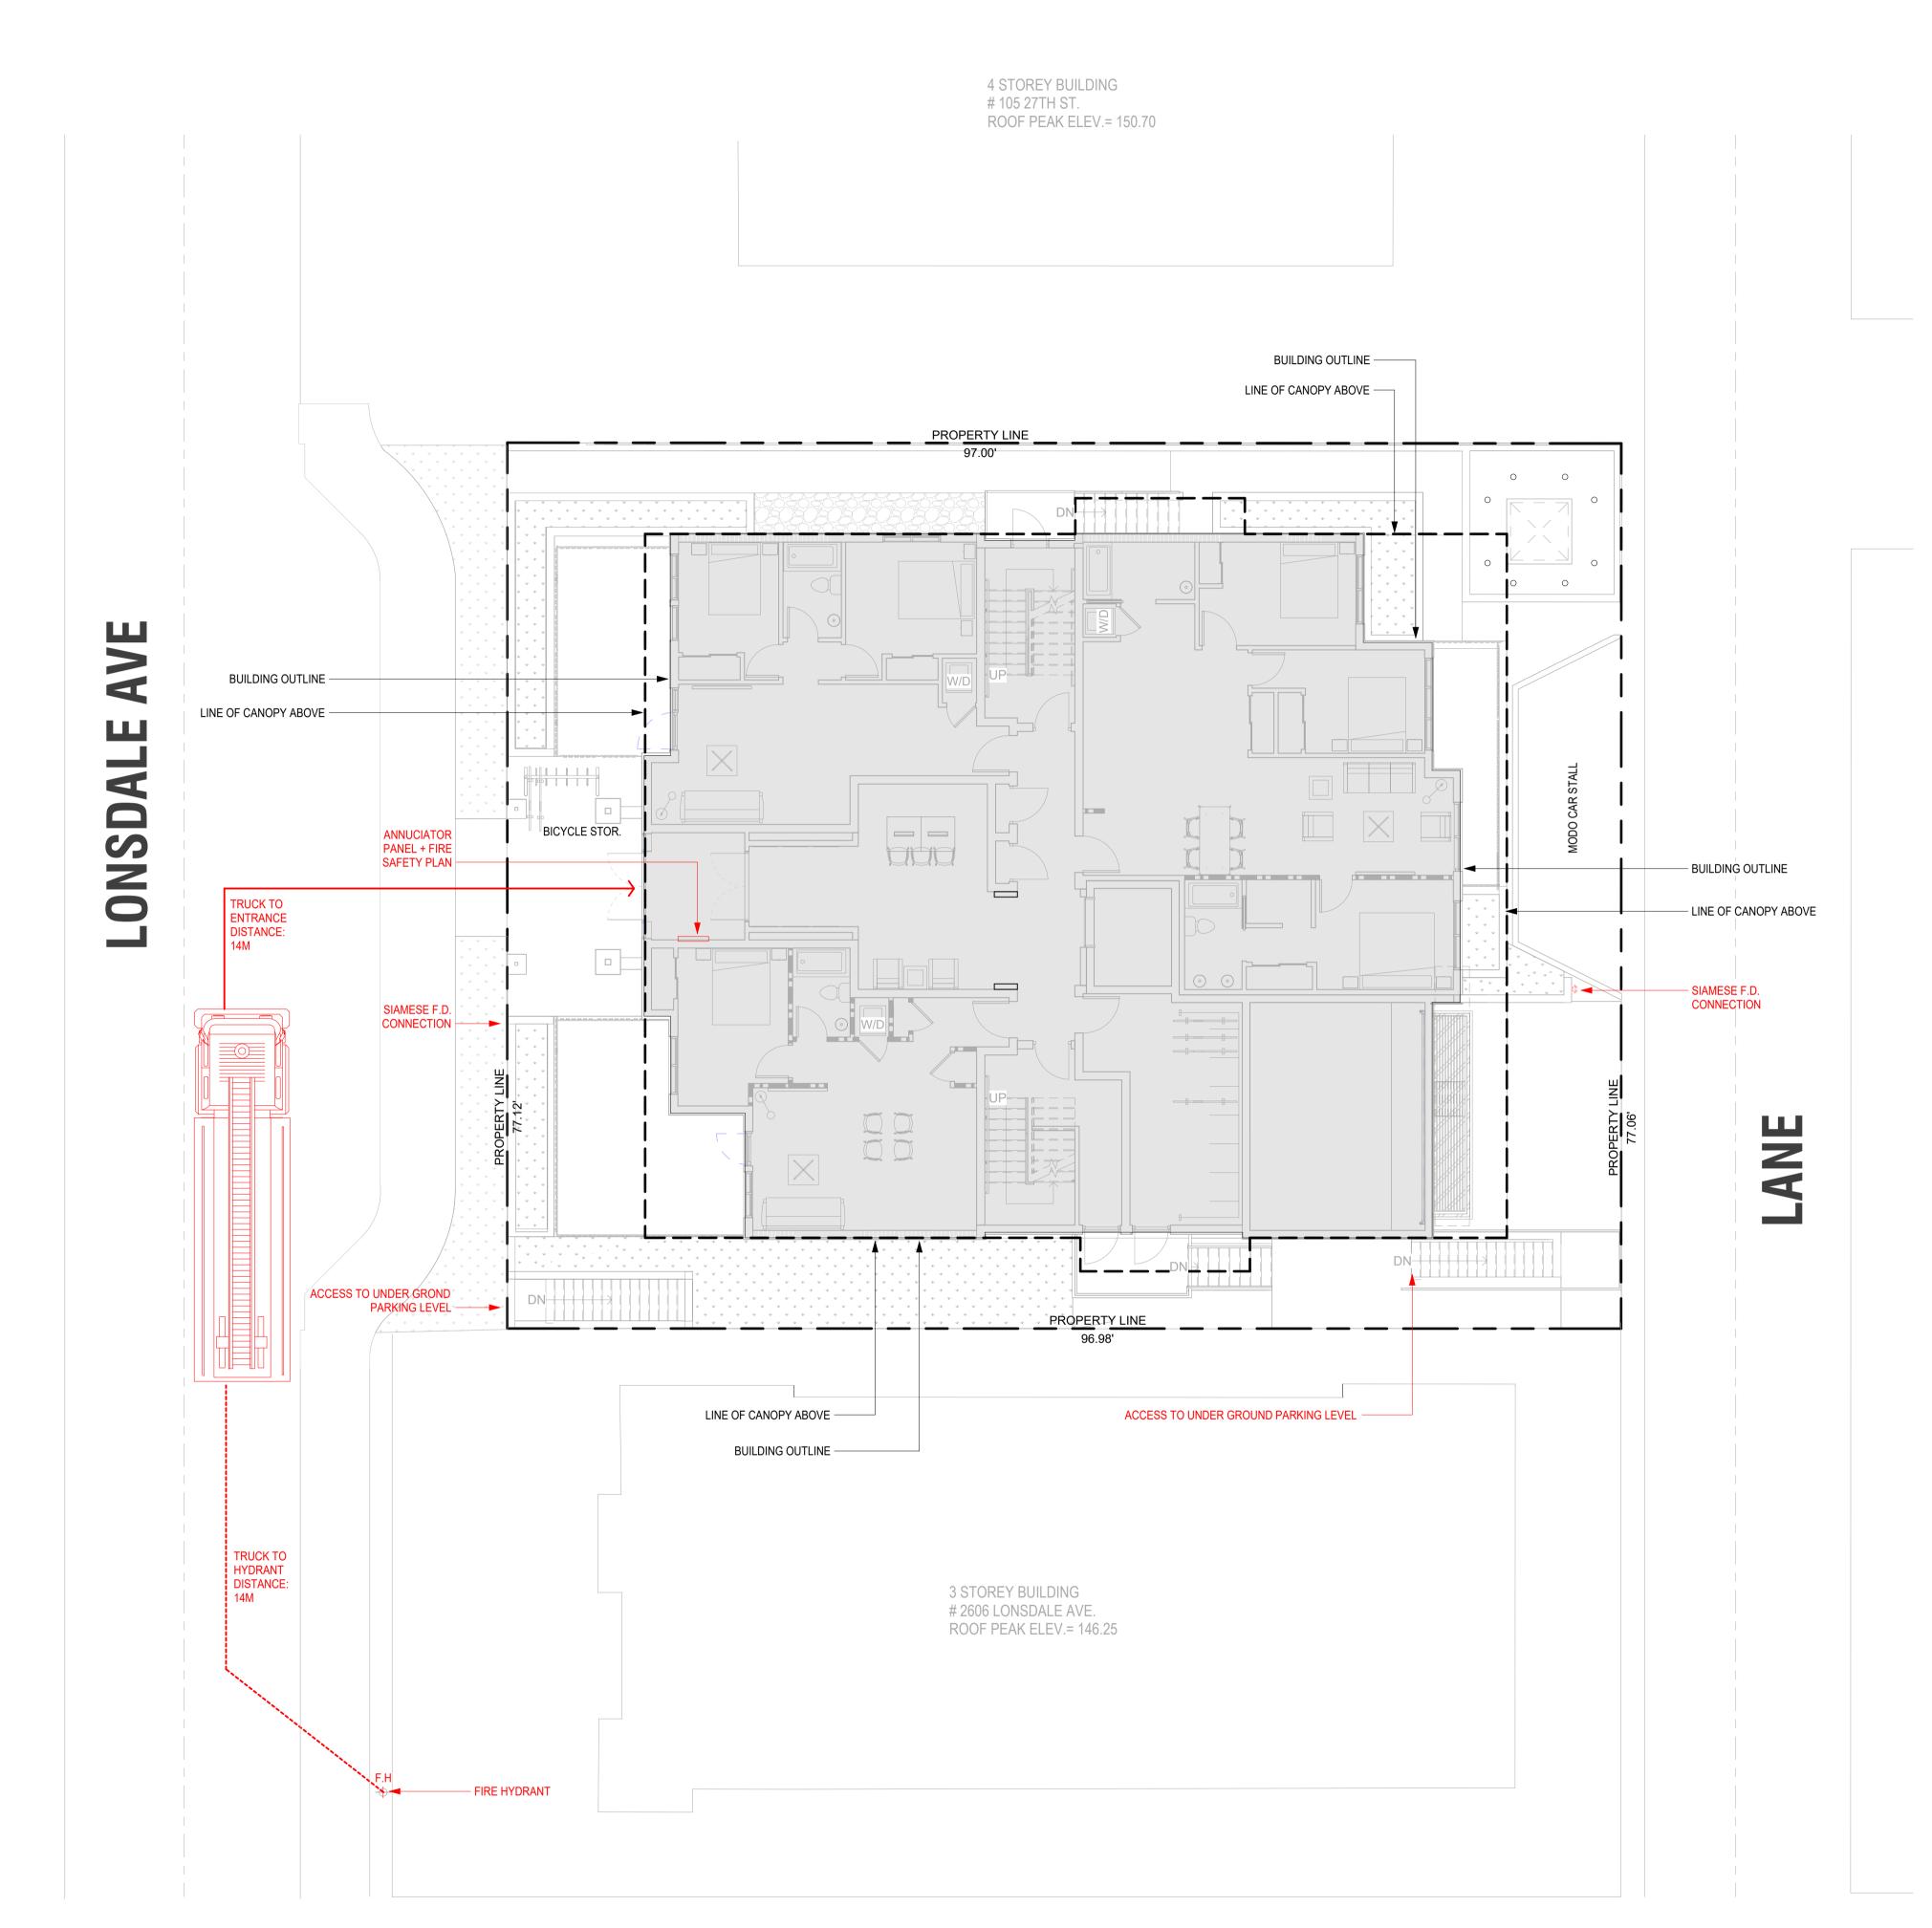


E26TH ST

1 CODE ANALYSIS- FIRE ACCESS PLAN
1/8" = 1'-0"



FIRE ACCESS LEGEND

1/4" = 1'-0"

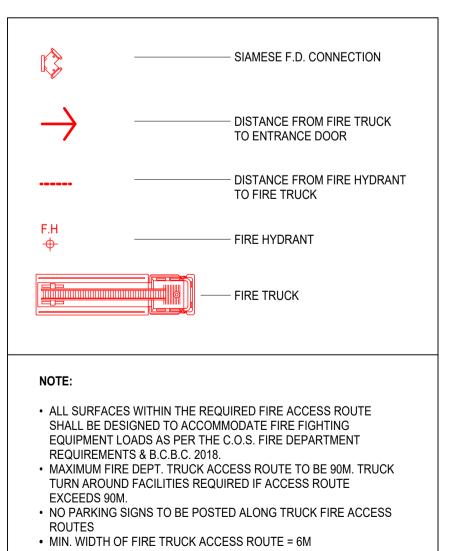

COPYRIGHT NOTICE:
All rights reserved. All ideas, designs, drawings and reproductions either in print or electronic format, are the property of MA ARCHITECTS Ltd., and are an instrument of service that may not be used, forwarded to others, transmitted, downloaded or reproduced either in print or electronic format, without the express written permission of the copyright owner.

5 2023/01/27 ISSUED FOR LEGAL DOC.

NO. DATE Y/M/D DESCRIPTION

ISSUES AND REVISIONS

4 2023/01/23 ISSUED FOR CONSULTANT
3 2023/01/19 ISSUED FOR CLIENT REVIEW
2 2023/01/10 ISSUED FOR CLIENT REVIEW
1 2022/12/09 ISSUED FOR CONSULT. USES

Written dimensions shall have precedence over scaled dimensions. Contractors shall verify and be responsible for all dimensions and conditions on the job; shall request clarification of errors, discrepancies, or doubtful information contained in contract drawings and documents. Failure to obtain such clarification renders the Contractor responsible for any resulting improper work and the cost of rectification. This drawing shall not be used for construction purposes until it is issued for the purpose.

PROJECT NAME

LONSDALE RESIDENTAL APARTMENT

PROJECT ADDRESS

2612 LONSDALE AVE, NORTH VANCOUVER


DRAWING TITLE

FIRE ACCESS PLAN

SCALE	As indicated
DRAWN	AT
CHECKED	AP
PROJECT NO.	22042

DRAWING NO.

A01.20

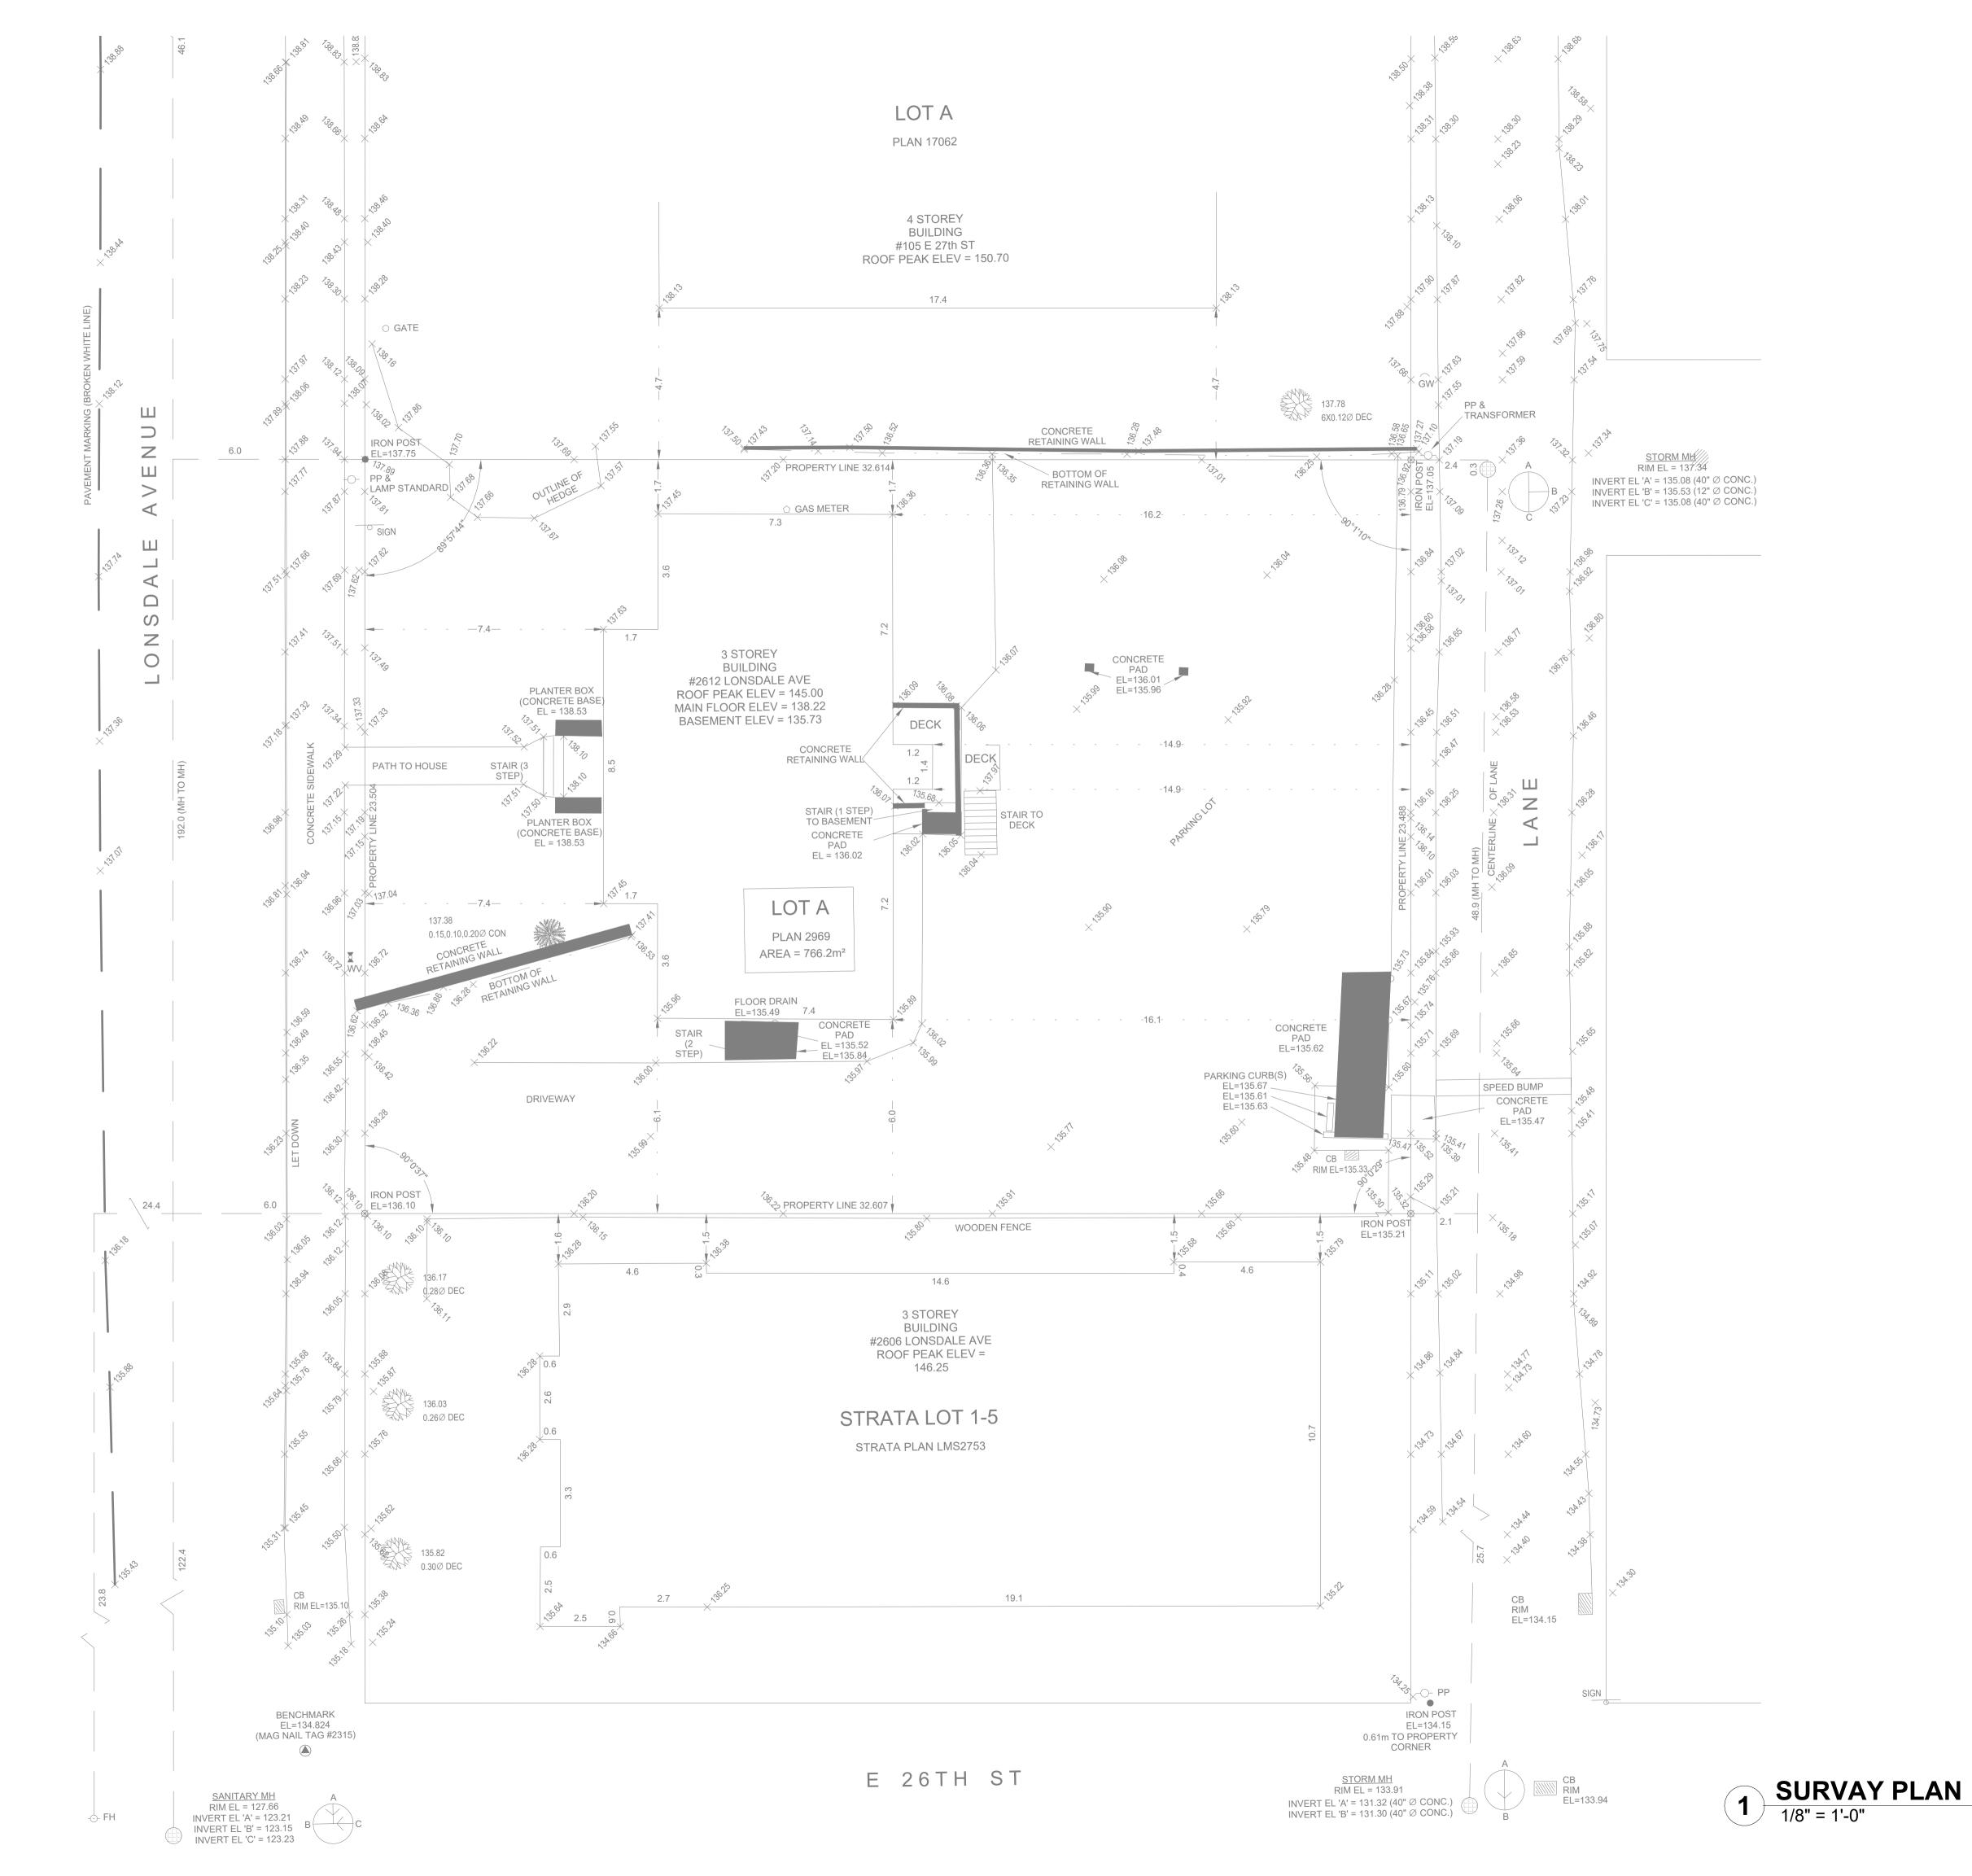



OFFICE
2025 Willingdon Avenue #900, Burnaby, BC. V5C 0J3
OFFICE: +1 (778)-372-8650, +1 (778)-372-8651
CELL: +1 (604)-780-3243, +1 (604)-780-6461
EMAIL: INFO@M-AARCHITECTS.COM
WWW.M-AARCHITECTS.COM

 5
 2023/01/27
 ISSUED FOR LEGAL DOC.

 4
 2023/01/23
 ISSUED FOR CONSULTANT

 3
 2023/01/19
 ISSUED FOR CLIENT REVIEW

 2
 2023/01/10
 ISSUED FOR CLIENT REVIEW

 1
 2022/12/09
 ISSUED FOR CONSULT. USES

NO. DATE Y/M/D DESCRIPTION

ISSUES AND REVISIONS
SEAL

COPYRIGHT NOTICE:
All rights reserved. All ideas, designs, drawings and reproductions either in print or electronic format, are the property of MA ARCHITECTS Ltd., and are an instrument of service that may not be used, forwarded to others, transmitted, downloaded or reproduced either in print or electronic format, without the express written

permission of the copyright owner.

Written dimensions shall have precedence over scaled dimensions. Contractors shall verify and be responsible for all dimensions and conditions on the job; shall request clarification of errors, discrepancies, or doubtful information contained in contract drawings and documents. Failure to obtain such clarification renders the Contractor responsible for any resulting improper work and the cost of rectification. This drawing shall not be used for construction purposes

until it is issued for the purpose.

PROJECT NAME

LONSDALE RESIDENTAL APARTMENT

PROJECT ADDRESS


2612 LONSDALE AVE, NORTH VANCOUVER

DRAWING TITLE

SURVAY PLAN

SCALE	1/8" = 1'-0"
DRAWN	SH
CHECKED	AP
PRO IECT NO	22042

WING NO.

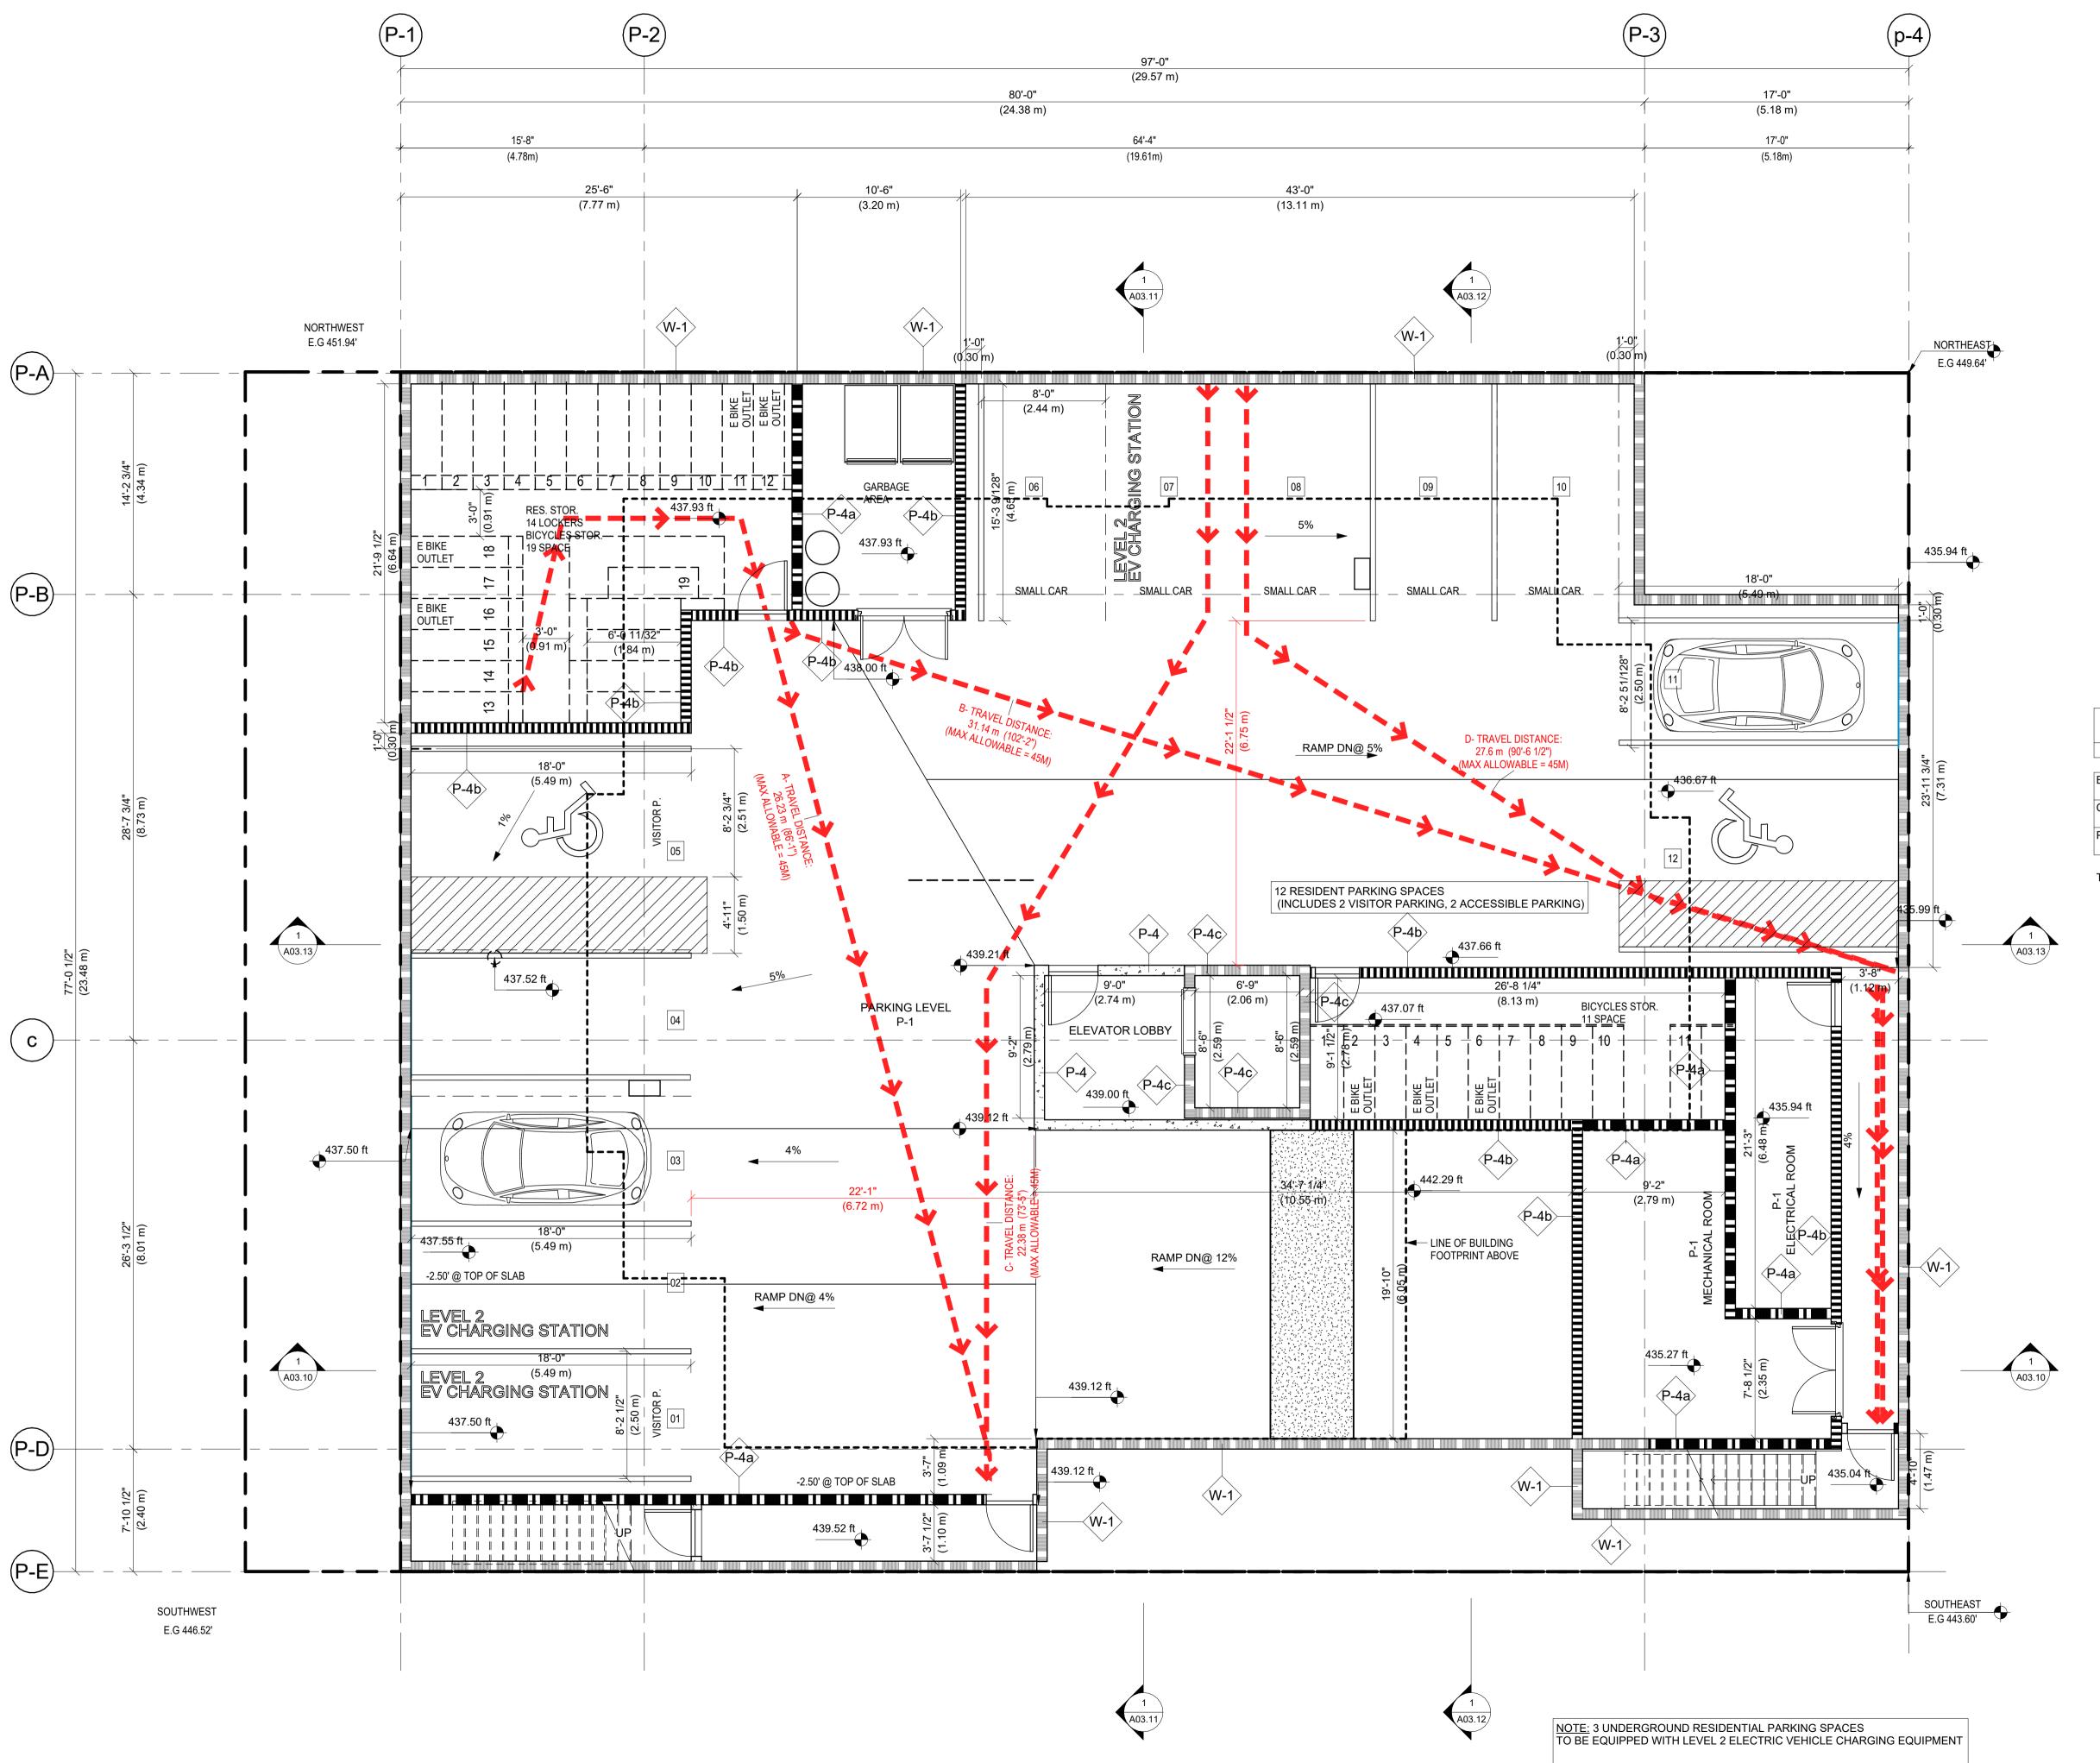



0 HR FRR FIRE SEPARATION

3/4 HR FRR FIRE SEPARATION

1 HR FRR FIRE SEPARATION

1.5 HR FRR FIRE SEPARATION

2 HR FRR FIRE SEPARATION

WALL CONSTRUCTION

ALL FIRE-RATED WALLS MUST BE CONSTRUCTED TO u/s STRUCTURE ABOVE.

ALL SOUND ATTENUATION WALLS TO BE CONSTRUCTED TO u/s STRUCTURE ABOVE.

ALL WALLS, NOT NOTED ABOVE, TO CONTINUE TO 150mm (6") ABOVE CEILING


WET WALLS

JANITOR ROOM, CHANGE ROOMS, LOCKER ROOMS AND WASHROOMS - REPLACE GYPSUM BOARD w/ GREEN BOARD at ALL WET WALLS.

EXIT INDICATION



PARKING LEVEL AREA						
NAME	AREA (SFT)	AREA (SM)	LEVEL			
BICYCLE STOR.	797 ft²	74.08 m ²	PARKING LEVEL L			
COMMON AREA	629 ft²	58.43 m²	PARKING LEVEL L			
PPARKING SPACE	5456 ft ²	506.87 m²	PARKING LEVEL L			
	6882 ft²	639.38 m²				
ΤΟΤΔΙ	6882 ft ²	639 38 m ²				

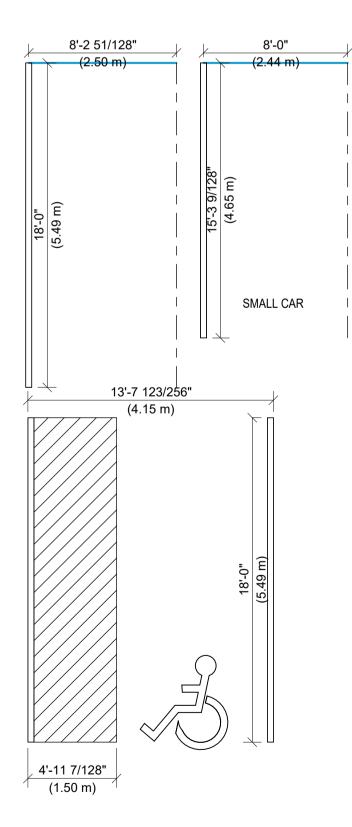

1 UNDER GROUND PARKING
3/16" = 1'-0"

MA ARCHITECTS LTD.

2025 Willingdon Avenue #900, Burnaby, BC. V5C 0J3

OFFICE: +1 (778)-372-8650, +1 (778)-372-8651 CELL: +1 (604)-780-3243, +1 (604)-780-6461

EMAIL: INFO@M-AARCHITECTS.COM
WWW.M-AARCHITECTS.COM

OFFICE

 2023/01/27
 ISSUED FOR LEGAL DOC.

 2023/01/23
 ISSUED FOR CONSULTANT

 2023/01/19
 ISSUED FOR CLIENT REVIEW

 2023/01/10
 ISSUED FOR CLIENT REVIEW

 2022/12/09
 ISSUED FOR CONSULT. USES

ISSUES AND REVISIONS

NO. DATE Y/M/D DESCRIPTION

SEAL

COPYRIGHT NOTICE:
All rights reserved. All ideas, designs, drawings and reproductions either in print or electronic format, are the property of MA ARCHITECTS Ltd., and are an instrument of service that may not be used, forwarded to others, transmitted, downloaded or reproduced either

in print or electronic format, without the express written permission of the copyright owner.

Written dimensions shall have precedence over scaled dimensions. Contractors shall verify and be responsible for all dimensions and conditions on the job; shall request clarification of errors, discrepancies, or doubtful information contained in contract drawings and documents. Failure to obtain such clarification renders the Contractor responsible for any resulting improper work and the cost of rectification. This drawing shall not be used for construction purposes

PROJECT NAME

until it is issued for the purpose.

LONSDALE RESIDENTAL APARTMENT


PROJECT ADDRESS

2612 LONSDALE AVE, NORTH VANCOUVER

DRAWING TITLE

PARKING PLAN

SCALE	As indicated
DRAWN	SH
CHECKED	AP
PROJECT NO.	22042

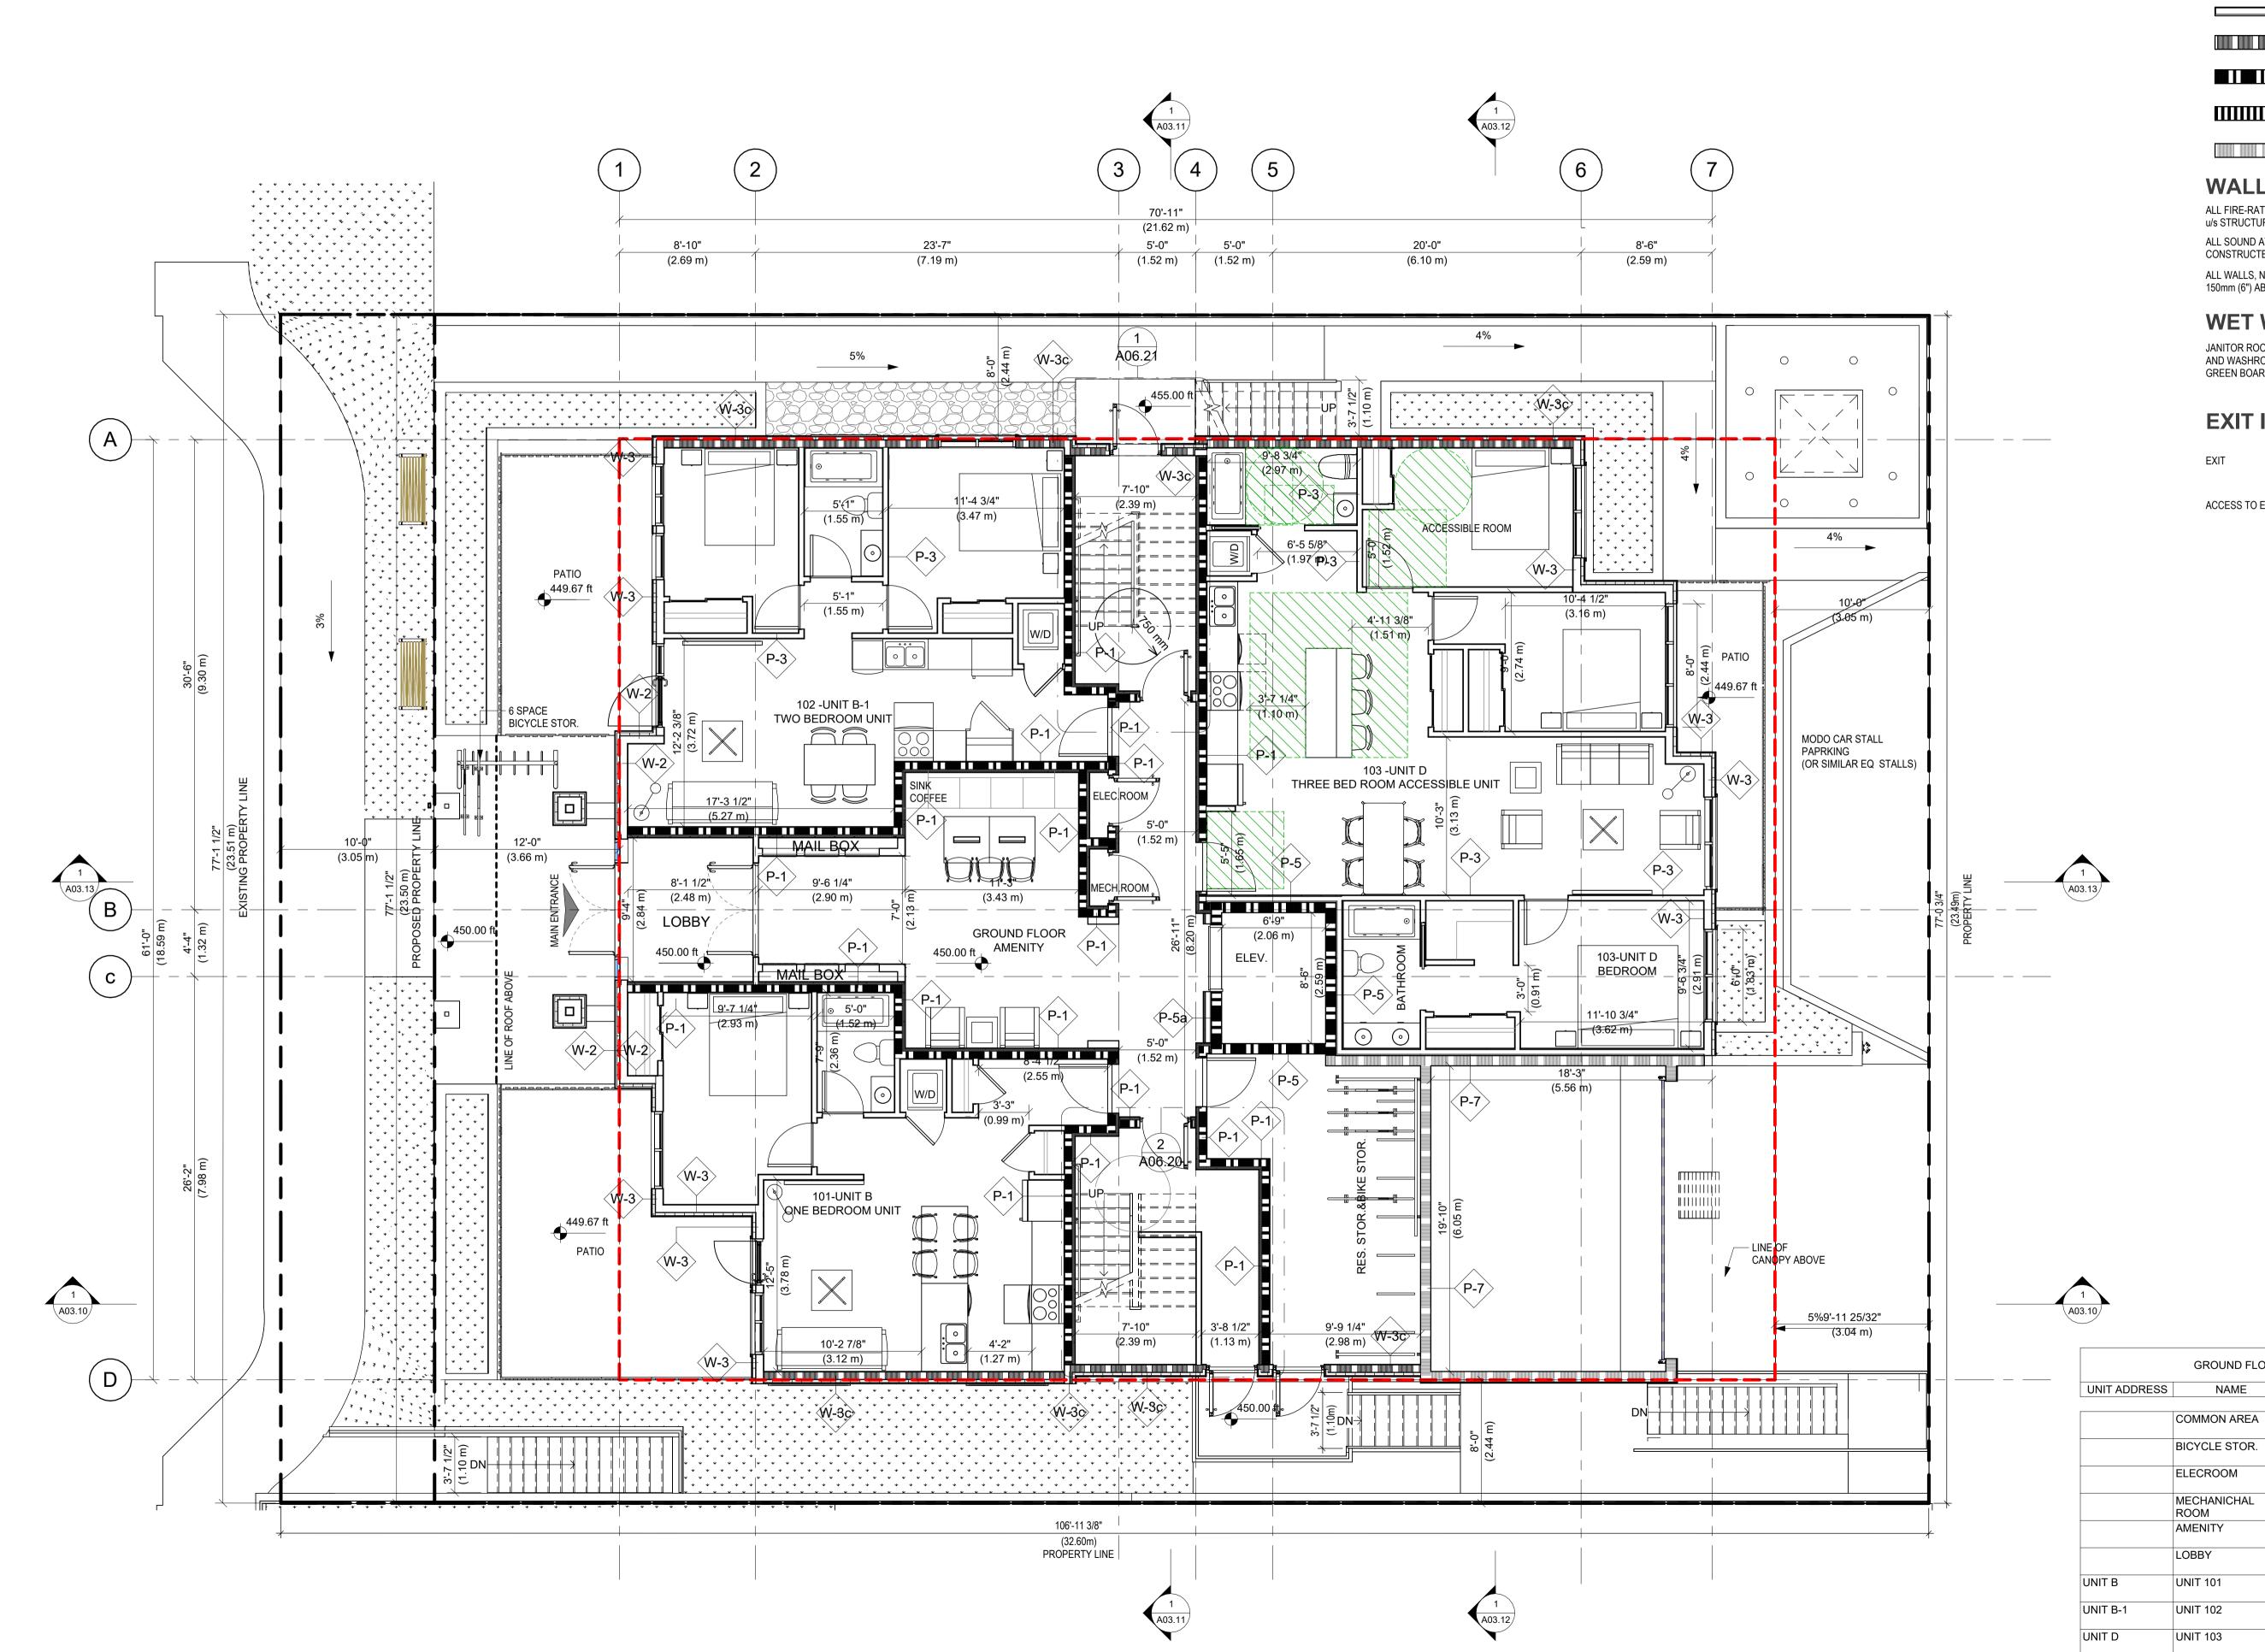



0 HR FRR FIRE SEPARATION

3/4 HR FRR FIRE SEPARATION

1 HR FRR FIRE SEPARATION

2 HR FRR FIRE SEPARATION

1.5 HR FRR FIRE SEPARATION

WALL CONSTRUCTION

ALL FIRE-RATED WALLS MUST BE CONSTRUCTED TO u/s STRUCTURE ABOVE.

ALL SOUND ATTENUATION WALLS TO BE CONSTRUCTED TO u/s STRUCTURE ABOVE.

ALL WALLS, NOT NOTED ABOVE, TO CONTINUE TO 150mm (6") ABOVE CEILING

WET WALLS

JANITOR ROOM, CHANGE ROOMS, LOCKER ROOMS AND WASHROOMS - REPLACE GYPSUM BOARD w/ GREEN BOARD at ALL WET WALLS.

EXIT INDICATION



ACCESS TO EXIT

2023/01/27 ISSUED FOR LEGAL DOC. 2023/01/23 ISSUED FOR CONSULTANT 2023/01/19 ISSUED FOR CLIENT REVIEW 2023/01/10 ISSUED FOR CLIENT REVIEW 2022/12/09 ISSUED FOR CONSULT. USES

MA ARCHITECTS LTD.

2025 Willingdon Avenue #900, Burnaby, BC. V5C 0J3

OFFICE: +1 (778)-372-8650, +1 (778)-372-8651 CELL: +1 (604)-780-3243, +1 (604)-780-6461

EMAIL: INFO@M-AARCHITECTS.COM
WWW.M-AARCHITECTS.COM

ISSUES AND REVISIONS

NO. DATE Y/M/D DESCRIPTION

SEAL

COPYRIGHT NOTICE: All rights reserved. All ideas, designs, drawings and reproductions either in print or electronic format, are the property of MA ARCHITECTS Ltd., and are an instrument of service that may not be used, forwarded to others, transmitted, downloaded or reproduced either in print or electronic format, without the express written permission of the copyright owner.

Written dimensions shall have precedence over scaled dimensions. Contractors shall verify and be responsible for all dimensions and conditions on the job; shall request clarification of errors, discrepancies, or doubtful information contained in contract drawings and documents. Failure to obtain such clarification renders the Contractor responsible for any resulting improper work and the cost of rectification. This drawing shall not be used for construction purposes until it is issued for the purpose.

PROJECT NAME

LONSDALE RESIDENTAL **APARTMENT**

PROJECT ADDRESS

2612 LONSDALE AVE, NORTH VANCOUVER

DRAWING TITLE

GROUND FLOOR PLAN

SCALE As indicated SH DRAWN CHECKED PROJECT NO.

A02.13



TOTAL AREA

GROUND FLOOR AREA CALCULATION

256 ft²

3660 ft²

AREA (SFT) AREA (SM) LEVEL

54.6 m²

23.82 m²

1.11 m²

1.01 m²

29.44 m²

8.39 m²

55.18 m²

340.02 m²

GROUND

FLOOR

GROUND

GROUND

FLOOR

FLOOR

GROUND

FLOOR

GROUND **FLOOR**


GROUND **FLOOR**

GROUND FLOOR

FLOOR

104.69 m² GROUND

GROUND

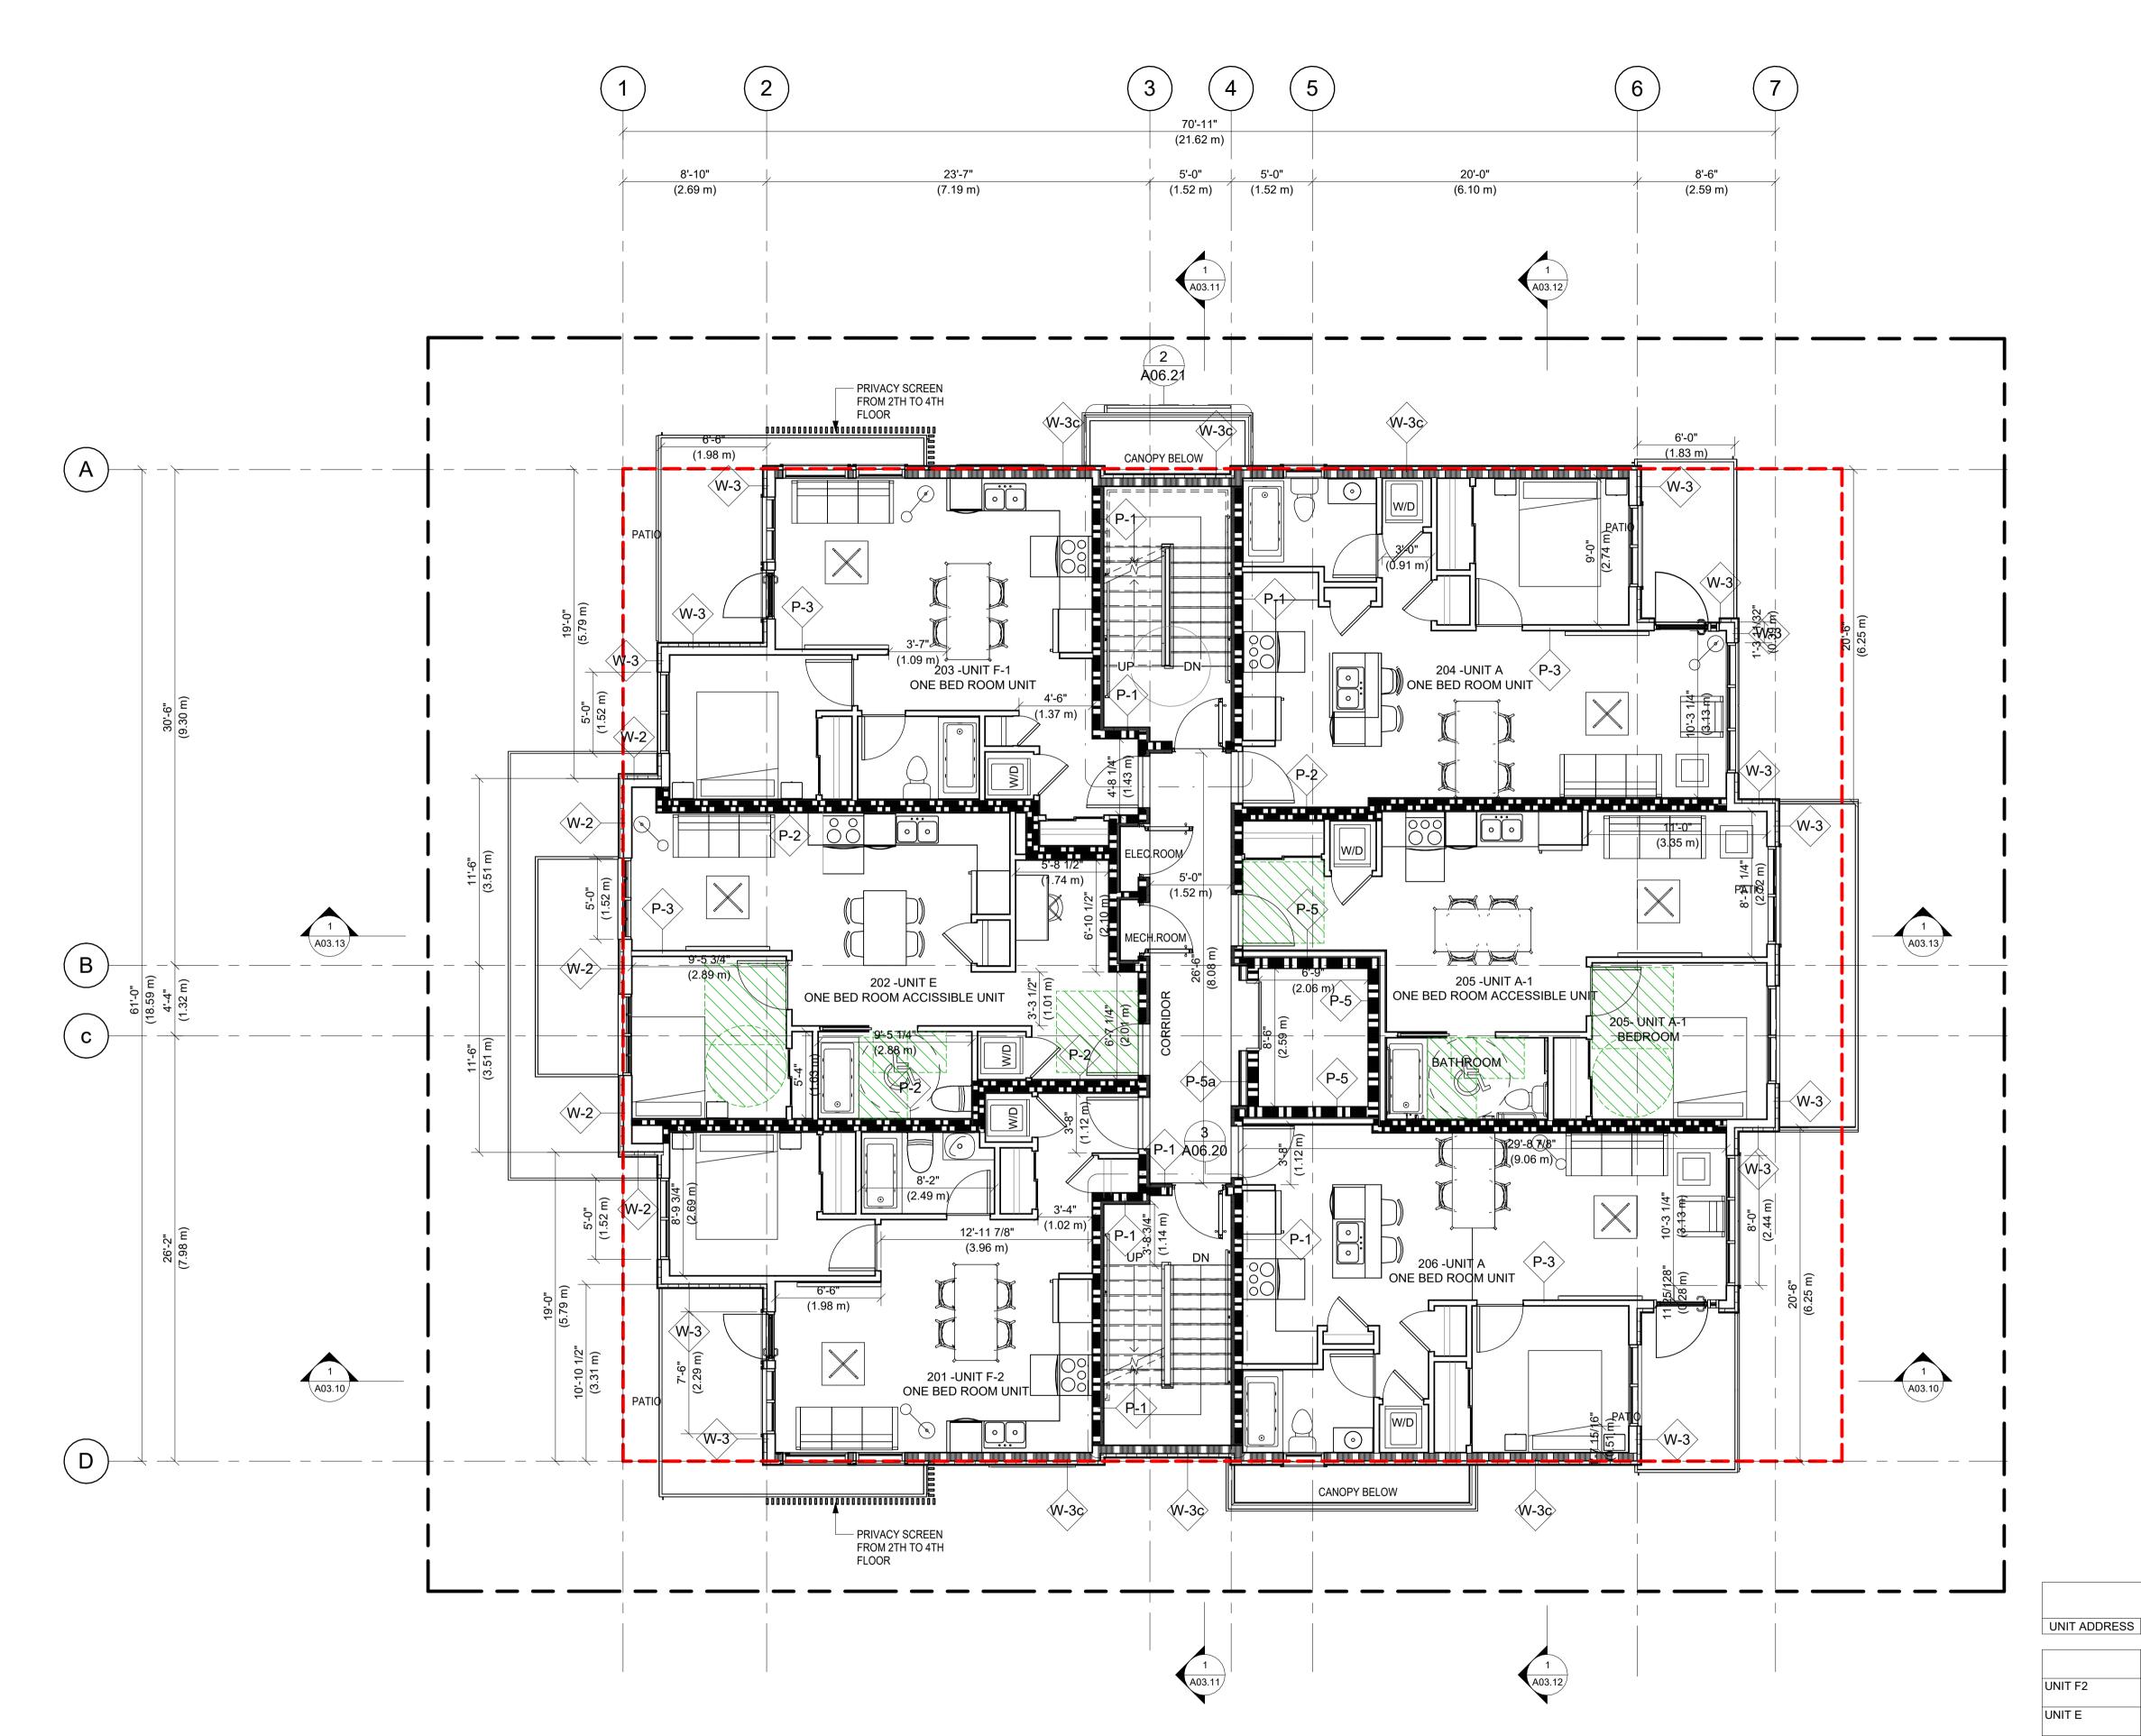



0 HR FRR FIRE SEPARATION

3/4 HR FRR FIRE SEPARATION

1.5 HR FRR FIRE SEPARATION

2 HR FRR FIRE SEPARATION

1 HR FRR FIRE SEPARATION

WALL CONSTRUCTION

ALL FIRE-RATED WALLS MUST BE CONSTRUCTED TO u/s STRUCTURE ABOVE.
ALL SOUND ATTENUATION WALLS TO BE

CONSTRUCTED TO u/s STRUCTURE ABOVE.

ALL WALLS, NOT NOTED ABOVE, TO CONTINUE TO

ALL WALLS, NOT NOTED ABOVE, TO CON' 150mm (6") ABOVE CEILING

WET WALLS

JANITOR ROOM, CHANGE ROOMS, LOCKER ROOMS AND WASHROOMS - REPLACE GYPSUM BOARD w/ GREEN BOARD at ALL WET WALLS.

EXIT INDICATION

ACCESS TO EXIT

 2ND FLOOR AREA CALCULATION

 ESS
 NAME
 AREA (SFT)
 AREA (SM)
 LEVEL

 COMMON AREA
 515 ft²
 47.81 m²
 2ND FLOOR PLAN

 UNIT 201
 526 ft²
 48.87 m²
 2ND FLOOR PLAN

 UNIT 202
 580 ft²
 53.93 m²
 2ND FLOOR PLAN

 UNIT 203
 517 ft²
 48.05 m²
 2ND FLOOR PLAN

 UNIT A-1
 UNIT 205
 564 ft²
 52.43 m²
 2ND FLOOR PLAN

 UNIT A
 UNIT 206
 1168 ft²
 108.53 m²
 2ND FLOOR PLAN

 TOTAL AREA
 3871 ft²
 359.62 m²

UNIT F-1

1 2ND FLOOR PLAN
3/16" = 1'-0"



OFFICE: +1 (778)-372-8650, +1 (778)-372-8651 CELL: +1 (604)-780-3243, +1 (604)-780-6461

EMAIL: INFO@M-AARCHITECTS.COM
WWW.M-AARCHITECTS.COM

2 2023/01/10 ISSUED FOR CLIENT REVIEW
1 2022/12/09 ISSUED FOR CONSULT. USES
NO. DATE Y/M/D DESCRIPTION
ISSUES AND REVISIONS
SEAL

2023/01/27 ISSUED FOR LEGAL DOC.

4 2023/01/23 ISSUED FOR CONSULTANT 3 2023/01/19 ISSUED FOR CLIENT REVIEW

COPYRIGHT NOTICE:
All rights reserved. All ideas, designs, drawings and reproductions either in print or electronic format, are the property of MA ARCHITECTS Ltd., and are an instrument of service that may not be used, forwarded to others, transmitted, downloaded or reproduced either in print or electronic format, without the express written permission of the copyright owner.

Written dimensions shall have precedence over scaled dimensions. Contractors shall verify and be responsible for all dimensions and conditions on the job; shall request clarification of errors, discrepancies, or doubtful information contained in contract drawings and documents. Failure to obtain such clarification renders the Contractor responsible for any resulting improper work and the cost of rectification. This drawing shall not be used for construction purposes until it is issued for the purpose.

PROJECT NAME

LONSDALE RESIDENTAL APARTMENT

PROJECT ADDRESS

2612 LONSDALE AVE, NORTH VANCOUVER

DRAWING TITLE


SECOND FLOOR PLAN

DRAWN SH

CHECKED AP

PROJECT NO. 22042

DRAWING NO.

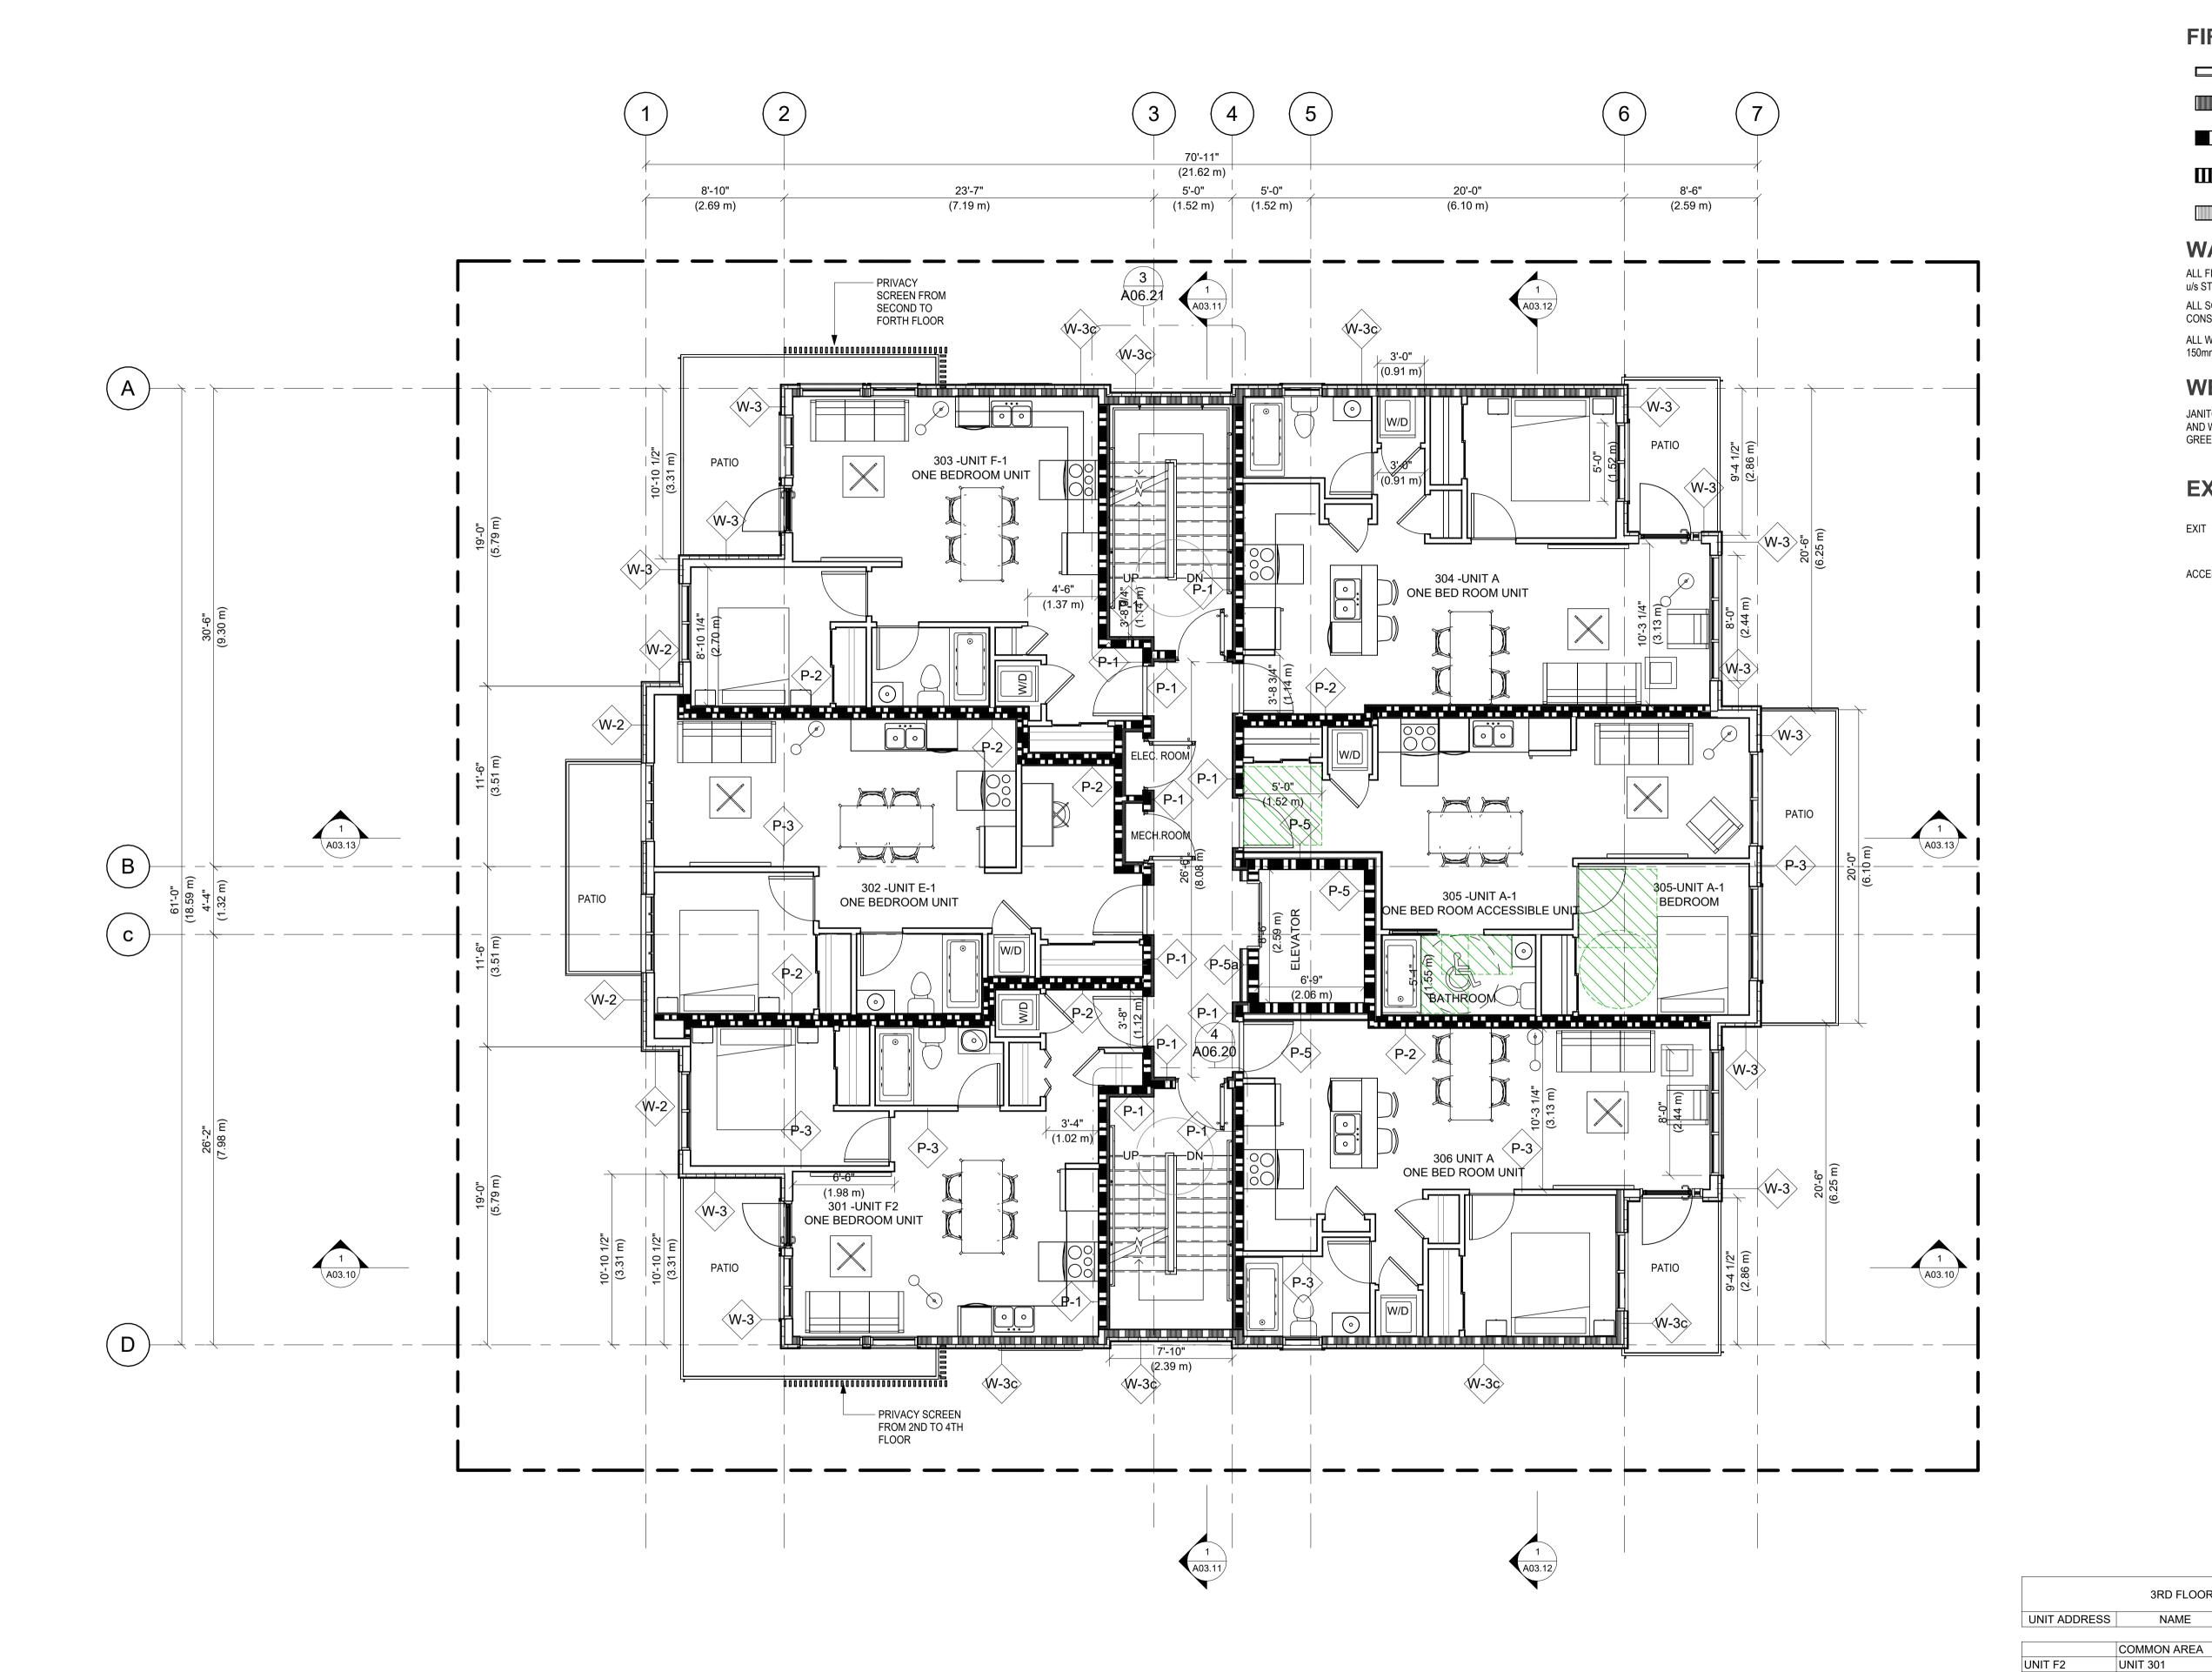

FIRE SEPARATION LEGEND

0 HR FRR FIRE SEPARATION

1 HR FRR FIRE SEPARATION

3/4 HR FRR FIRE SEPARATION

1.5 HR FRR FIRE SEPARATION

2 HR FRR FIRE SEPARATION

WALL CONSTRUCTION

ALL FIRE-RATED WALLS MUST BE CONSTRUCTED TO u/s STRUCTURE ABOVE. ALL SOUND ATTENUATION WALLS TO BE

ALL WALLS, NOT NOTED ABOVE, TO CONTINUE TO 150mm (6") ABOVE CEILING

CONSTRUCTED TO u/s STRUCTURE ABOVE.

WET WALLS

JANITOR ROOM, CHANGE ROOMS, LOCKER ROOMS AND WASHROOMS - REPLACE GYPSUM BOARD w/ GREEN BOARD at ALL WET WALLS.

EXIT INDICATION

EXIT



ACCESS TO EXIT



2023/01/27 ISSUED FOR LEGAL DOC. 2023/01/23 ISSUED FOR CONSULTANT 2023/01/19 ISSUED FOR CLIENT REVIEW 2023/01/10 ISSUED FOR CLIENT REVIEW 2022/12/09 ISSUED FOR CONSULT. USES

MA ARCHITECTS LTD.

2025 Willingdon Avenue #900, Burnaby, BC. V5C 0J3 OFFICE: +1 (778)-372-8650, +1 (778)-372-8651 CELL: +1 (604)-780-3243, +1 (604)-780-6461

EMAIL: INFO@M-AARCHITECTS.COM
WWW.M-AARCHITECTS.COM

ISSUES AND REVISIONS

NO. DATE Y/M/D DESCRIPTION

SEAL

COPYRIGHT NOTICE: All rights reserved. All ideas, designs, drawings and reproductions either in print or electronic format, are the property of MA ARCHITECTS Ltd., and are an instrument of service that may not be used, forwarded to others, transmitted, downloaded or reproduced either in print or electronic format, without the express written

permission of the copyright owner. Written dimensions shall have precedence over scaled dimensions. Contractors shall verify and be responsible for all dimensions and conditions on the job; shall request clarification of errors, discrepancies, or doubtful information contained in contract drawings and documents. Failure to obtain such clarification renders the Contractor responsible for any resulting improper work and the cost of rectification. This drawing shall not be used for construction purposes until it is issued for the purpose.

PROJECT NAME

LONSDALE RESIDENTAL **APARTMENT**

PROJECT ADDRESS

2612 LONSDALE AVE, NORTH VANCOUVER

DRAWING TITLE

THIRD FLOOR PLAN

SCALE	As indicated
DRAWN	SH
CHECKED	AP
PROJECT NO.	22042



AREA (SFT) AREA (SM) LEVEL

359.58 m²

47.83 m² 3RD FLOOR 48.87 m² 3RD FLOOR

53.93 m² 3RD FLOOR

48.05 m² 3RD FLOOR 54.23 m² 3RD FLOOR

52.41 m² 3RD FLOOR

54.26 m² 3RD FLOOR

3RD FLOOR AREA CALCULATION

515 ft²

526 ft²

517 ft²

584 ft²

3870 ft²

UNIT 302

UNIT 303

UNIT 304

UNIT 305

UNIT 306

UNIT F-1

UNIT A-1

UNIT A

TOTAL AREA

UNIT A



THIS DRAWING IS PROPERTY OF MA ARCHITECTS LTD. AND SHOULD NOT BE COPIED OR DISTRIBUTED
WITHOUT PRIOR WRITTEN CONSENT.

EMAIL: INFO@M-AARCHITECTS.COM WWW.M-AARCHITECTS.COM



FIRE SEPARATION LEGEND

0 HR FRR FIRE SEPARATION

1 HR FRR FIRE SEPARATION

1.5 HR FRR FIRE SEPARATION

3/4 HR FRR FIRE SEPARATION

2 HR FRR FIRE SEPARATION

WALL CONSTRUCTION

ALL FIRE-RATED WALLS MUST BE CONSTRUCTED TO u/s STRUCTURE ABOVE. ALL SOUND ATTENUATION WALLS TO BE

CONSTRUCTED TO u/s STRUCTURE ABOVE. ALL WALLS, NOT NOTED ABOVE, TO CONTINUE TO 150mm (6") ABOVE CEILING

WET WALLS

JANITOR ROOM, CHANGE ROOMS, LOCKER ROOMS AND WASHROOMS - REPLACE GYPSUM BOARD w/ GREEN BOARD at ALL WET WALLS.

EXIT INDICATION

ACCESS TO EXIT



2023/01/27 ISSUED FOR LEGAL DOC. 2023/01/23 ISSUED FOR CONSULTANT 2023/01/19 ISSUED FOR CLIENT REVIEW 2023/01/10 ISSUED FOR CLIENT REVIEW

NO. DATE Y/M/D DESCRIPTION

2022/12/09 ISSUED FOR CONSULT. USES

ISSUES AND REVISIONS

SEAL

COPYRIGHT NOTICE:

All rights reserved. All ideas, designs, drawings and reproductions either in print or electronic format, are the property of MA ARCHITECTS Ltd., and are an instrument of service that may not be used, forwarded to others, transmitted, downloaded or reproduced either in print or electronic format, without the express written

Written dimensions shall have precedence over scaled dimensions. Contractors shall verify and be responsible for all dimensions and conditions on the job; shall request clarification of errors, discrepancies, or doubtful information contained in contract drawings and documents. Failure to obtain such clarification renders the Contractor responsible for any resulting improper work and the cost of rectification. This drawing shall not be used for construction purposes until it is issued for the purpose.

PROJECT NAME

LONSDALE RESIDENTAL **APARTMENT**

permission of the copyright owner.

PROJECT ADDRESS

2612 LONSDALE AVE, NORTH VANCOUVER

DRAWING TITLE

FORTH FLOOR PLAN

SCALE	As indicated
DRAWN	SH
CHECKED	AP
PROJECT NO.	22042





4TH FLOOR AREA CALCULATION

803 ft²

1144 ft²

3867 ft²

COMMON AREA

UNIT 401

UNIT 402

UNIT 403

UNIT 404

UNIT A

TOTAL AREA

AREA (SFT) AREA (SM) LEVEL

359.23 m²

47.81 m² 4TH FLOOR

76.23 m² 4TH FLOOR

74.64 m² 4TH FLOOR

106.3 m² 4TH FLOOR

54.26 m² 4TH FLOOR

EMAIL: INFO@M-AARCHITECTS.COM WWW.M-AARCHITECTS.COM



FIRE SEPARATION LEGEND

3/4 HR FRR FIRE SEPARATION

0 HR FRR FIRE SEPARATION

2 HR FRR FIRE SEPARATION

1 HR FRR FIRE SEPARATION

1.5 HR FRR FIRE SEPARATION

WALL CONSTRUCTION

ALL FIRE-RATED WALLS MUST BE CONSTRUCTED TO u/s STRUCTURE ABOVE.

ALL SOUND ATTENUATION WALLS TO BE CONSTRUCTED TO u/s STRUCTURE ABOVE.

ALL WALLS, NOT NOTED ABOVE, TO CONTINUE TO 150mm (6") ABOVE CEILING

WET WALLS

JANITOR ROOM, CHANGE ROOMS, LOCKER ROOMS AND WASHROOMS - REPLACE GYPSUM BOARD w/ GREEN BOARD at ALL WET WALLS.

EXIT INDICATION



ACCESS TO EXIT

5 2023/01/27 ISSUED FOR LEGAL DOC. 4 2023/01/23 ISSUED FOR CONSULTANT 3 2023/01/19 ISSUED FOR CLIENT REVIEW 2 2023/01/10 ISSUED FOR CLIENT REVIEW 1 2022/12/09 ISSUED FOR CONSULT. USES

ISSUES AND REVISIONS

NO. DATE Y/M/D DESCRIPTION

SEAL

COPYRIGHT NOTICE:
All rights reserved. All ideas, designs, drawings and reproductions either in print or electronic format, are the property of MA ARCHITECTS Ltd., and are an instrument of service that may not be used, forwarded to others, transmitted, downloaded or reproduced either in print or electronic format, without the express written

permission of the copyright owner.

Written dimensions shall have precedence over scaled dimensions. Contractors shall verify and be responsible for all dimensions and conditions on the job; shall request clarification of errors, discrepancies, or doubtful information contained in contract drawings and documents. Failure to obtain such clarification renders the Contractor responsible for any resulting improper work and the cost of rectification. This drawing shall not be used for construction purposes until it is issued for the purpose.

PROJECT NAME

LONSDALE RESIDENTAL APARTMENT

PROJECT ADDRESS

2612 LONSDALE AVE, NORTH VANCOUVER

DRAWING TITLE


FIFTH FLOOR PLAN

SCALE As indicated

DRAWN SH

CHECKED AP

PROJECT NO. 22042

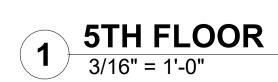

COMMON AREA

UNIT 501

UNIT 502

UNIT 503

UNIT 504

UNIT D-1

UNIT A

TOTAL AREA

5TH FLOOR AREA CALCULATION

1145 ft²

3866 ft² 359.19 m²

AREA (SFT) AREA (SM) LEVEL


47.83 m² 5TH FLOOR


76.18 m² 5TH FLOOR

74.59 m² 5TH FLOOR

106.33 m² 5TH FLOOR

54.27 m² 5TH FLOOR

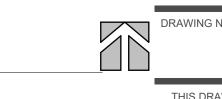

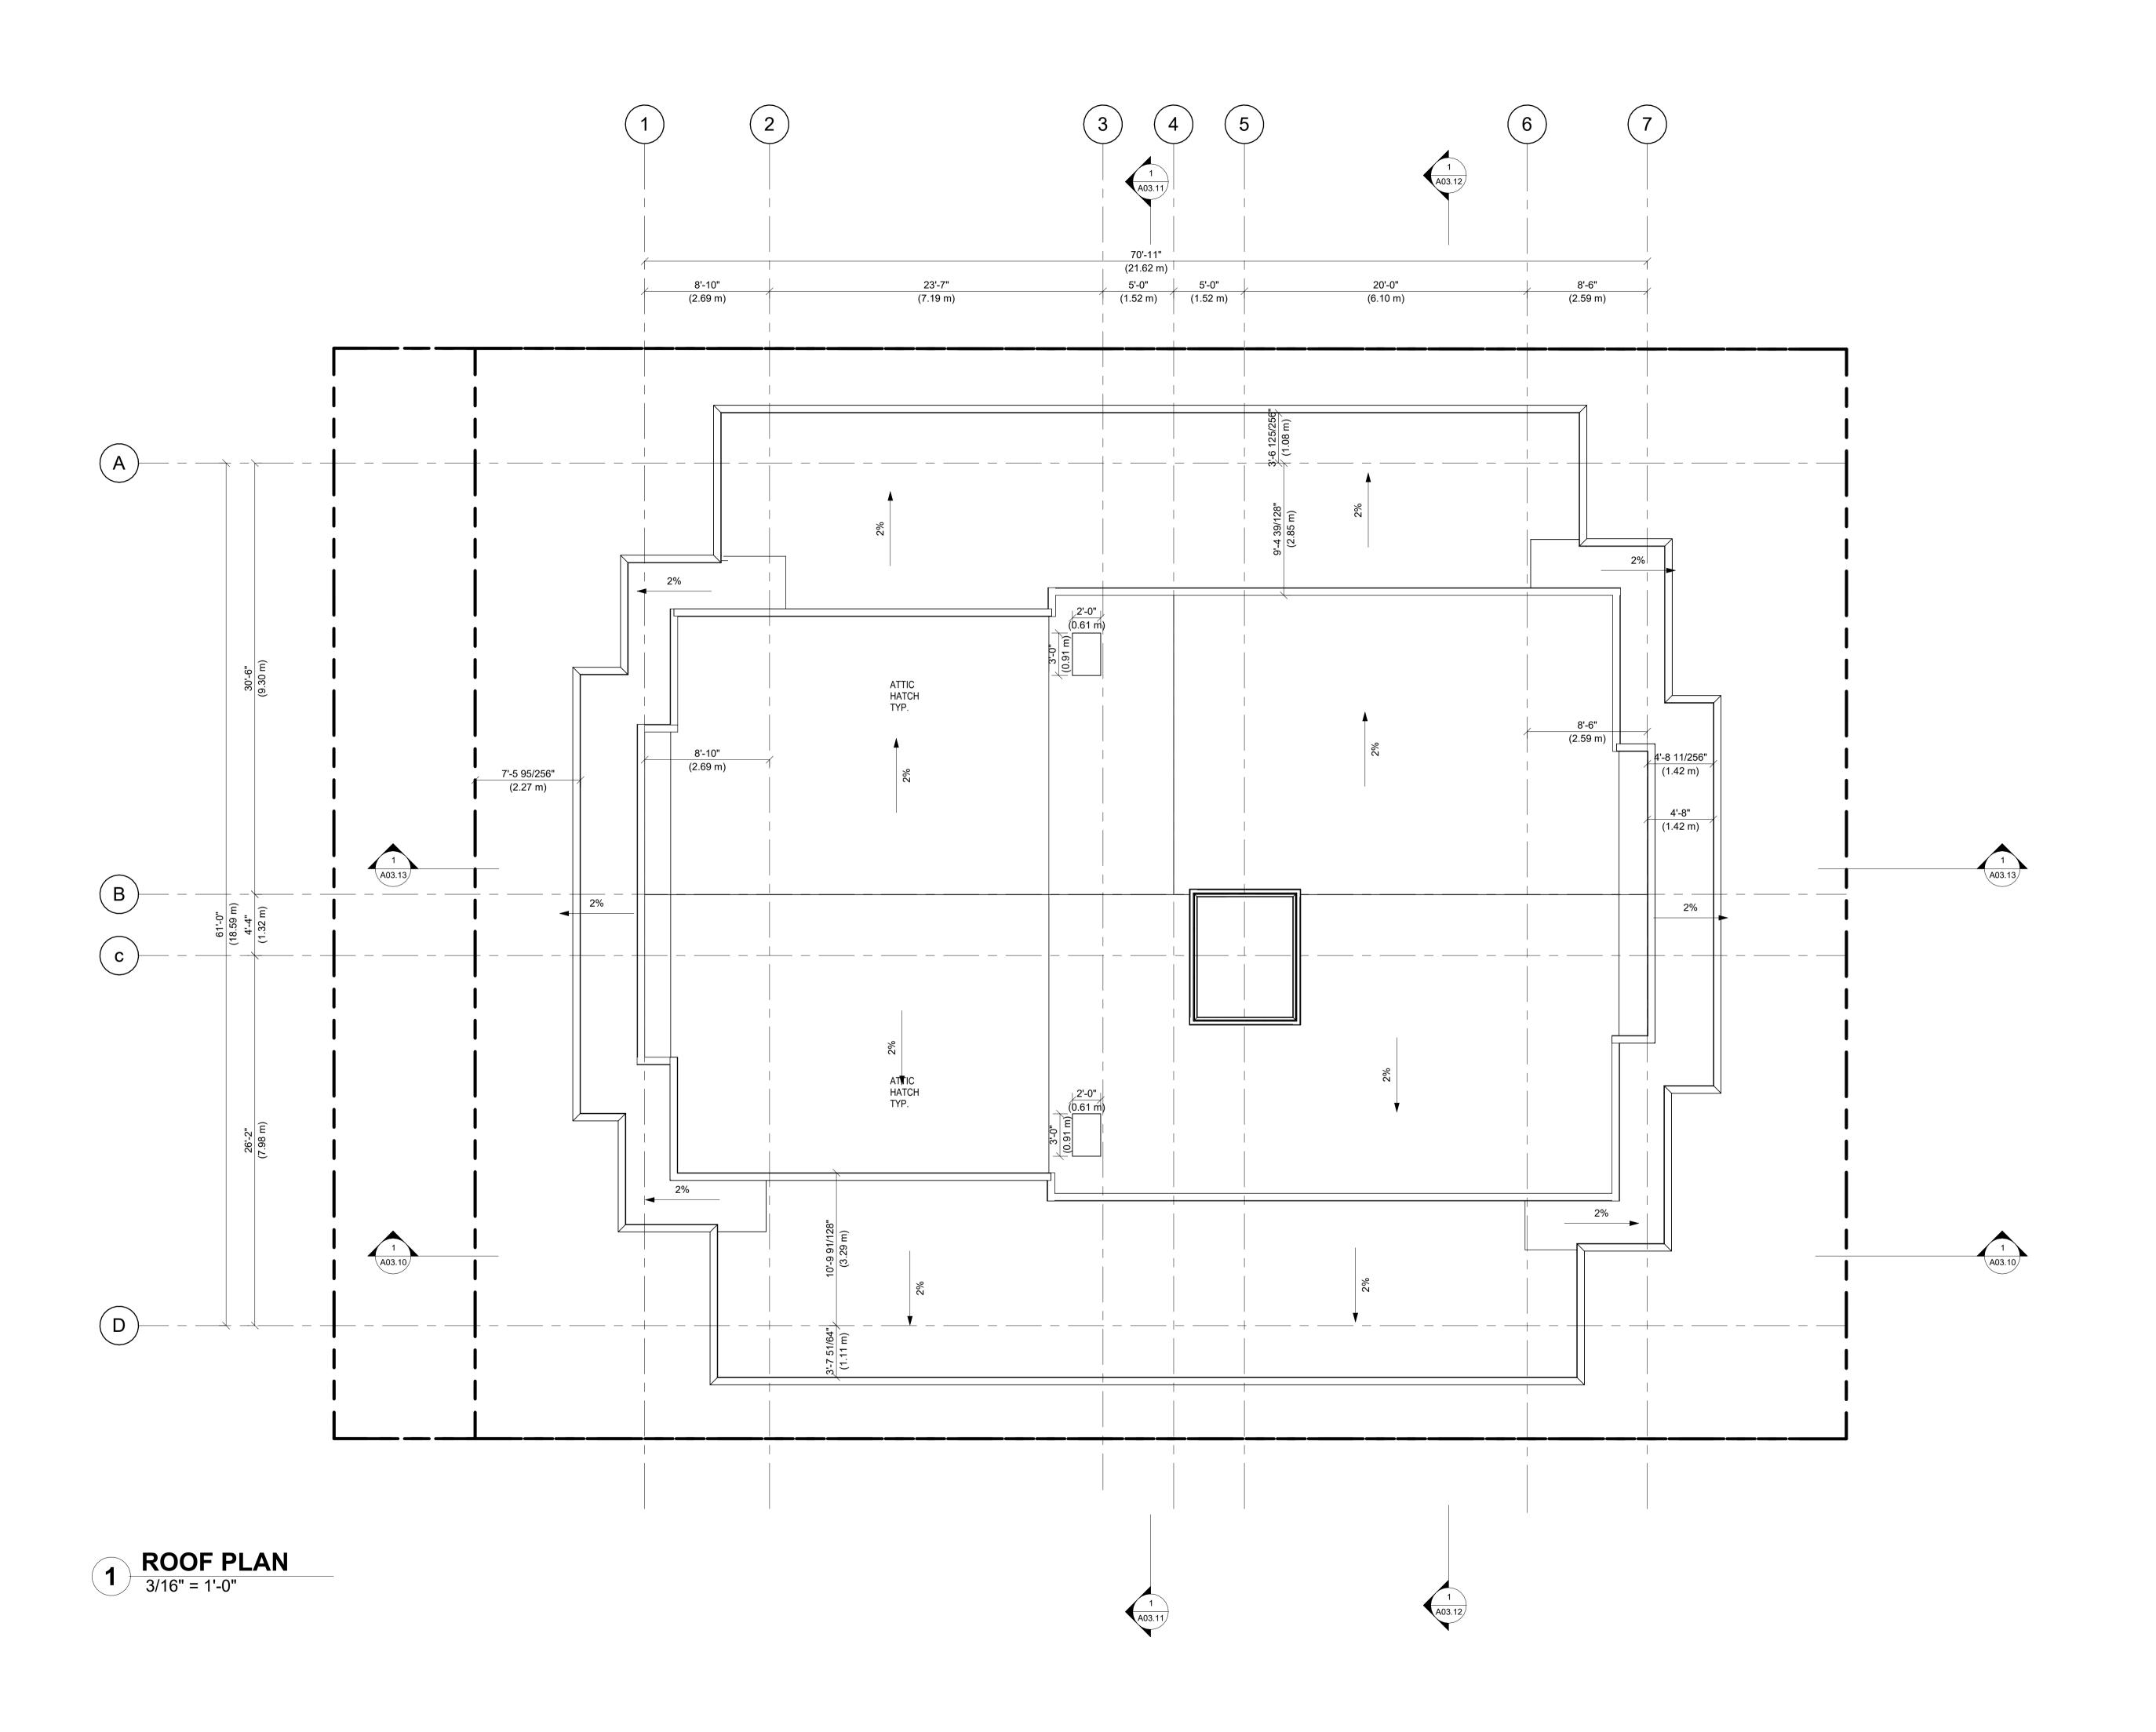



OFFICE
2025 Willingdon Avenue #900, Burnaby, BC. V5C 0J3
OFFICE: +1 (778)-372-8650, +1 (778)-372-8651
CELL: +1 (604)-780-3243, +1 (604)-780-6461
EMAIL: INFO@M-AARCHITECTS.COM
WWW.M-AARCHITECTS.COM

5 2023/01/27 ISSUED FOR LEGAL DOC.
 4 2023/01/23 ISSUED FOR CONSULTANT
 3 2023/01/19 ISSUED FOR CLIENT REVIEW
 2 2023/01/10 ISSUED FOR CLIENT REVIEW
 1 2022/12/09 ISSUED FOR CONSULT. USES

NO. DATE Y/M/D DESCRIPTION

ISSUES AND REVISIONS
SEAL

COPYRIGHT NO

COPYRIGHT NOTICE:
All rights reserved. All ideas, designs, drawings and reproductions either in print or electronic format, are the property of MA ARCHITECTS Ltd., and are an instrument of service that may not be used, forwarded to others, transmitted, downloaded or reproduced either in print or electronic format, without the express written

Written dimensions shall have precedence over scaled dimensions. Contractors shall verify and be responsible for all dimensions and conditions on the job; shall request clarification of errors, discrepancies, or doubtful information contained in contract drawings and documents. Failure to obtain such clarification renders the Contractor responsible for any resulting improper work and the cost of rectification. This drawing shall not be used for construction purposes until it is issued for the purpose.

PROJECT NAME

LONSDALE RESIDENTAL APARTMENT

permission of the copyright owner.

PROJECT ADDRESS

2612 LONSDALE AVE, NORTH VANCOUVER


DRAWING TITLE

ROOF PLAN

SCALE	3/16" = 1'-0"
DRAWN	SH
CHECKED	AP
DBO IECT NO	22042





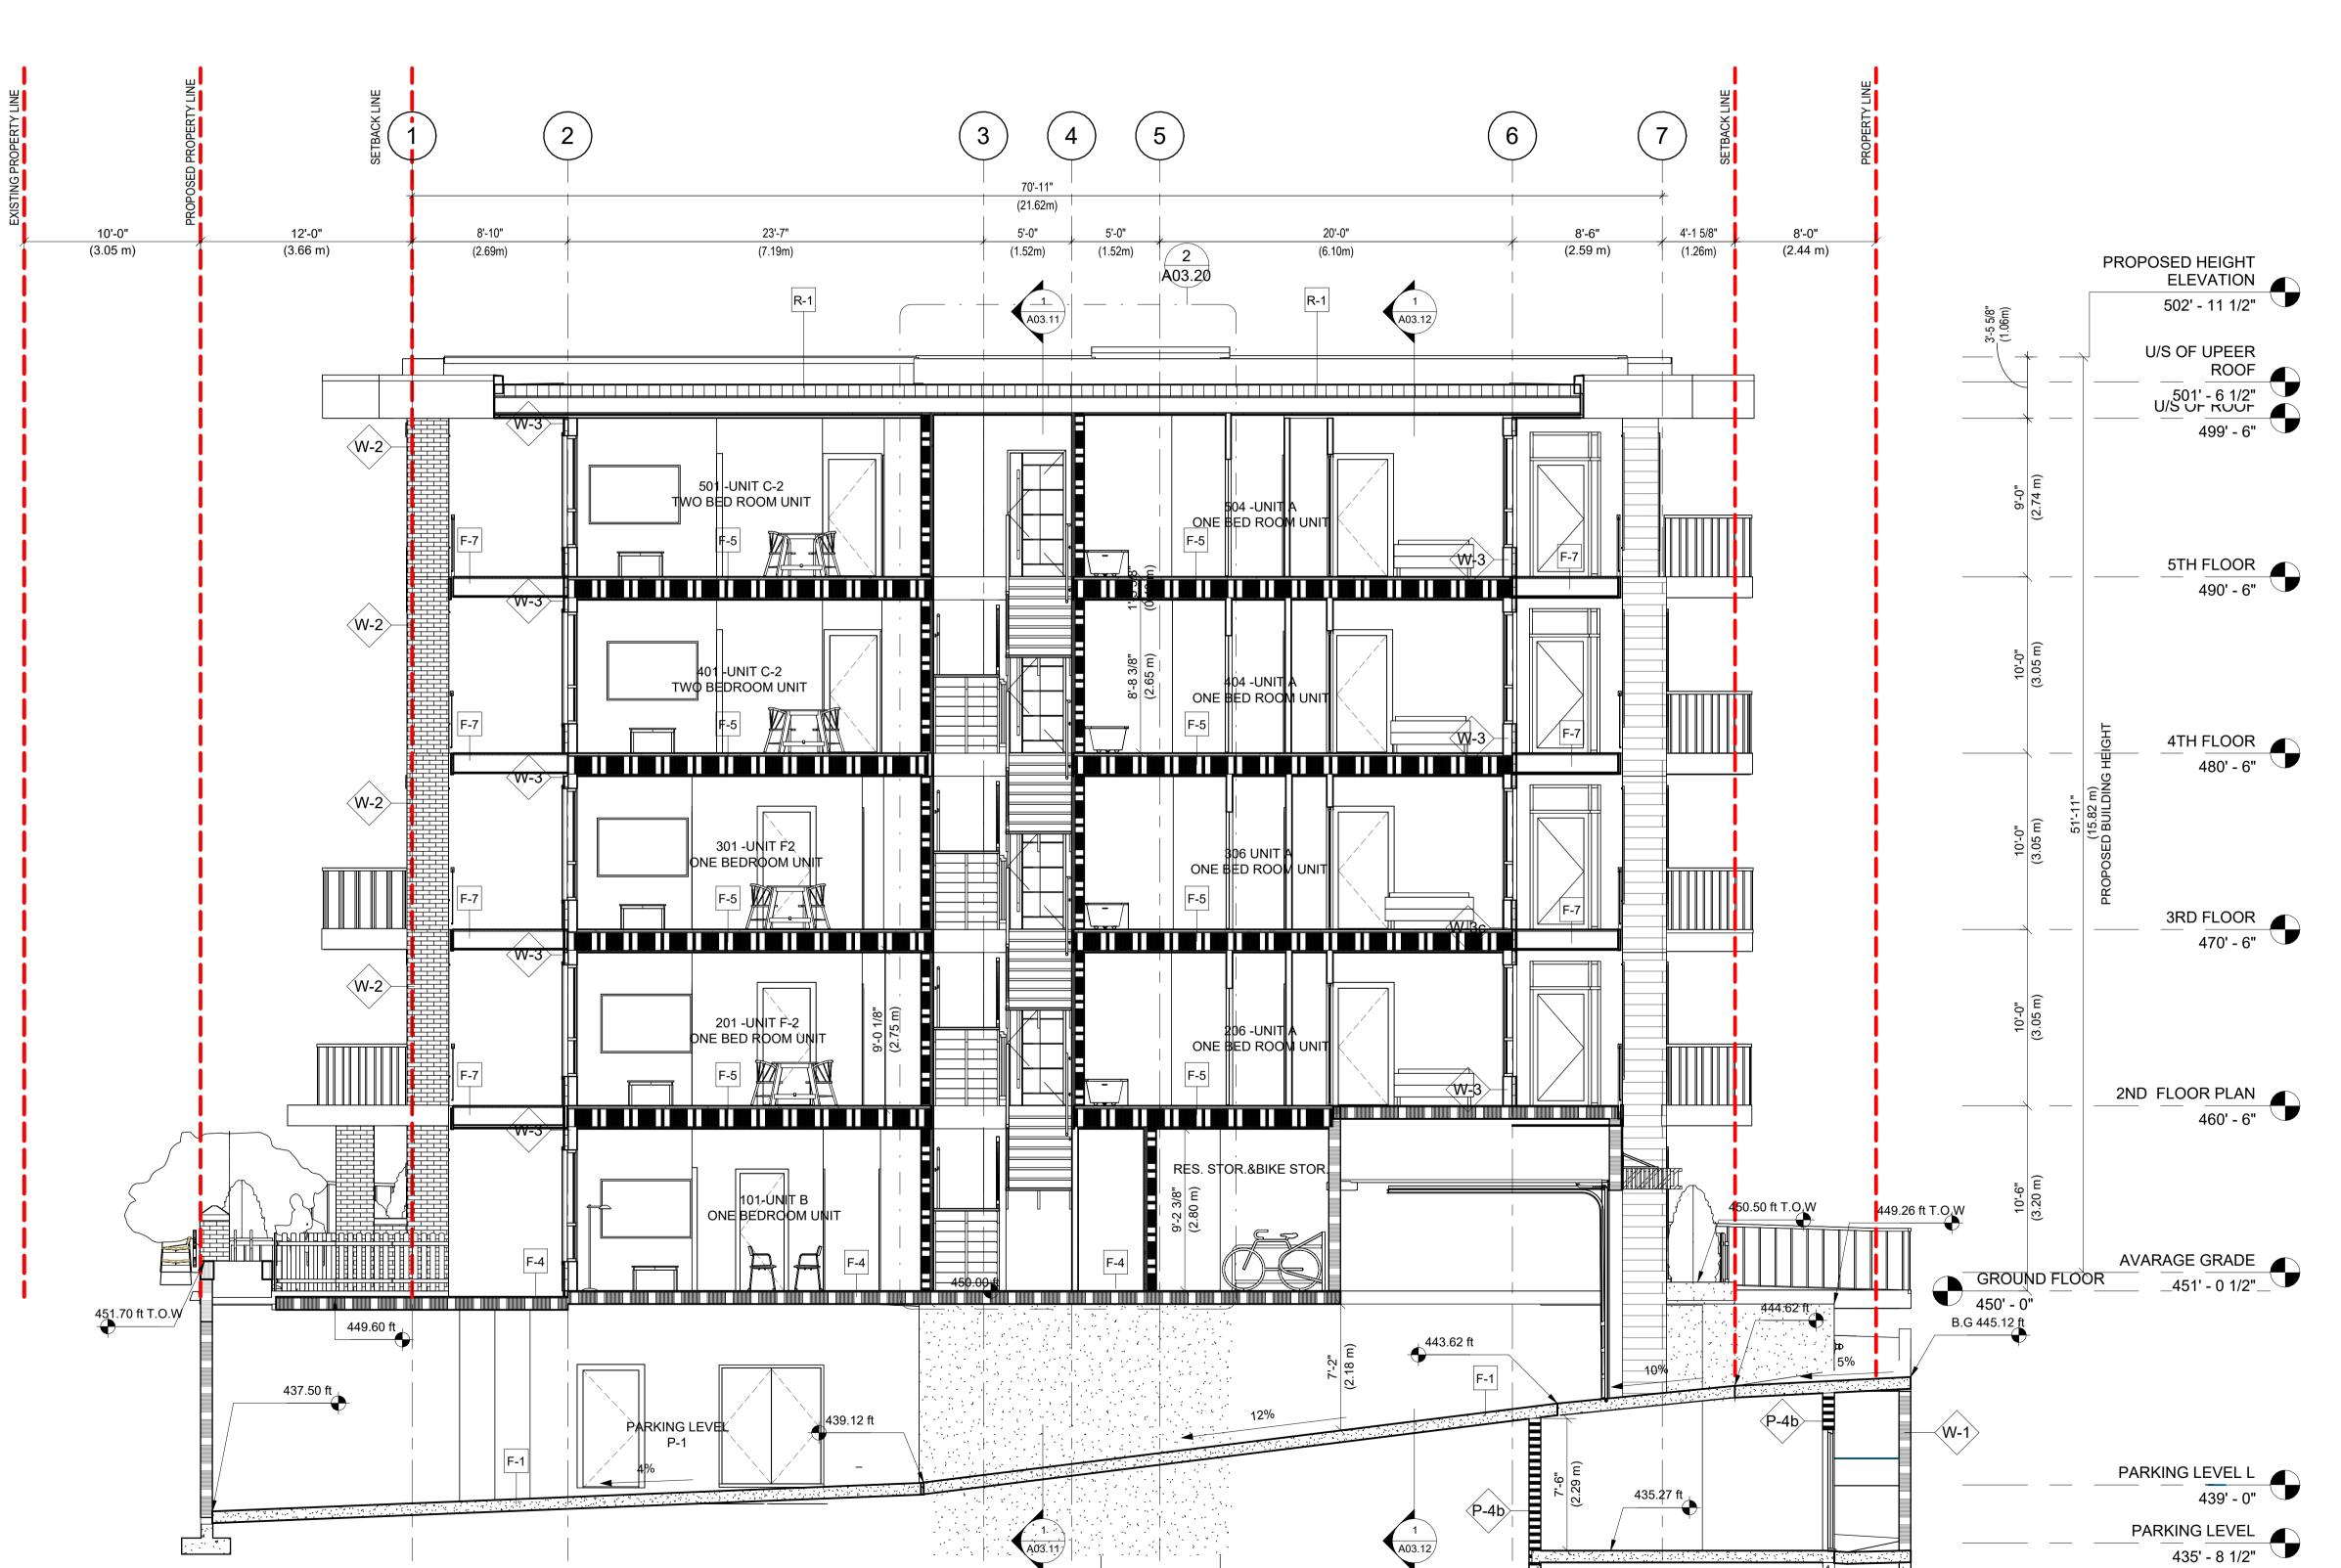

Section 13/16" = 1'-0"



0 HR FRR FIRE SEPARATION

1 HR FRR FIRE SEPARATION

3/4 HR FRR FIRE SEPARATION

2 HR FRR FIRE SEPARATION

1.5 HR FRR FIRE SEPARATION

WALL CONSTRUCTION
ALL FIRE-RATED WALLS MUST BE CONSTRUCTED TO

u/s STRUCTURE ABOVE.
ALL SOUND ATTENUATION WALLS TO BE
CONSTRUCTED TO u/s STRUCTURE ABOVE.

ALL WALLS, NOT NOTED ABOVE, TO CONTINUE TO 150mm (6") ABOVE CEILING

WET WALLS

JANITOR ROOM, CHANGE ROOMS, LOCKER ROOMS AND WASHROOMS - REPLACE GYPSUM BOARD w/ GREEN BOARD at ALL WET WALLS.

EXIT INDICATION

ACCESS TO EXIT

M A A

MA ARCHITECTS LTD.

OFFICE
2025 Willingdon Avenue #900, Burnaby, BC. V5C 0J3
T: 604.780.6461 604.780.3243
WWW.M-AARCHITECTS.COM
WWW.M-AARCHITECTS.CA

4 2023/01/23 ISSUED FOR CONSULTANT
3 2023/01/19 ISSUED FOR CLIENT REVIEW
2 2023/01/10 ISSUED FOR CLIENT REVIEW
1 2022/12/09 ISSUED FOR CONSULT. USES
NO. DATE Y/M/D DESCRIPTION

SEAL

ISSUES AND REVISIONS

COPYRIGHT NOTICE:
All rights reserved. All ideas, designs, drawings and reproductions either in print or electronic format, are the property of MA ARCHITECTS Ltd., and are an instrument of service that may not be used, forwarded to others, transmitted, downloaded or reproduced either in print or electronic format, without the express

Written dimensions shall have precedence over scaled dimensions. Contractors shall verify and be responsible for all dimensions and conditions on the job; shall request clarification of errors, discrepancies, or doubtful information contained in contract drawings and documents. Failure to obtain such clarification renders the Contractor responsible for any resulting improper work and the cost of rectification.

written permission of the copyright owner.

PROJECT NAME

LONSDALE RESIDENTAL APARTMENT

PROJECT ADDRESS

2612 LONSDALE AVE, NORTH VANCOUVER


DRAWING TITLE

BUILDING SECTIONS

SCALE	As indicated
DRAWN	SH
CHECKED	AP
PROJECT NO.	22042



A03.10

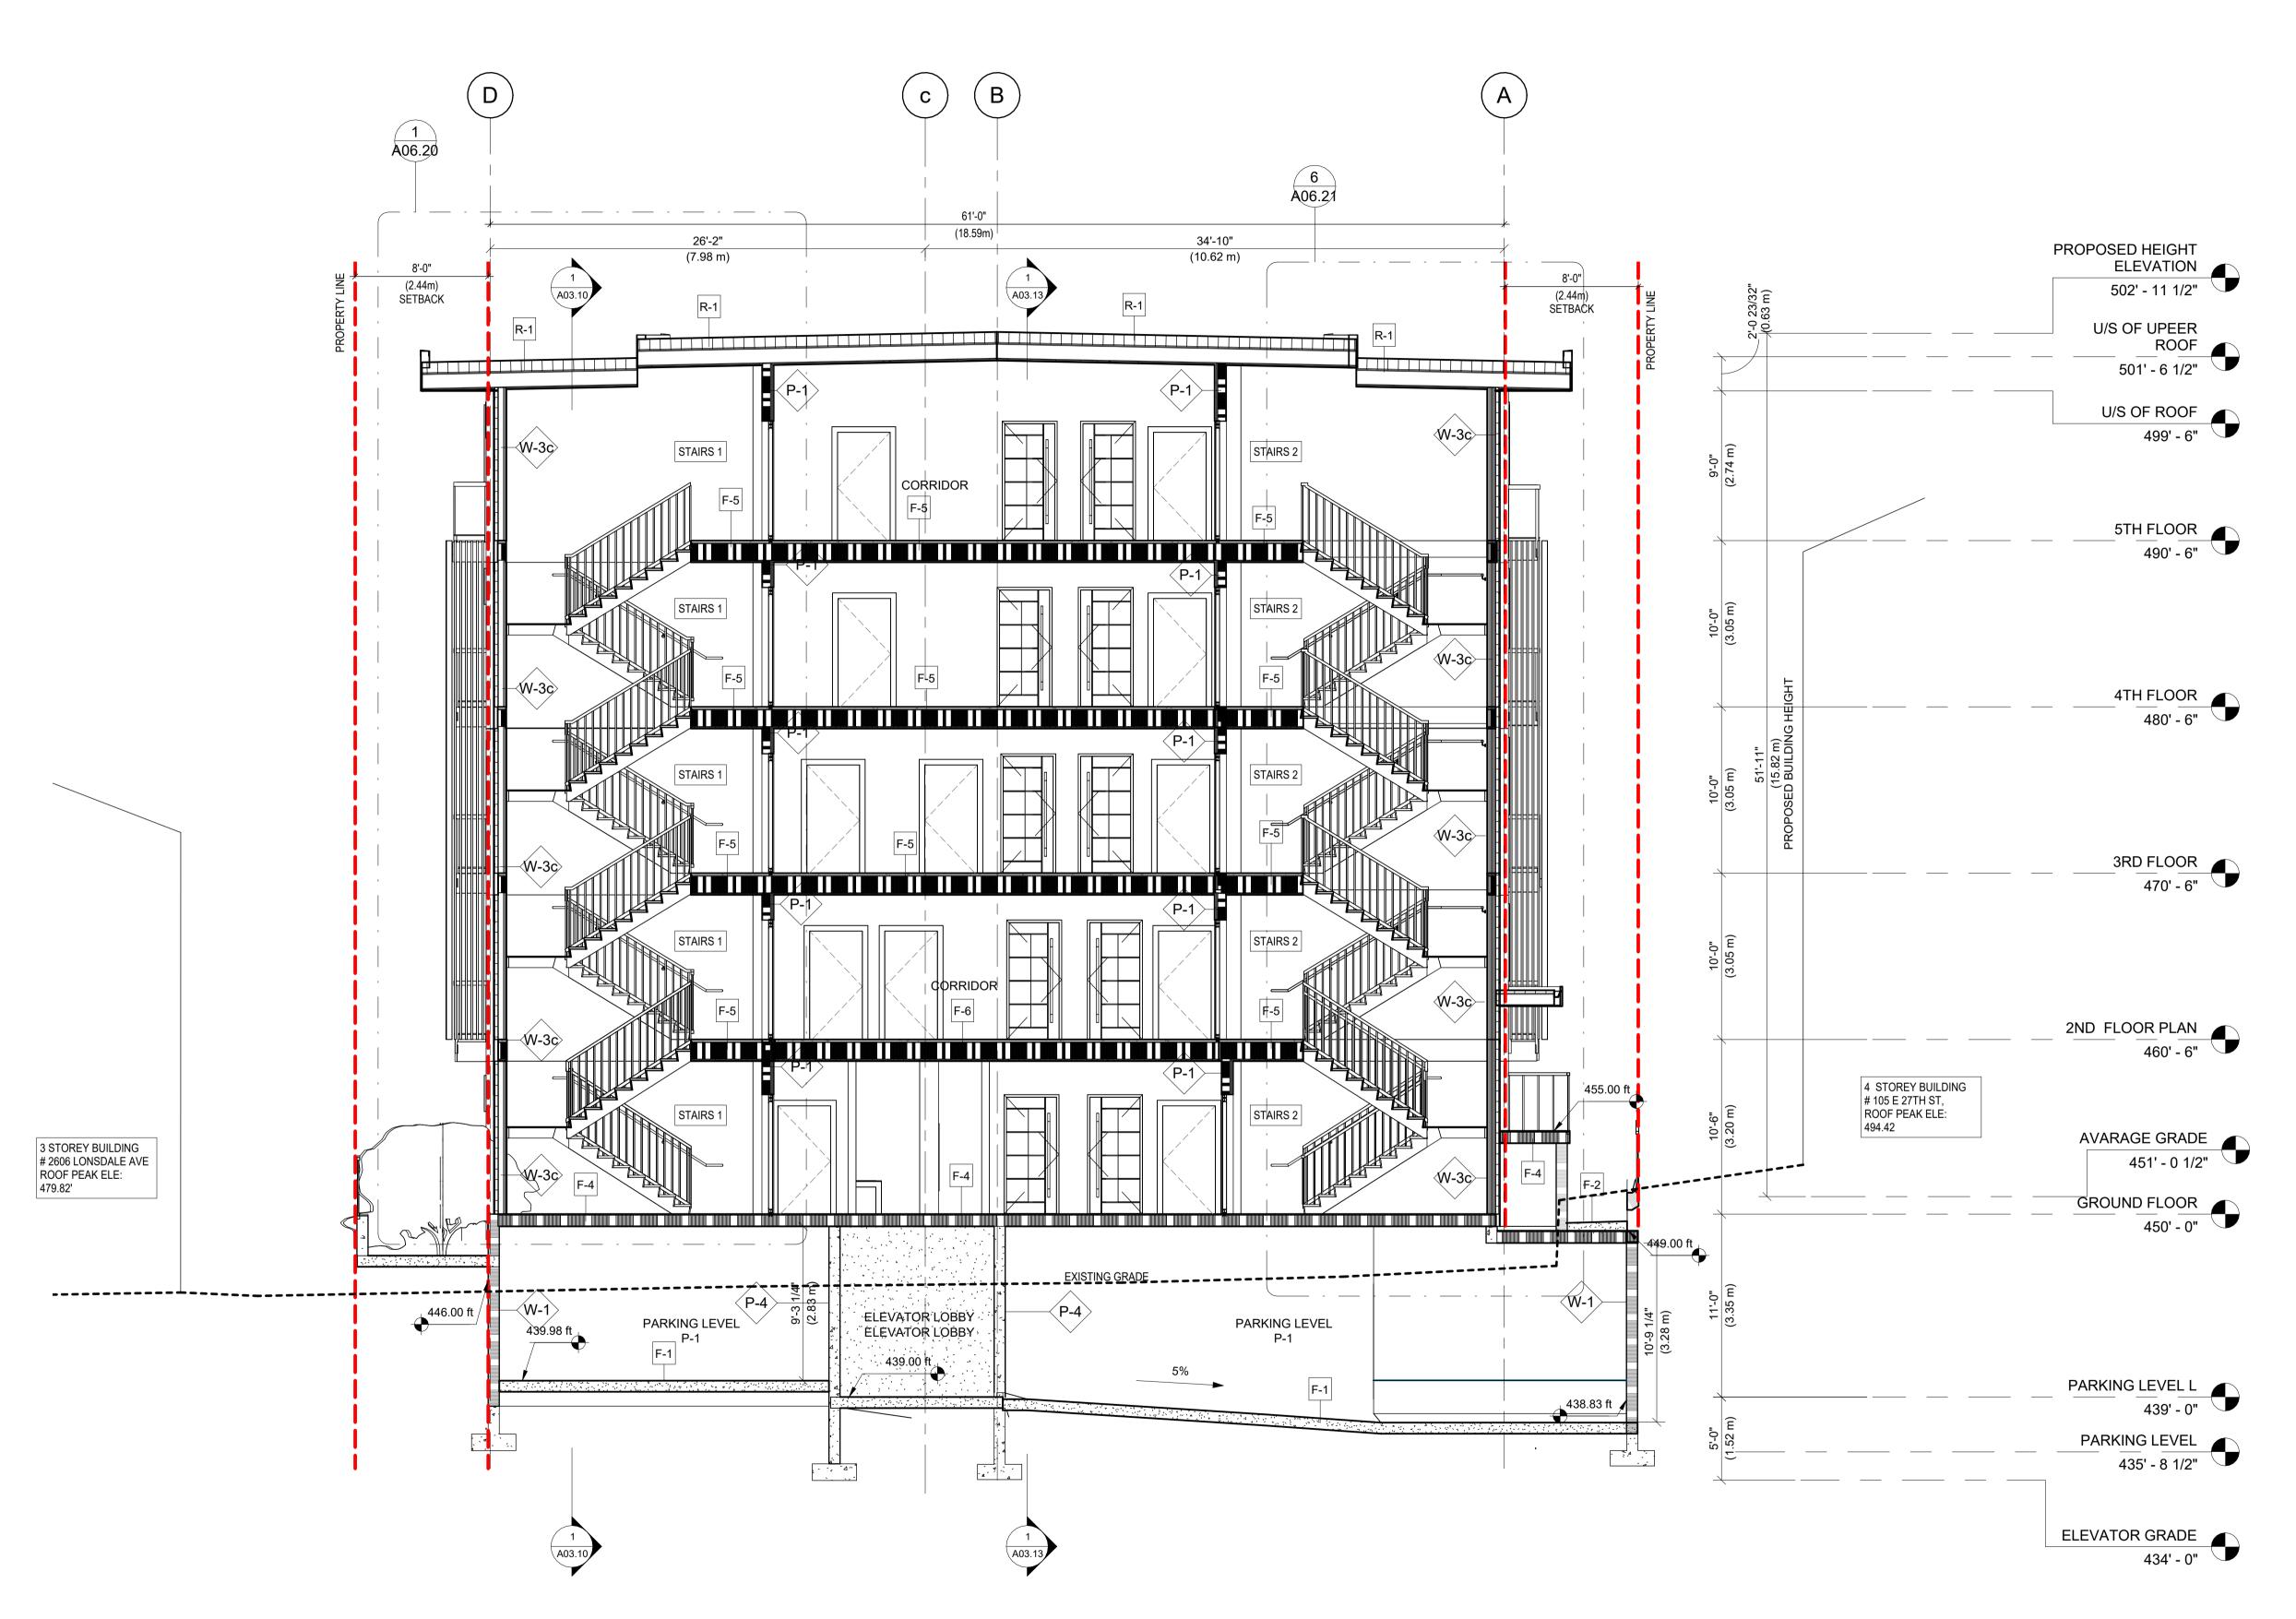



FIRE SEPARATION LEGEND

0 HR FRR FIRE SEPARATION

3/4 HR FRR FIRE SEPARATION

2 HR FRR FIRE SEPARATION

1 HR FRR FIRE SEPARATION

1.5 HR FRR FIRE SEPARATION

WALL CONSTRUCTION

ALL FIRE-RATED WALLS MUST BE CONSTRUCTED TO u/s STRUCTURE ABOVE.

ALL SOUND ATTENUATION WALLS TO BE CONSTRUCTED TO u/s STRUCTURE ABOVE.


ALL WALLS, NOT NOTED ABOVE, TO CONTINUE TO 150mm (6") ABOVE CEILING

WET WALLS

JANITOR ROOM, CHANGE ROOMS, LOCKER ROOMS AND WASHROOMS - REPLACE GYPSUM BOARD w/ GREEN BOARD at ALL WET WALLS.

EXIT INDICATION

ACCESS TO EXIT

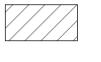

MA ARCHITECTS LTD.

OFFICE
2025 Willingdon Avenue #900, Burnaby, BC. V5C 0J3
T: 604.780.6461 604.780.3243
WWW.M-AARCHITECTS.COM
WWW.M-AARCHITECTS.CA

5 2023/01/27 ISSUED FOR LEGAL DOC.
4 2023/01/23 ISSUED FOR CONSULTANT
3 2023/01/19 ISSUED FOR CLIENT REVIEW
2 2023/01/10 ISSUED FOR CLIENT REVIEW
1 2022/12/09 ISSUED FOR CONSULT. USES
NO. DATE Y/M/D DESCRIPTION

ISSUES AND REVISIONS

SEAL

COPYRIGHT NOTICE:
All rights reserved. All ideas, designs, drawings and reproductions either in print or electronic format, are the property of MA ARCHITECTS Ltd., and are an instrument of service that may not be used, forwarded to others, transmitted, downloaded or reproduced either in print or electronic format, without the express written permission of the copyright owner.

Written dimensions shall have precedence over scaled dimensions. Contractors shall verify and be responsible for all dimensions and conditions on the job; shall request clarification of errors, discrepancies, or doubtful information contained in contract drawings and documents. Failure to obtain such clarification renders the Contractor responsible for any resulting improper work and the cost of rectification.

PROJECT NAME

LONSDALE RESIDENTAL APARTMENT

PROJECT ADDRESS

2612 LONSDALE AVE, NORTH VANCOUVER

DRAWING TITLE


BUILDING SECTIONS

SCALE	As indicated
DRAWN	SH
CHECKED	AP
PROJECT NO.	22042

DRAWING NO.

A03.11

THIS DRAWING IS PROPERTY OF MA ARCHITECTS LTD. AND SHOULD NOT BE COPIED OR DISTRIBUTED WITHOUT PRIOR WRITTEN CONSENT.

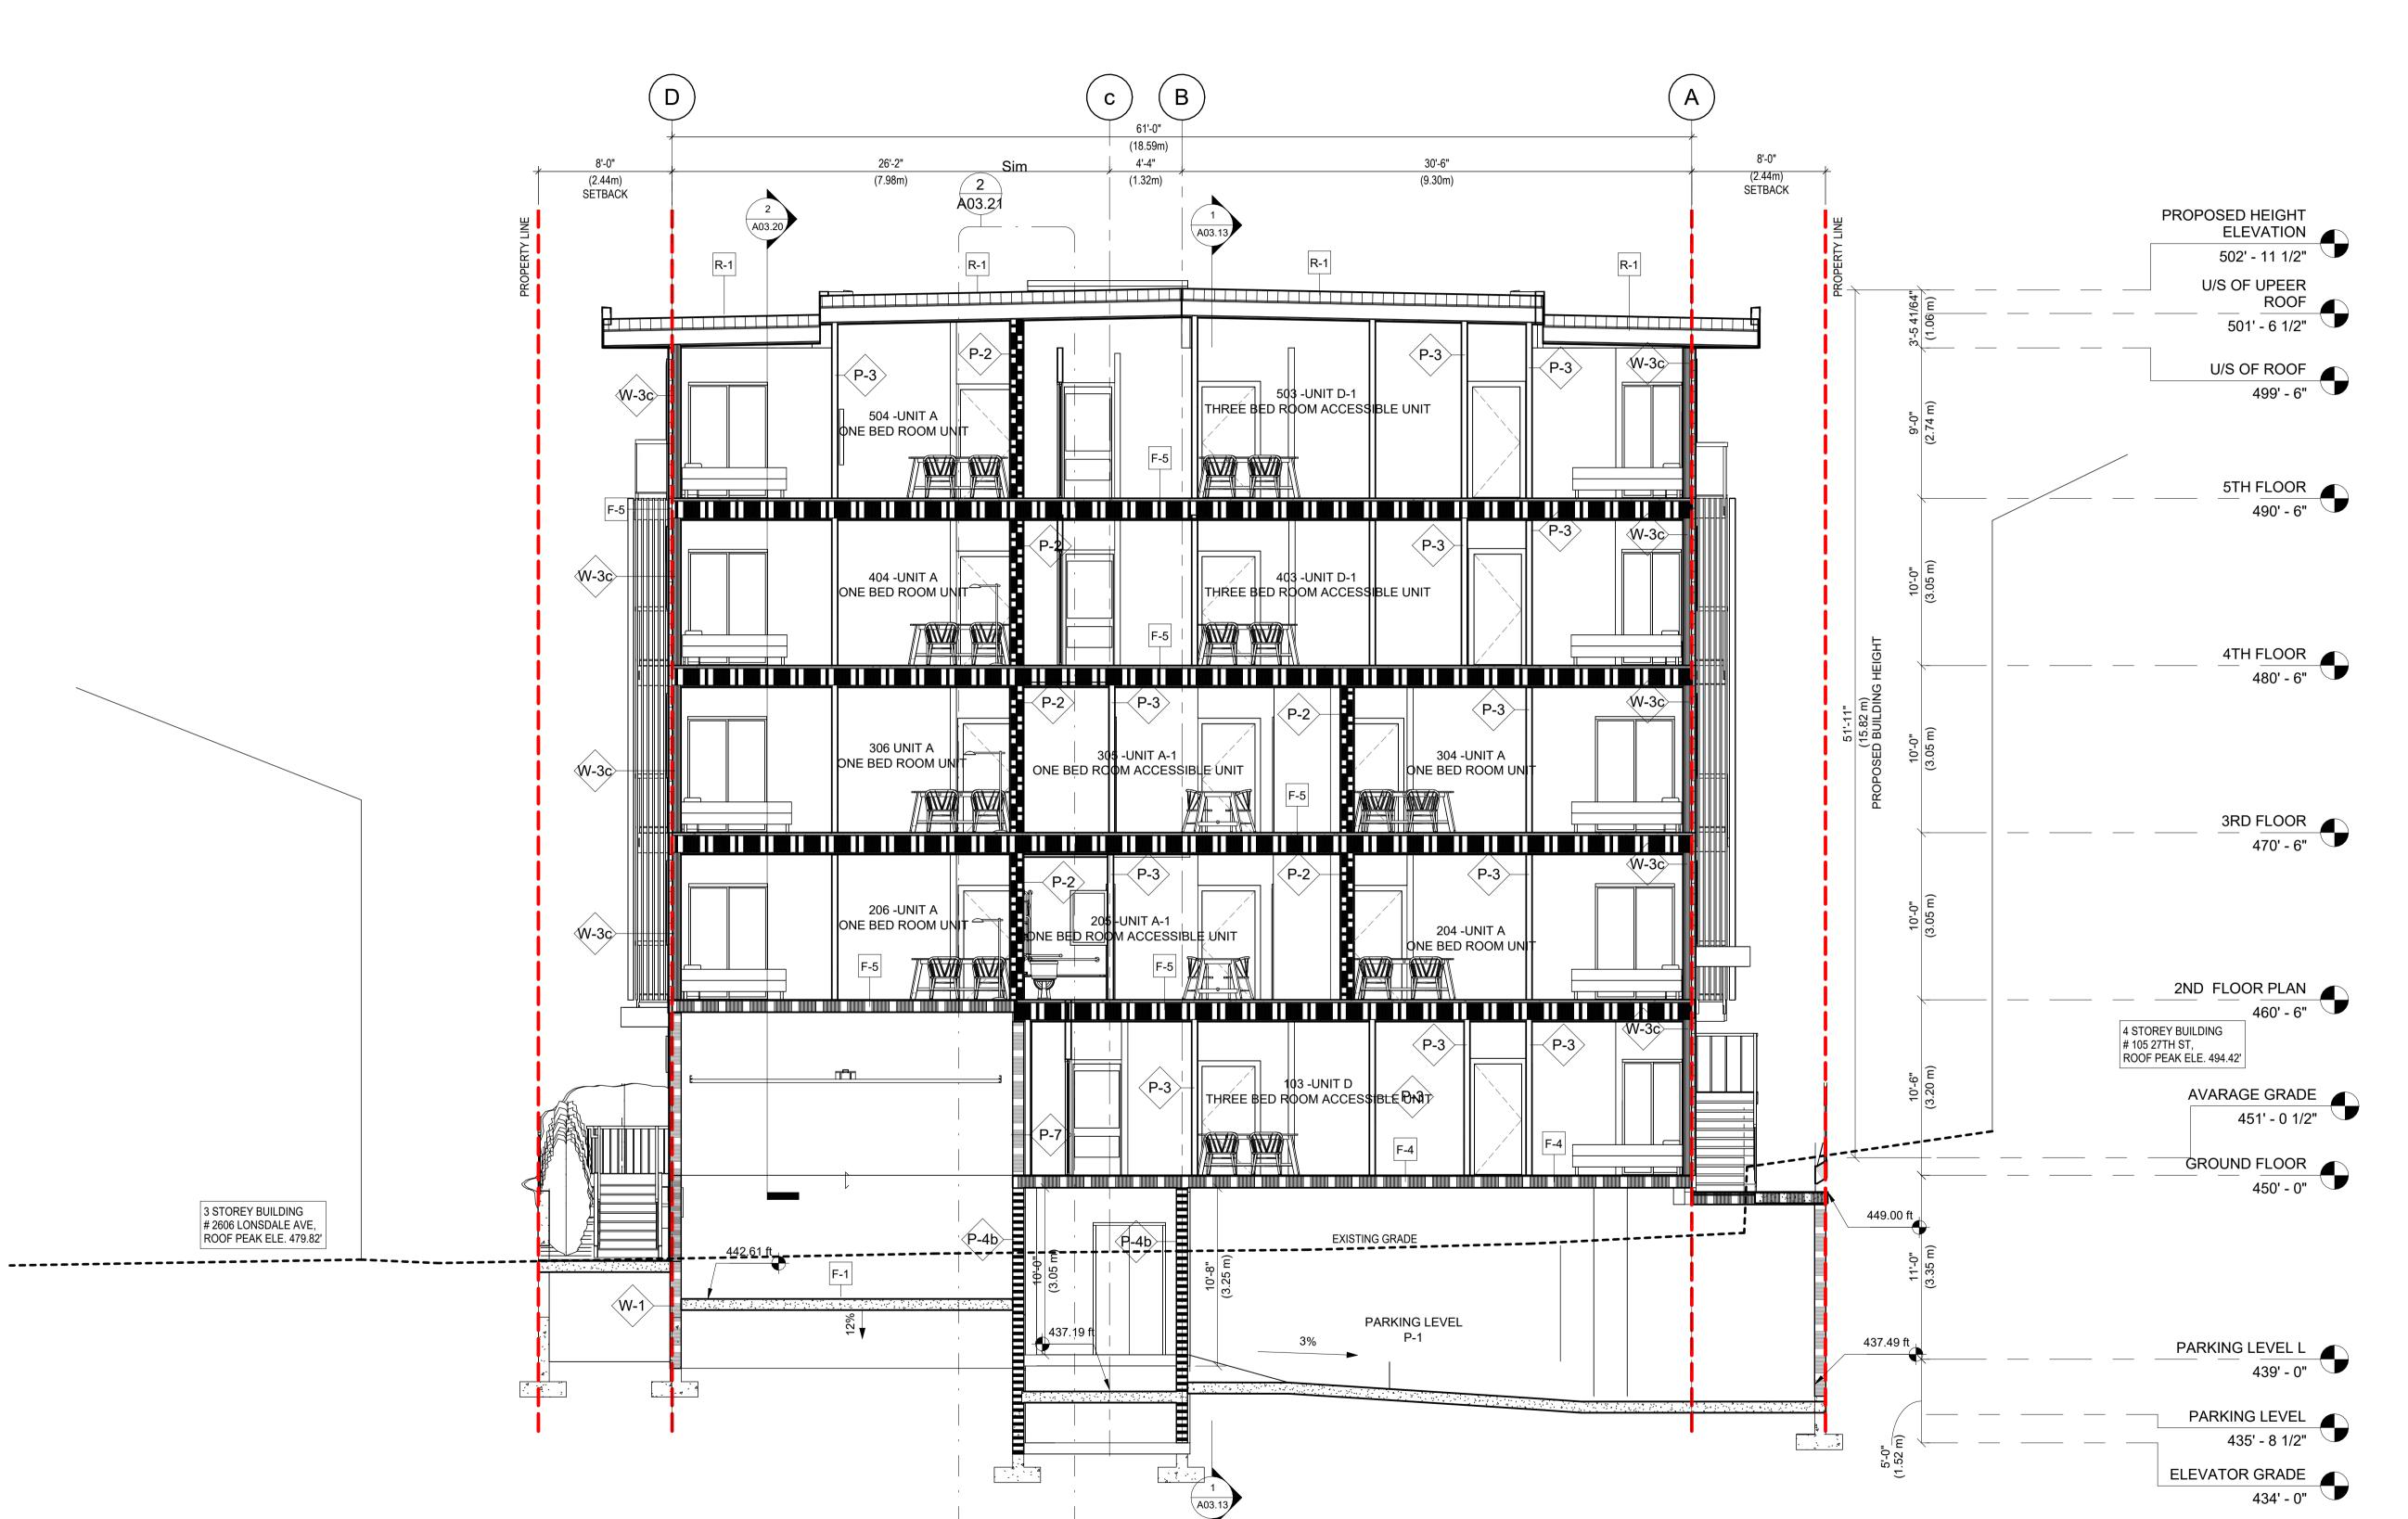



2025 Willingdon Avenue #900, Burnaby, BC. V5C 0J3 OFFICE: +1 (778)-372-8650, +1 (778)-372-8651 CELL: +1 (604)-780-3243, +1 (604)-780-6461

EMAIL: INFO@M-AARCHITECTS.COM WWW.M-AARCHITECTS.COM

FIRE SEPARATION LEGEND

3/4 HR FRR FIRE SEPARATION

WALL CONSTRUCTION

u/s STRUCTURE ABOVE.

CONSTRUCTED TO u/s STRUCTURE ABOVE. ALL WALLS, NOT NOTED ABOVE, TO CONTINUE TO

WET WALLS

JANITOR ROOM, CHANGE ROOMS, LOCKER ROOMS AND WASHROOMS - REPLACE GYPSUM BOARD w/

ACCESS TO EXIT

0 HR FRR FIRE SEPARATION

1 HR FRR FIRE SEPARATION

1.5 HR FRR FIRE SEPARATION

2 HR FRR FIRE SEPARATION

ALL FIRE-RATED WALLS MUST BE CONSTRUCTED TO ALL SOUND ATTENUATION WALLS TO BE

150mm (6") ABOVE CEILING

GREEN BOARD at ALL WET WALLS.

EXIT INDICATION

4 2023/01/23 ISSUED FOR CONSULTANT 2023/01/19 ISSUED FOR CLIENT REVIEW 2023/01/10 ISSUED FOR CLIENT REVIEW 2022/12/09 ISSUED FOR CONSULT. USES

NO. DATE Y/M/D DESCRIPTION

ISSUES AND REVISIONS

SEAL

COPYRIGHT NOTICE: All rights reserved. All ideas, designs, drawings and reproductions either in print or electronic format, are the property of MA ARCHITECTS Ltd., and are an instrument of service that may not be used, forwarded to others, transmitted, downloaded or reproduced either in print or electronic format, without the express written

permission of the copyright owner. Written dimensions shall have precedence over scaled dimensions. Contractors shall verify and be responsible for all dimensions and conditions on the job; shall request clarification of errors, discrepancies, or doubtful information contained in contract drawings and documents. Failure to obtain such clarification renders the Contractor responsible for any resulting improper work and the cost of rectification. This drawing shall not be used for construction purposes until it is issued for the purpose.

PROJECT NAME

LONSDALE RESIDENTAL **APARTMENT**

PROJECT ADDRESS

2612 LONSDALE AVE, NORTH VANCOUVER

DRAWING TITLE


DRAWING NO.

BUILDING SECTIONS

SCALE As indicated SH DRAWN CHECKED AP PROJECT NO. 22042

A03.12

THIS DRAWING IS PROPERTY OF MA ARCHITECTS LTD. AND SHOULD NOT BE COPIED OR DISTRIBUTED WITHOUT PRIOR WRITTEN CONSENT.

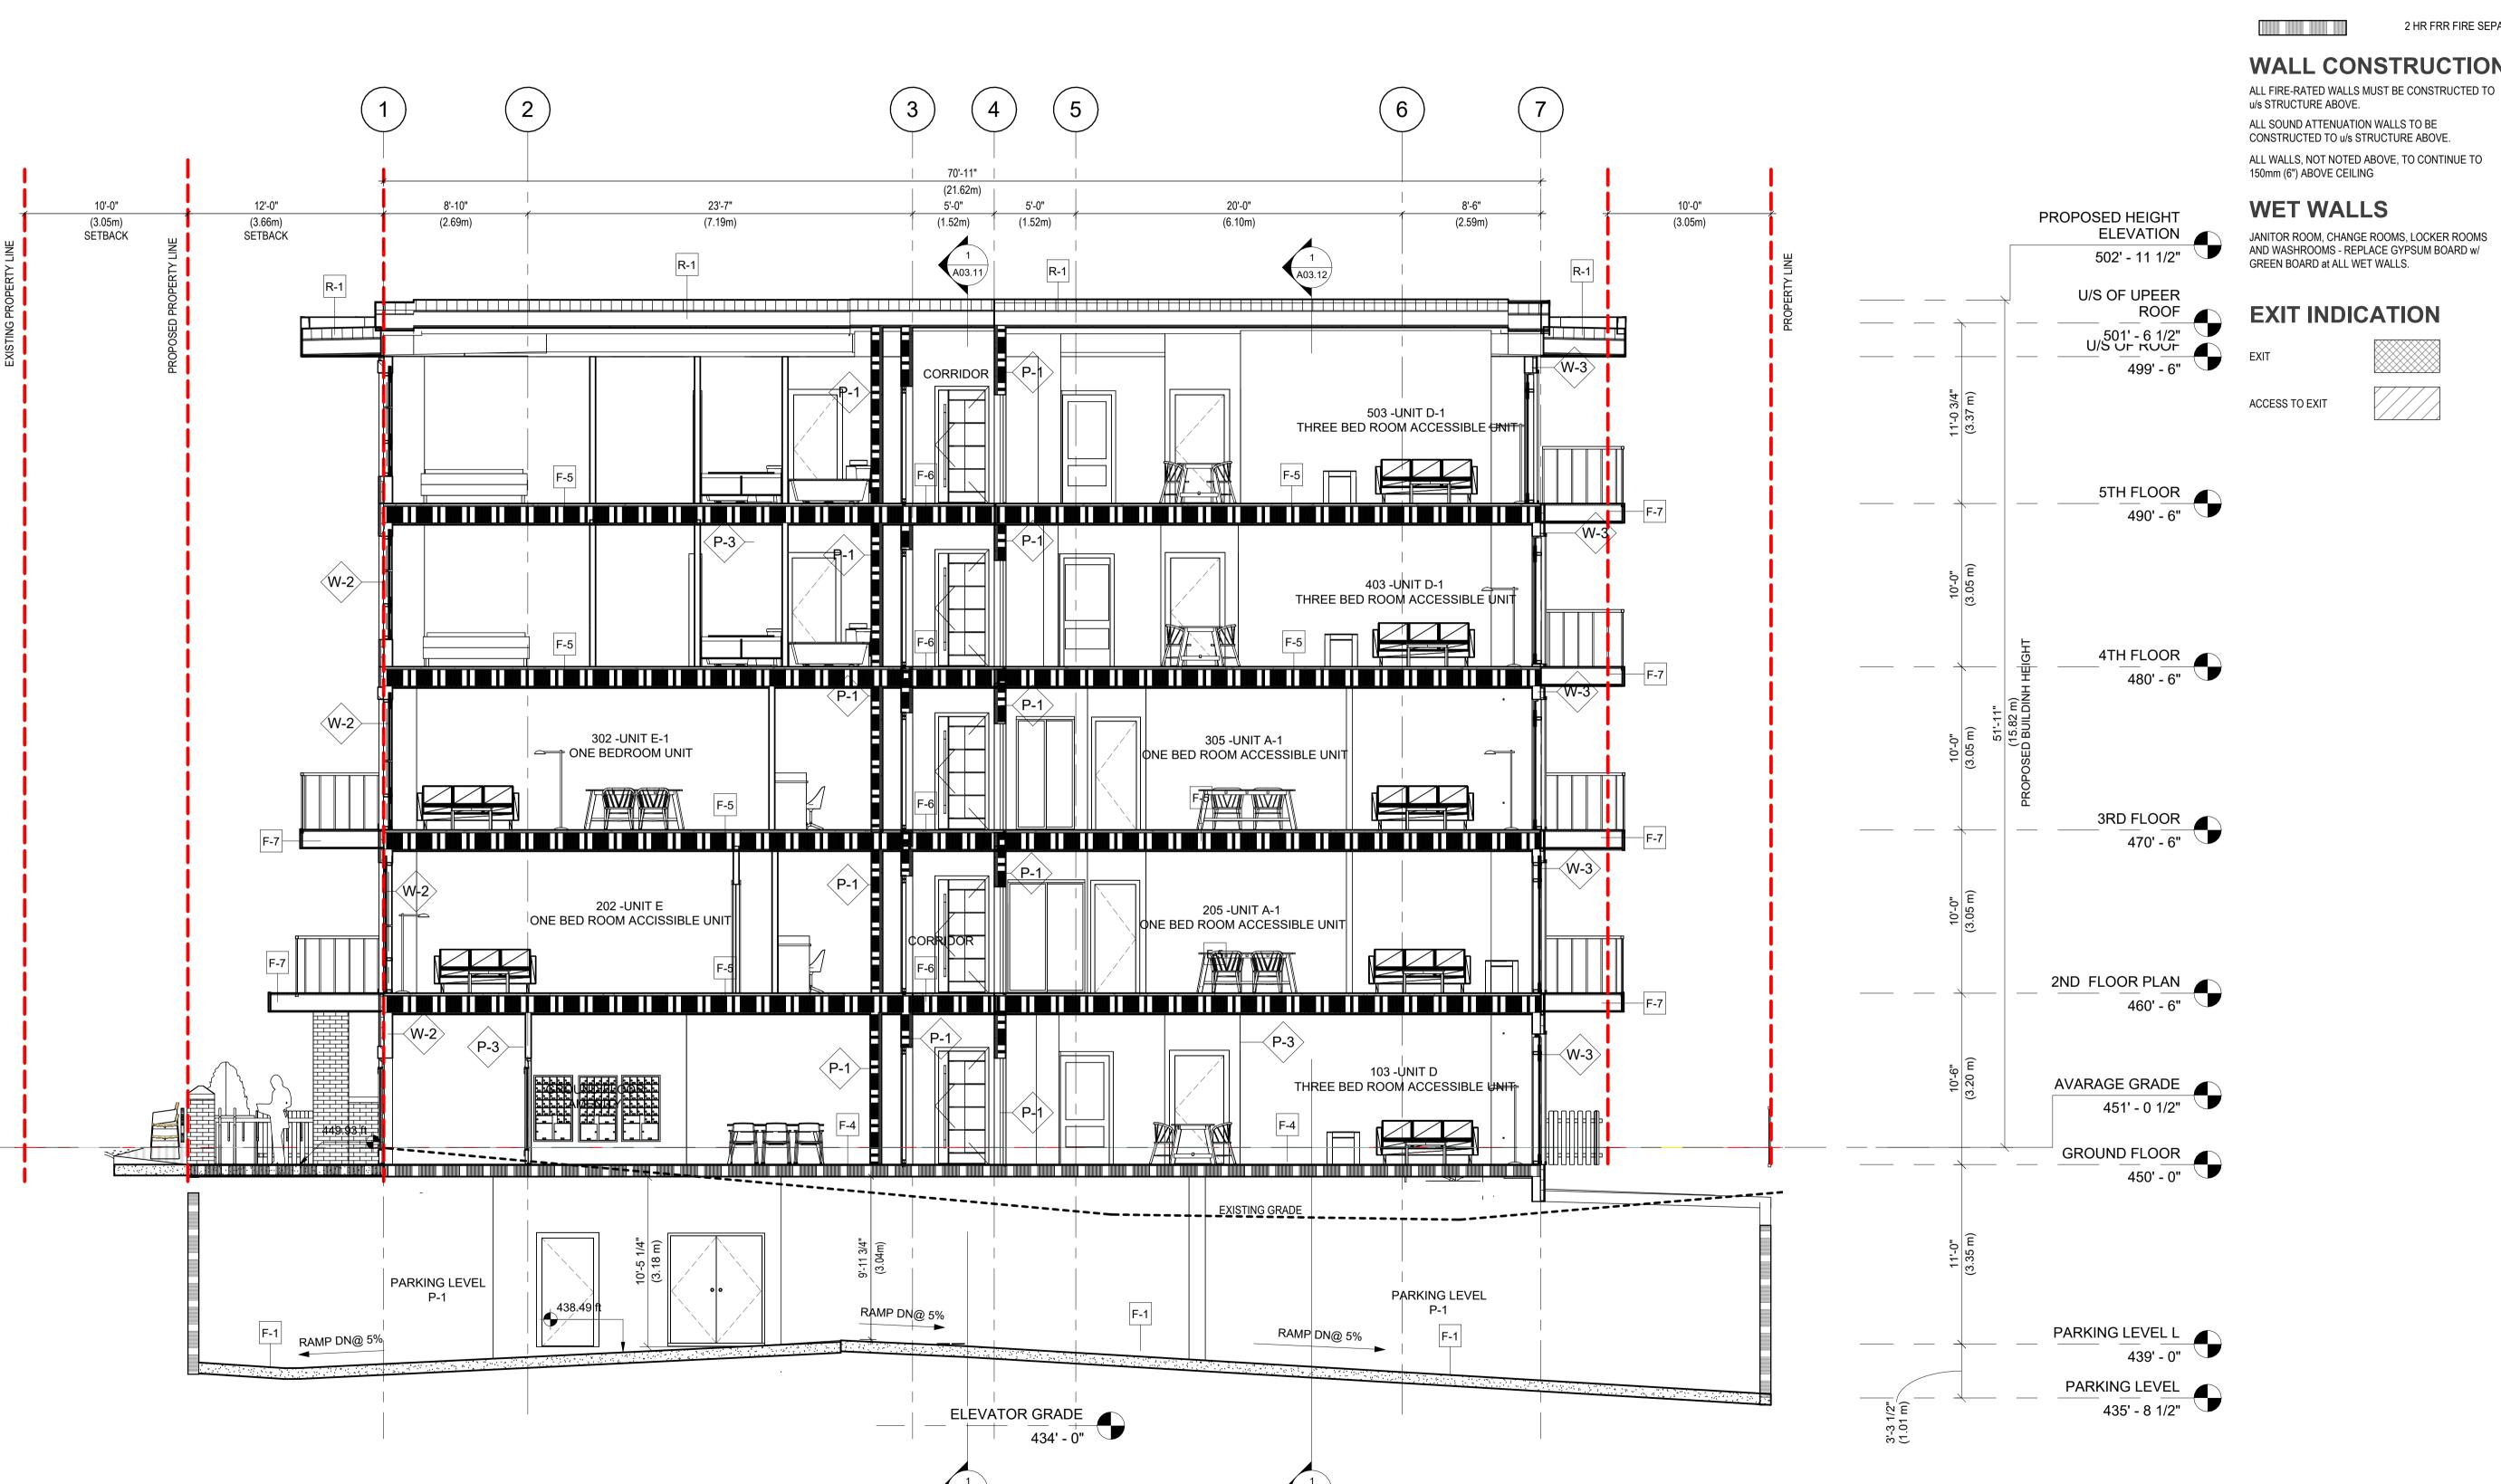

Section 4 3/16" = 1'-0"



0 HR FRR FIRE SEPARATION

3/4 HR FRR FIRE SEPARATION

1 HR FRR FIRE SEPARATION

1.5 HR FRR FIRE SEPARATION

2 HR FRR FIRE SEPARATION

WALL CONSTRUCTION

u/s STRUCTURE ABOVE. ALL SOUND ATTENUATION WALLS TO BE CONSTRUCTED TO u/s STRUCTURE ABOVE. ALL WALLS, NOT NOTED ABOVE, TO CONTINUE TO 150mm (6") ABOVE CEILING

WET WALLS

JANITOR ROOM, CHANGE ROOMS, LOCKER ROOMS AND WASHROOMS - REPLACE GYPSUM BOARD w/ GREEN BOARD at ALL WET WALLS.

EXIT INDICATION

ACCESS TO EXIT

2023/01/27 ISSUED FOR LEGAL DOC. 2023/01/23 ISSUED FOR CONSULTANT 2023/01/19 ISSUED FOR CLIENT REVIEW 2023/01/10 ISSUED FOR CLIENT REVIEW 2022/12/09 ISSUED FOR CONSULT. USES

2025 Willingdon Avenue #900, Burnaby, BC. V5C 0J3 OFFICE: +1 (778)-372-8650, +1 (778)-372-8651

EMAIL: INFO@M-AARCHITECTS.COM WWW.M-AARCHITECTS.COM

ISSUES AND REVISIONS

NO. DATE Y/M/D DESCRIPTION

SEAL

COPYRIGHT NOTICE: All rights reserved. All ideas, designs, drawings and reproductions either in print or electronic format, are the property of MA ARCHITECTS Ltd., and are an instrument of service that may not be used, forwarded to others, transmitted, downloaded or reproduced either in print or electronic format, without the express written

permission of the copyright owner.

Written dimensions shall have precedence over scaled dimensions. Contractors shall verify and be responsible for all dimensions and conditions on the job; shall request clarification of errors, discrepancies, or doubtful information contained in contract drawings and documents. Failure to obtain such clarification renders the Contractor responsible for any resulting improper work and the cost of rectification. This drawing shall not be used for construction purposes until it is issued for the purpose.

PROJECT NAME

LONSDALE RESIDENTAL **APARTMENT**

PROJECT ADDRESS

2612 LONSDALE AVE, NORTH VANCOUVER

DRAWING TITLE


DRAWING NO.


BUILDING SECTIONS


SCALE	As indicated
DRAWN	SH
CHECKED	AP
PROJECT NO.	22042



EMAIL: INFO@M-AARCHITECTS.COM WWW.M-AARCHITECTS.COM

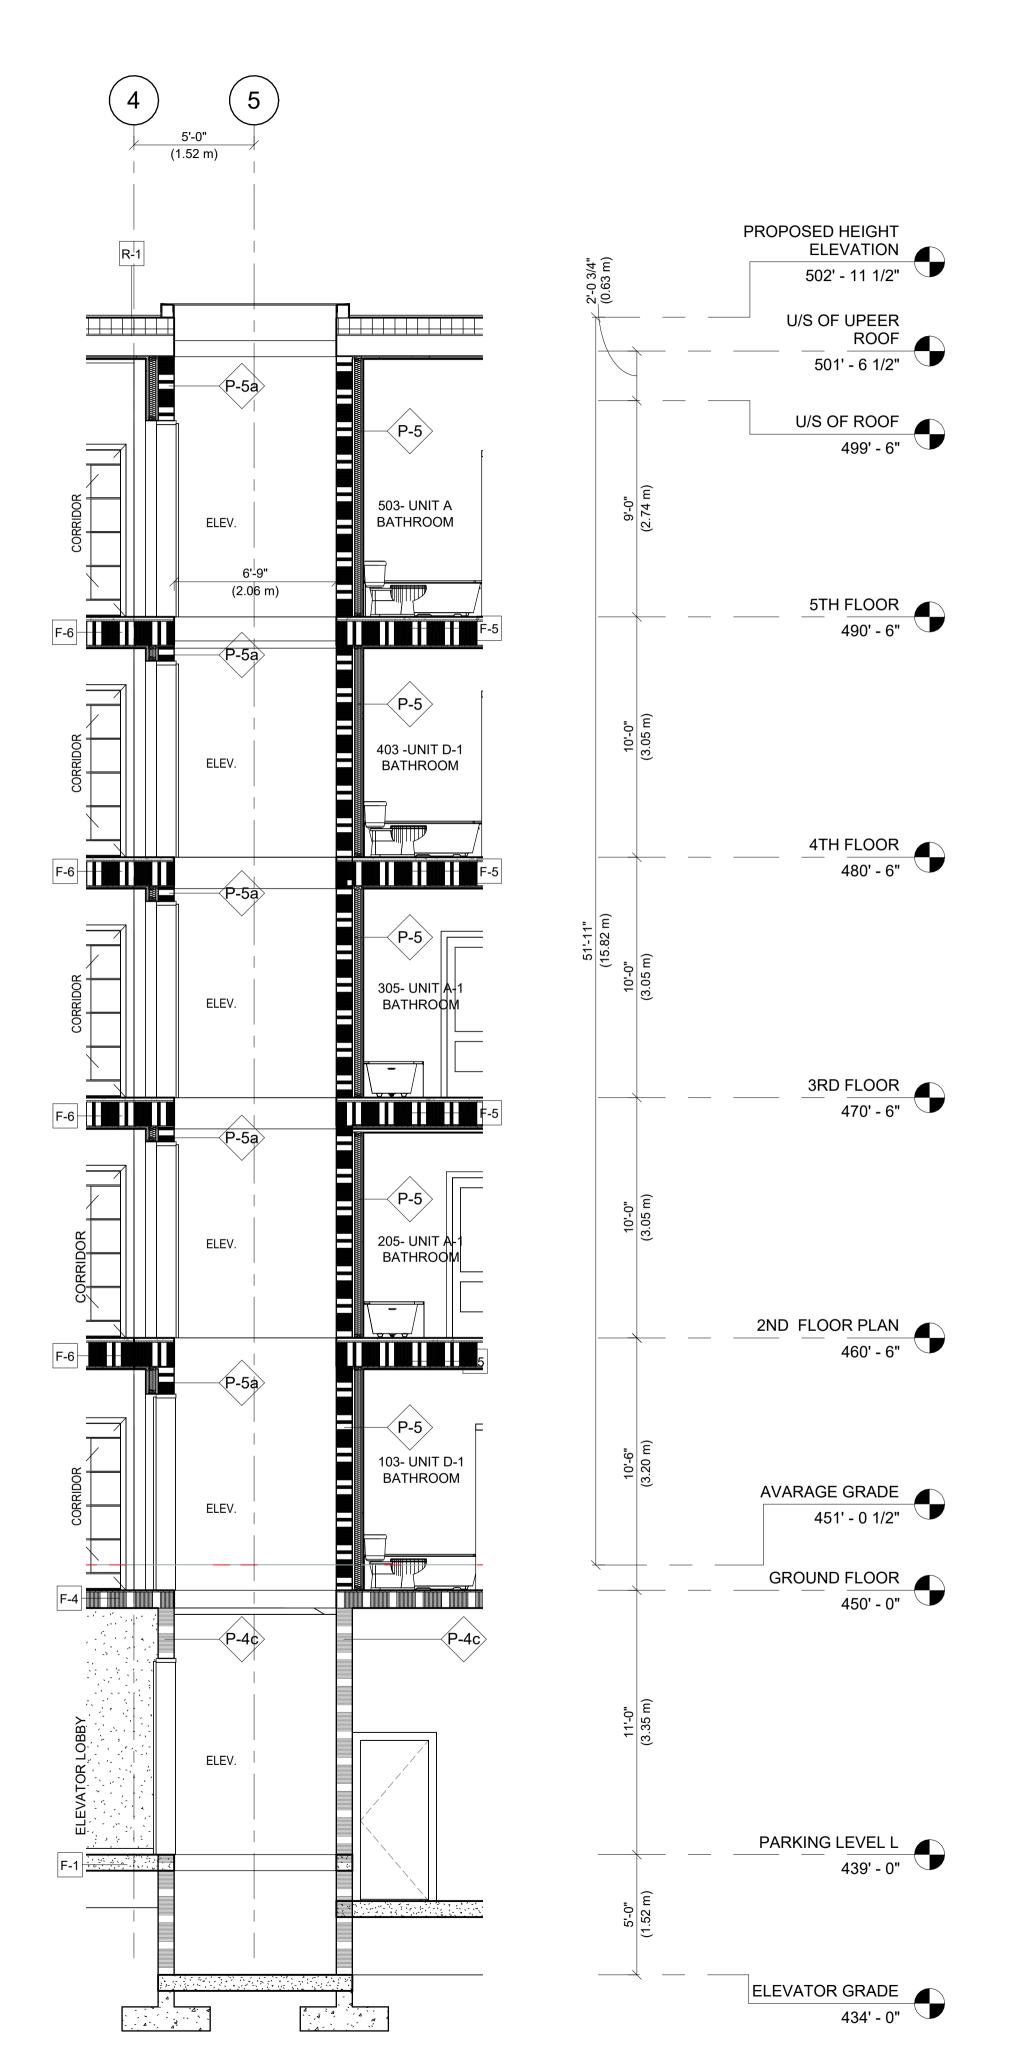

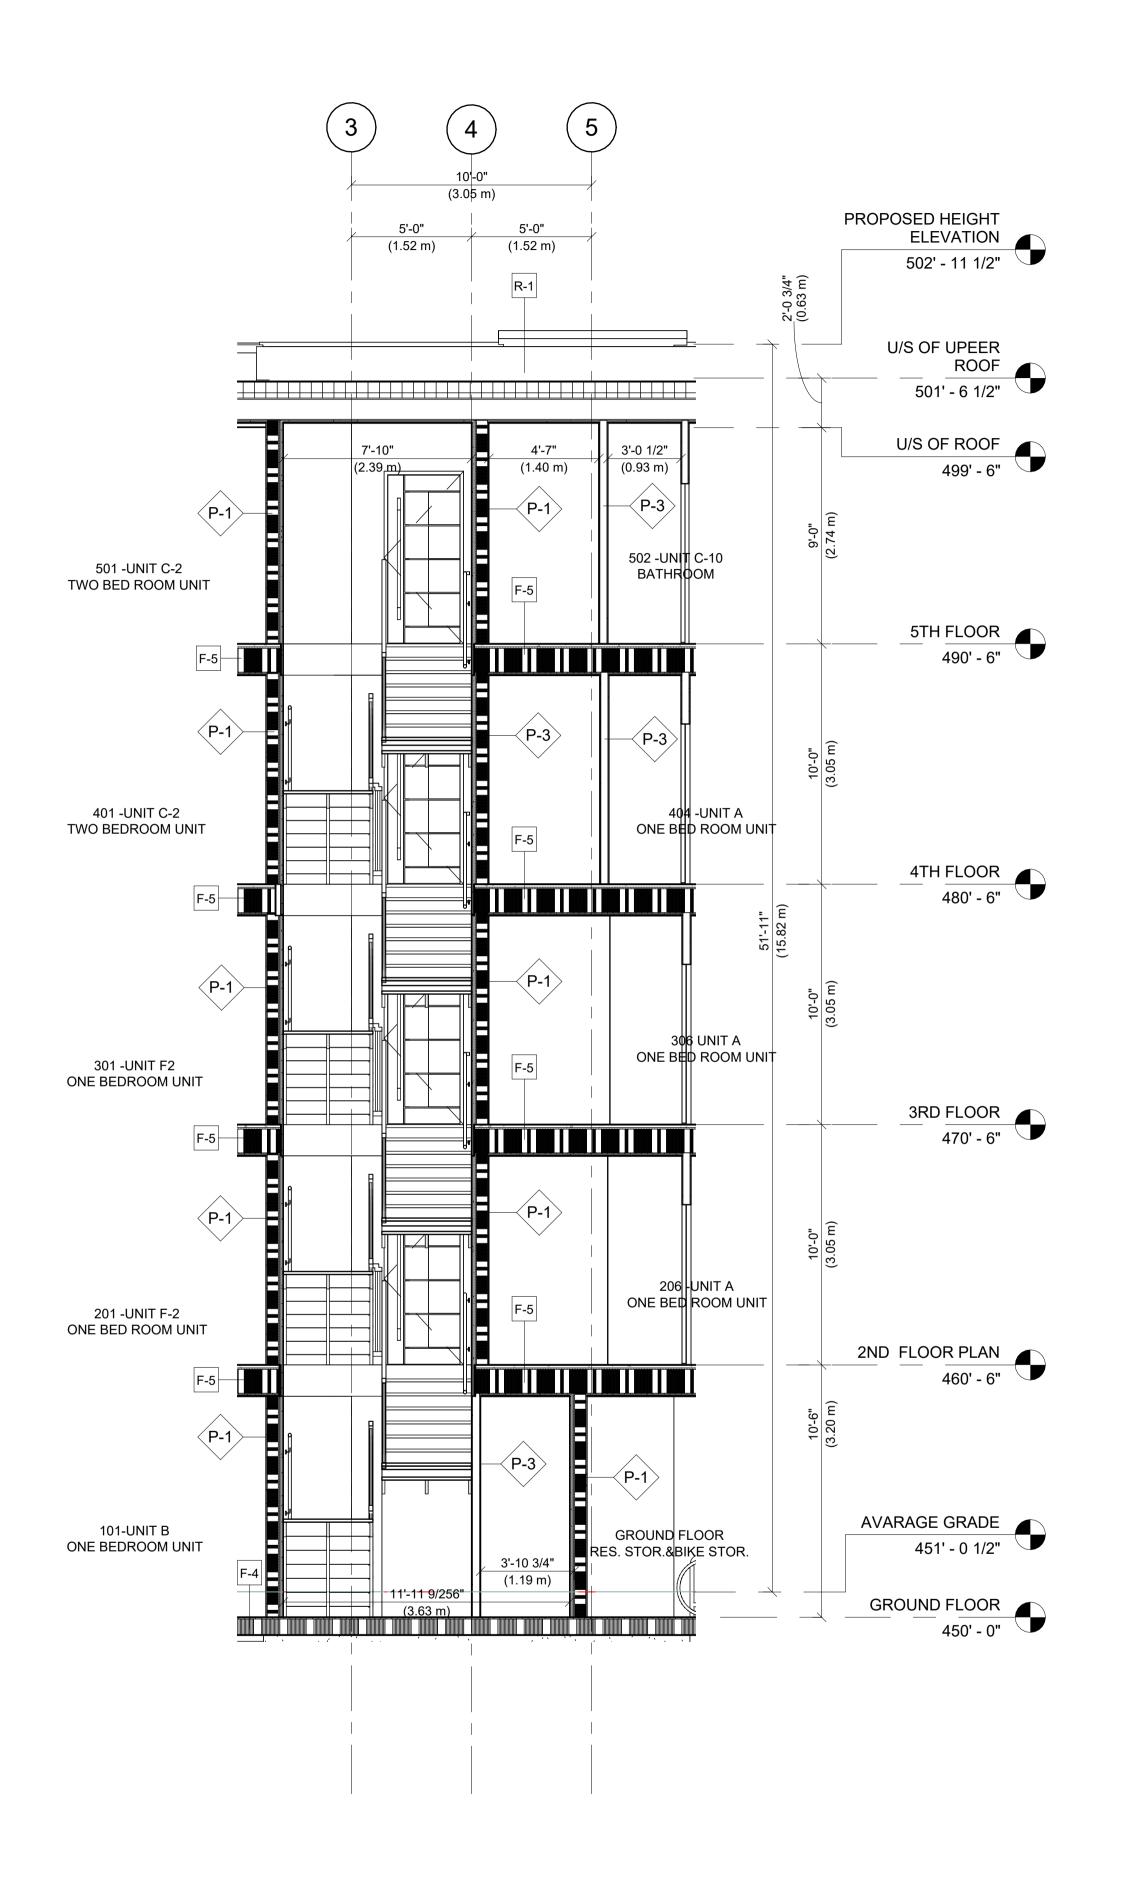

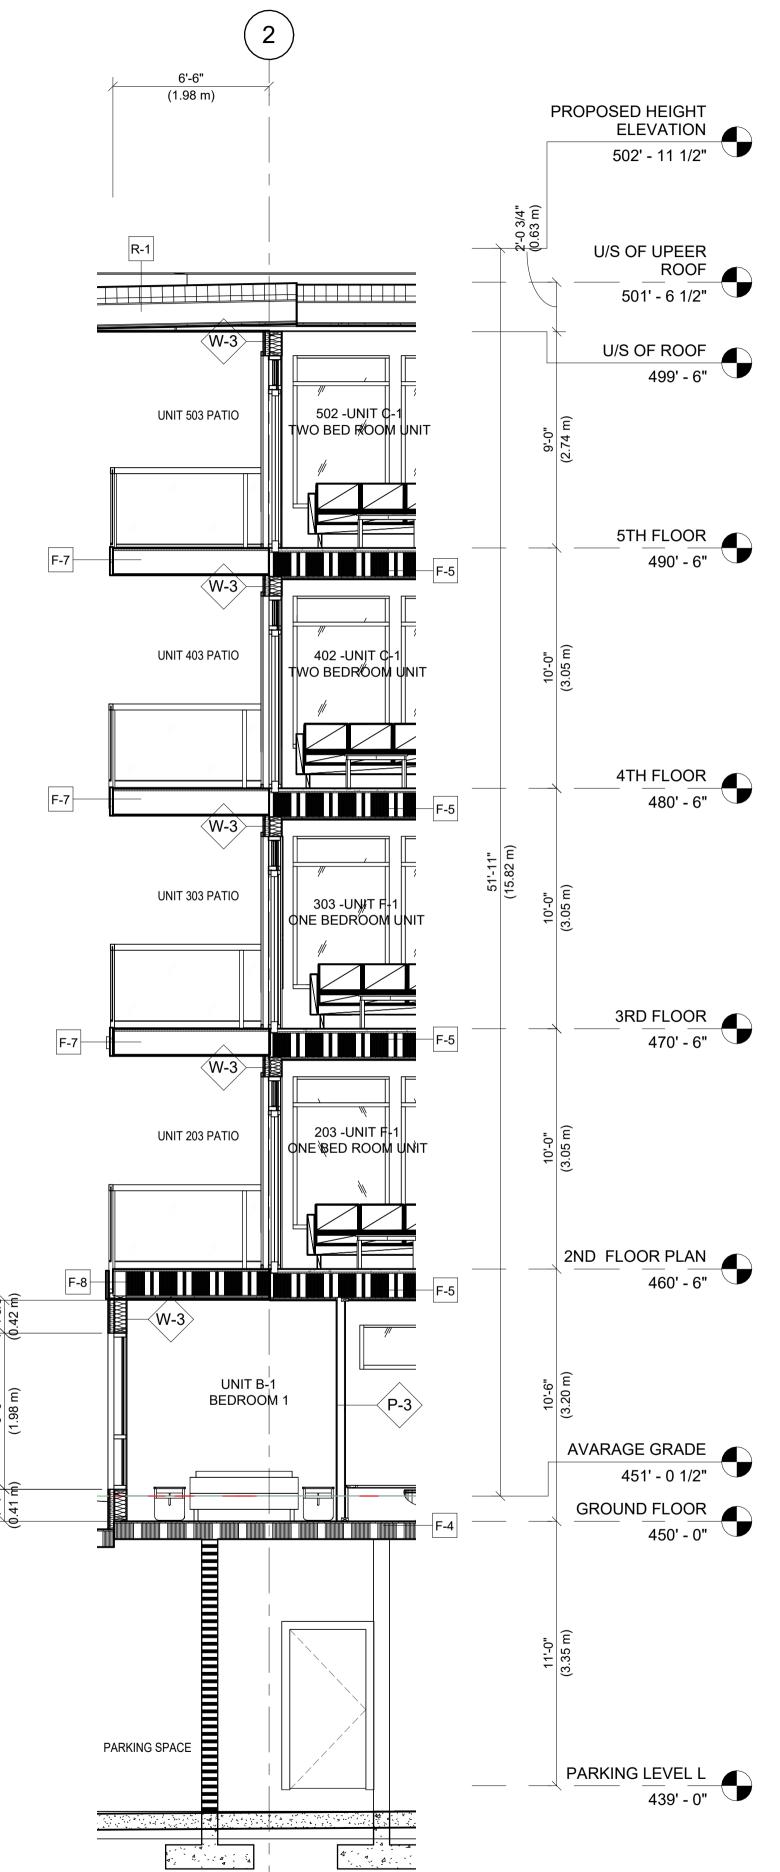

3 WALL SECTION @ DECK
1/4" = 1'-0"

All rights reserved. All ideas, designs, drawings and reproductions either in print or electronic format, are the property of MA ARCHITECTS Ltd., and are an instrument of service that may not be used, forwarded to others, transmitted, downloaded or reproduced either in print or electronic format, without the express written permission of the copyright owner.

Written dimensions shall have precedence over scaled dimensions. Contractors shall verify and be responsible for all dimensions and conditions on the job; shall request

2023/01/27 ISSUED FOR LEGAL DOC.

NO. DATE Y/M/D DESCRIPTION

ISSUES AND REVISIONS

2023/01/23 ISSUED FOR CONSULTANT

2023/01/19 ISSUED FOR CLIENT REVIEW

2023/01/10 ISSUED FOR CLIENT REVIEW

2022/12/09 ISSUED FOR CONSULT. USES

all dimensions and conditions on the job; shall request clarification of errors, discrepancies, or doubtful information contained in contract drawings and documents. Failure to obtain such clarification renders the Contractor responsible for any resulting improper work and the cost of rectification. This drawing shall not be used for construction purposes until it is issued for the purpose.

PROJECT NAME

COPYRIGHT NOTICE:

LONSDALE RESIDENTAL APARTMENT

PROJECT ADDRESS

2612 LONSDALE

2612 LONSDALE AVE, NORTH VANCOUVER

DRAWING TITLE

WALL SECTION

SCALE	1/4" = 1'-0"
DRAWN	AP
CHECKED	Checker
PROJECT NO.	22042


A03.20

THIS DRAWING IS PROPERTY OF MA ARCHITECTS LTD. AND SHOULD NOT BE COPIED OR DISTRIBUTED WITHOUT PRIOR WRITTEN CONSENT.


1 WALL SECTION@ ELEVATOR
1/4" = 1'-0"


WALL SECTTION@ STAIR

1/4" = 1'-0"

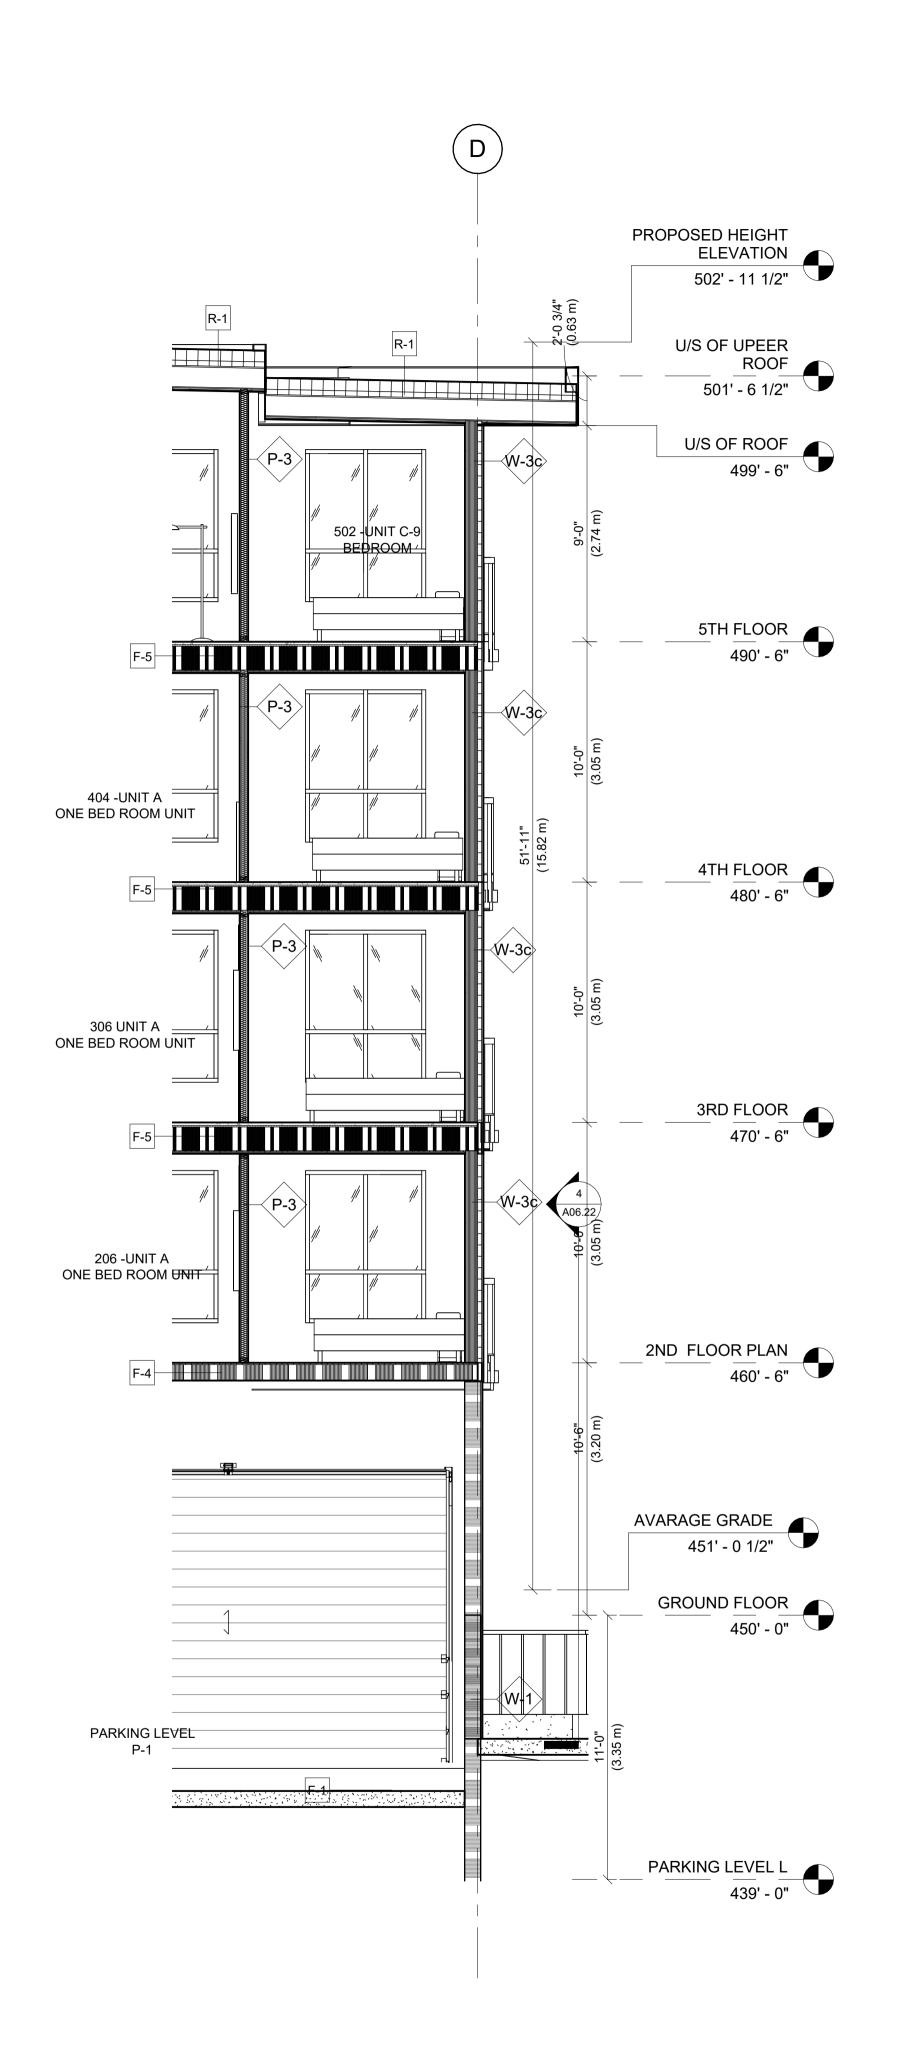

1 WALL SECTION@PARKING
1/4" = 1'-0"

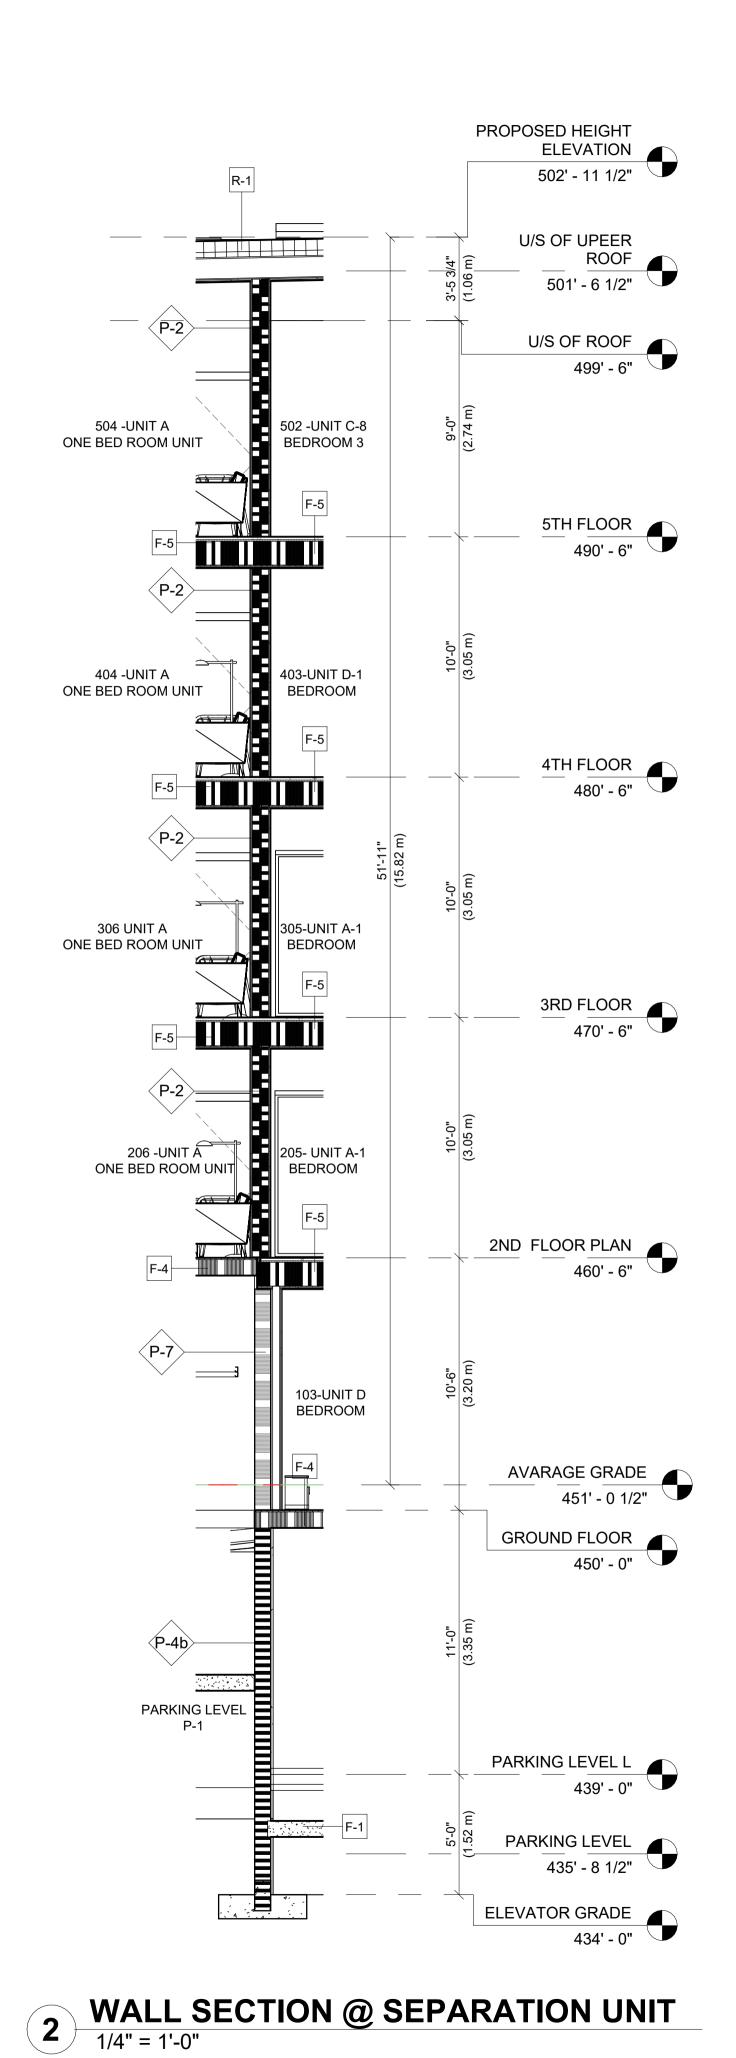

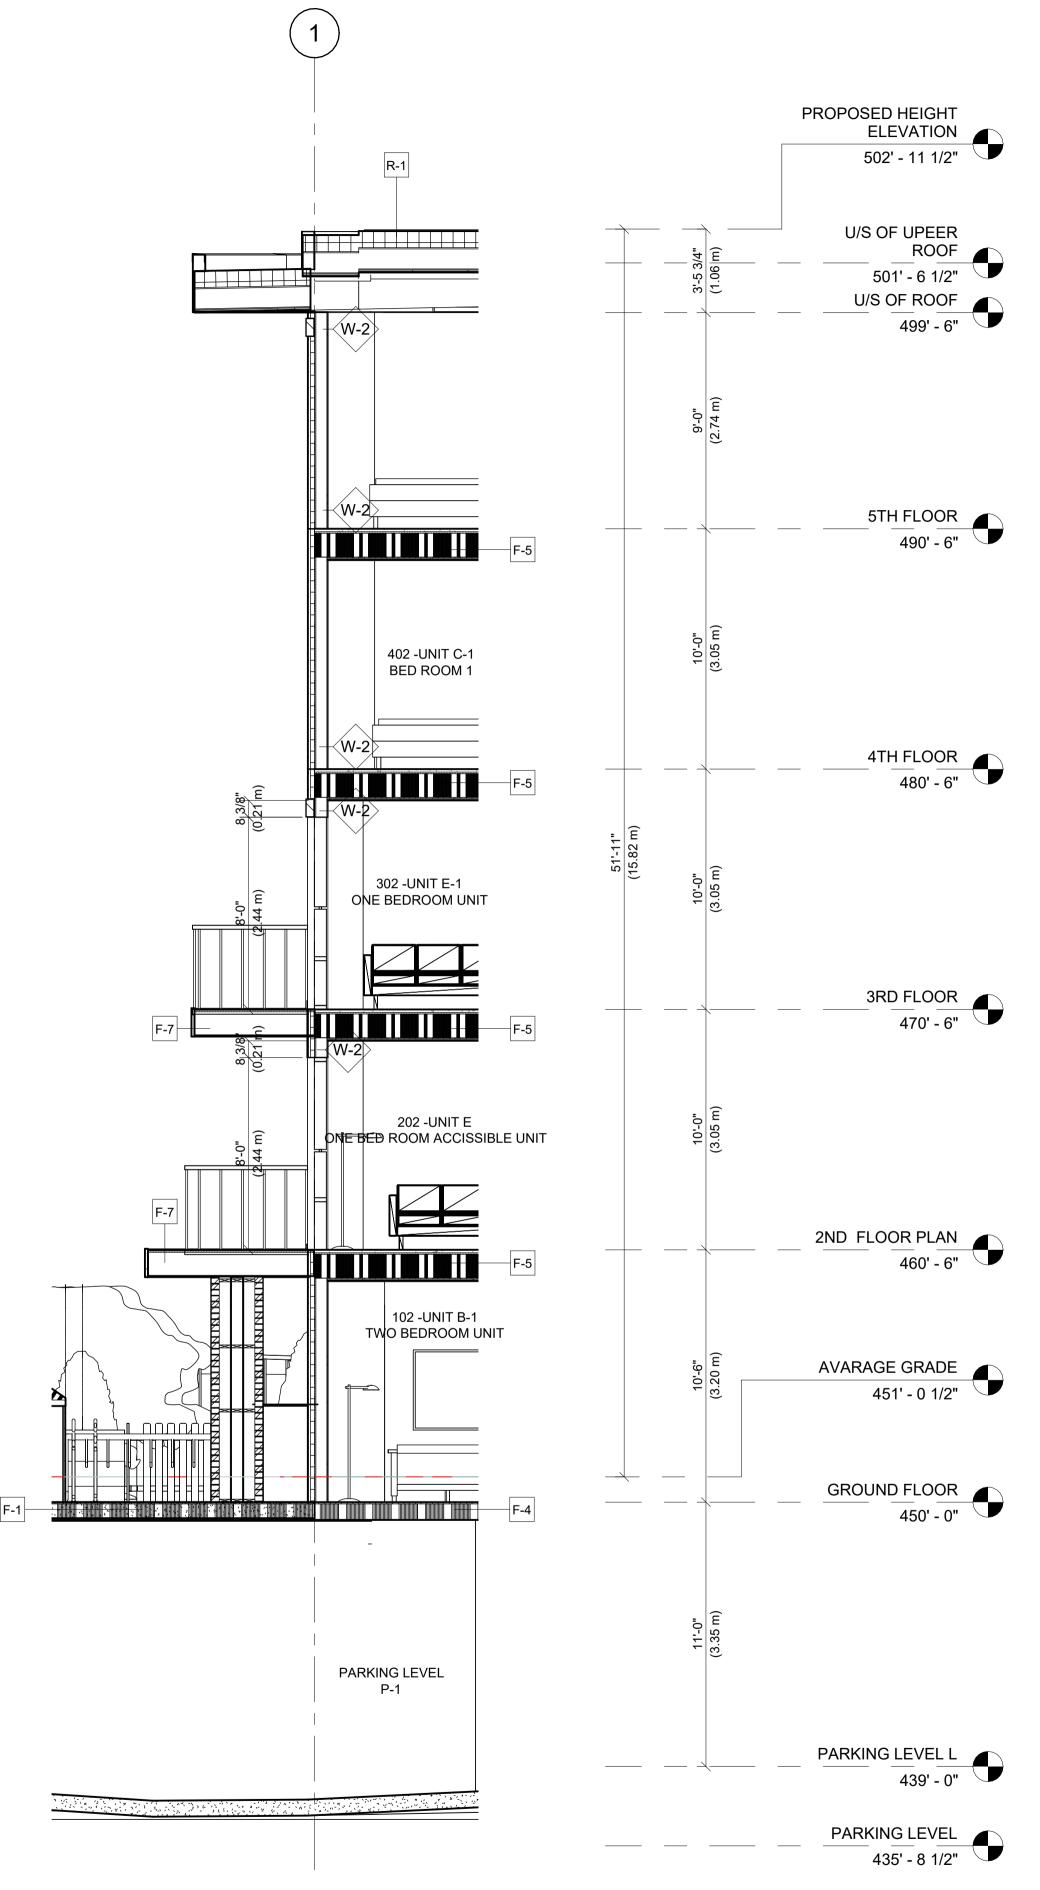

WALL SECTION @ BRICK VENEER WALL

1/4" = 1'-0"

MAARCHITECTS LTD.

OFFICE
2025 Willingdon Avenue #900, Burnaby, BC. V5C 0J3
OFFICE: +1 (778)-372-8650, +1 (778)-372-8651
CELL: +1 (604)-780-3243, +1 (604)-780-6461
EMAIL: INFO@M-AARCHITECTS.COM
WWW.M-AARCHITECTS.COM

COPYRIGHT NOTICE:
All rights reserved. All ideas, designs, drawings and reproductions either in print or electronic format, are the property of MA ARCHITECTS Ltd., and are an instrument of service that may not be used, forwarded to others, transmitted, downloaded or reproduced either in print or electronic format, without the express written permission of the copyright owner.

2023/01/23 ISSUED FOR CONSULTANT

NO. DATE Y/M/D DESCRIPTION

ISSUES AND REVISIONS

2023/01/19 ISSUED FOR CLIENT REVIEW
2023/01/10 ISSUED FOR CLIENT REVIEW
2022/12/09 ISSUED FOR CONSULT. USES

Written dimensions shall have precedence over scaled dimensions. Contractors shall verify and be responsible for all dimensions and conditions on the job; shall request clarification of errors, discrepancies, or doubtful information contained in contract drawings and documents. Failure to obtain such clarification renders the Contractor responsible for any resulting improper work and the cost of rectification. This drawing shall not be used for construction purposes until it is issued for the purpose.

PROJECT NAME

LONSDALE RESIDENTAL APARTMENT

PROJECT ADDRESS

2612 LONSDALE AV

2612 LONSDALE AVE, NORTH VANCOUVER

DRAWING TITLE

WALL SECTION

SCALE	1/4" = 1'-0"
DRAWN	AP
CHECKED	Checker
PROJECT NO.	22042

A03.21





OFFICE
2025 Willingdon Avenue #900, Burnaby, BC. V5C 0J3
OFFICE: +1 (778)-372-8650, +1 (778)-372-8651
CELL: +1 (604)-780-3243, +1 (604)-780-6461
EMAIL: INFO@M-AARCHITECTS.COM
WWW.M-AARCHITECTS.COM

EXTERIOR MATERIAL LEGEND

01	BRICK MISSION FINISH, COLOR: HARBOR MIST
02	FIBRE CEMENT PANEL SMOOTH, PAINTED, COLOR: BM-BLACK PANTHER 2125-10
03	ARCHITECTURAL FINISH CONCRETE
04	WOOD TONE SOFFIT
05	WOOD FASCIA/TRIM BOARD, PAINTED, COLOR: TO MATCH BM-BLACK PANTHER 2125-10
06	ANODIZED METAL PANEL FINISH
07	PRECAST CONCRETE WALL CAP AND SILL
08	VINYL FRAME WINDOW, COLOR: BLACK
09	ALUMINUM GUARDRAIL, COLOR: BLACK WITH CLEAR GLASS
10	ALUMINUM SCREENING, WOOD TONE FINISH.
12	ALUMINUM GUARDRAIL COLOR: BLACK
13	SOLDIER COURSE BRICK DETAIL
14	FIBRE CEMENT SIDING SMOOTH, PAINTED, COLOR: BM-CHANTILLY LACE 2121-70

5 2023/01/27 ISSUED FOR LEGAL DOC.
 4 2023/01/23 ISSUED FOR CONSULTANT
 3 2023/01/19 ISSUED FOR CLIENT REVIEW

2 2023/01/10 ISSUED FOR CLIENT REVIEW
1 2022/12/09 ISSUED FOR CONSULT. USES
NO. DATE Y/M/D DESCRIPTION

ISSUES AND REVISIONS
SEAL

COPYRIGHT NOTICE:
All rights reserved. All ideas, designs, drawings and reproductions either in print or electronic format, are the property of MA ARCHITECTS Ltd., and are an instrument of service that may not be used, forwarded to others, transmitted, downloaded or reproduced either in print or electronic format, without the express written permission of the copyright owner.

Written dimensions shall have precedence over scaled dimensions. Contractors shall verify and be responsible for all dimensions and conditions on the job; shall request clarification of errors, discrepancies, or doubtful information contained in contract drawings and documents. Failure to obtain such clarification renders the Contractor responsible for any resulting improper work and the cost of rectification. This drawing shall not be used for construction purposes until it is issued for the purpose.

PROJECT NAME

LONSDALE RESIDENTAL APARTMENT

PROJECT ADDRESS

2612 LONSDALE AVE, NORTH VANCOUVER

DRAWING TITLE

ELEVATION

SCALE	As indicated
DRAWN	SH
CHECKED	AP
PROJECT NO.	22042

DRAWING NO.

A04.10





2025 Willingdon Avenue #900, Burnaby, BC. V5C 0J3
OFFICE: +1 (778)-372-8650, +1 (778)-372-8651
CELL: +1 (604)-780-3243, +1 (604)-780-6461
EMAIL: INFO@M-AARCHITECTS.COM
WWW.M-AARCHITECTS.COM

EXTERIOR MATERIAL LEGEND

01	BRICK MISSION FINISH
	COLOR: HARBOR MIST
02	FIBRE CEMENT PANEL
	SMOOTH, PAINTED,
	COLOR: BM-BLACK
	PANTHER 2125-10
03	ARCHITECTURAL FINIS
	CONCRETE
04	WOOD TONE SOFFIT
05	WOOD FASCIA/TRIM
	BOARD, PAINTED,
	COLOR: TO MATCH BM-BLACK PANTHER
	2125-10
06	ANODIZED METAL PAI
00	FINISH
07	PRECAST CONCRETE
0.	WALL CAP AND SILL
08	VINYL FRAME WINDOV
	COLOR: BLACK
09	ALUMINUM GUARDRAI
	COLOR: BLACK WITH
	CLEAR GLASS
10	ALUMINUM SCREENIN
	WOOD TONE FINISH.
12	ALUMINUM GUARDRAI
	COLOR: BLACK
13	SOLDIER COURSE BRI
	DETAIL
14	FIBRE CEMENT SIDING
	SMOOTH, PAINTED,
	COLOR: BM-CHANTILL LACE 2121-70
	LAGE 2121-70

5 2023/01/27 ISSUED FOR LEGAL DOC. 4 2023/01/23 ISSUED FOR CONSULTANT 2023/01/19 ISSUED FOR CLIENT REVIEW

2023/01/10 ISSUED FOR CLIENT REVIEW 1 2022/12/09 ISSUED FOR CONSULT. USES NO. DATE Y/M/D DESCRIPTION

ISSUES AND REVISIONS

SEAL

COPYRIGHT NOTICE: All rights reserved. All ideas, designs, drawings and reproductions either in print or electronic format, are the property of MA ARCHITECTS Ltd., and are an instrument of service that may not be used, forwarded to others, transmitted, downloaded or reproduced either in print or electronic format, without the express written

Written dimensions shall have precedence over scaled dimensions. Contractors shall verify and be responsible for all dimensions and conditions on the job; shall request clarification of errors, discrepancies, or doubtful information contained in contract drawings and documents. Failure to obtain such clarification renders the Contractor responsible for any resulting improper work and the cost of rectification.
This drawing shall not be used for construction purposes until it is issued for the purpose.

PROJECT NAME

LONSDALE RESIDENTAL **APARTMENT**

permission of the copyright owner.

PROJECT ADDRESS

2612 LONSDALE AVE, NORTH VANCOUVER

DRAWING TITLE

ELEVATION

	SCALE	1:100
	DRAWN	SH
	CHECKED	AP
	PROJECT NO.	22042

DRAWING NO.

A04.11