M3 TOWNHOMES-WEST

Issued for Development Permit

CREO DEVELOPMENT LTD. // CLIENT

BEN FISHER ben@creodevelopments.ca 778.938.6227

SHAPE ARCHITECTURE // ARCHITECT

Dwayne Smyth d.smyth@shapearchitecture.ca 604.312.8258

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LOCI LANDSCAPE ARCHITECTURE + URBAN DESIGN // LANDSCAPE ARCHITECT

Mike Enns, BCSLA CSLA // Principal mike@locidesign.ca 604.763.2886

Chloé Brown // Project Coordinator chloe@locidesign.ca 519.288.1153

LANDSCAPE DRAWING INDEX PERMIT

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L0.1	TREE MANAGEMENT PLAN
L0.2	OVERALL LANDSCAPE PLAN
L1.0	MATERIALS + LAYOUT PLAN - LEVEL 1
L1.1	MATERIALS + LAYOUT PLAN - LEVEL 2
L1.2	MATERIALS + LAYOUT PLAN - UPPER LEVELS
L2.0	GRADING + SOIL DEPTH PLAN - LEVEL 1 + 2
L2.1	GRADING + SOIL DEPTH PLAN - UPPER LEVELS
L3.0	PLANTING PLAN - LEVEL 1 + 2
L3.1	PLANTING PLAN - UPPER LEVELS
L4.0	LIGHTING PLAN - LEVEL 1
L5.0	PLANT LIST + IMAGES
L6.0	LANDSCAPE SECTIONS
L6.1	LANDSCAPE SECTIONS
L7.0	DETAILS
L7.1	DETAILS
L8.0	PRECEDENT IMAGES

GENERAL NOTES

- 1. ALL PLANTING SHALL BE IN ACCORDANCE WITH BC LANDSCAPE STANDARD, LATEST EDITION.
- 2. ALL PLANTING AREAS TO RECEIVE AUTOMATIC DRIP IRRIGATION, WITH TIME CLOCK AND RAIN SENSOR
- 3. ALL LANDSCAPE ARCHITECTURAL DRAWINGS IN THIS PACKAGE SHALL BE READ IN CONJUNCTION WITH ALL OTHER CONSULTANT DRAWINGS, DETAILS, SPECIFICATIONS, AND ANY OTHER CORRESPONDENCE THAT MAY BE ISSUED DURING THE COURSE OF THE CONTRACT.
- 4. IF A DISCREPANCY OCCURS BETWEEN THE DRAWINGS AND THE SPECIFICATIONS OR ANY OTHER DOCUMENT ASSOCIATED WITH THE PROJECT, THE CONFLICT SHALL BE REPORTED IN WRITING TO THE LANDSCAPE ARCHITECT TO OBTAIN CLARIFICATION AND APPROVAL BEFORE PROCEEDING WITH WORKS.
- ALL EXISTING INFORMATION IS BASED ON AVAILABLE RECORDS AND SHALL NOT BE CONSTRUED TO BE COMPLETE OR ACCURATE.
- 6. THE CONTRACTOR SHALL VISIT THE SITE TO VERIFY THE TRUE EXISTING CONDITIONS. ANY UNCLEAR ISSUES SHALL BE CLARIFIED WITH THE CONSULTANT TEAM. NO CLAIM SHALL BE ALLOWED FOR EXTRAS WHICH MAY ARISE THROUGH NEGLECT OF THIS ADVICE.
- 7. THE CONTRACTOR IS RESPONSIBLE FOR DETERMINING THE EXISTENCE, LOCATION, AND ELEVATION OF ALL UTILITIES AND CONCEALED STRUCTURES, AND IS RESPONSIBLE FOR NOTIFYING THE APPROPRIATE COMPANY, DEPARTMENT OR PERSON(S) OF ITS INTENTION TO CARRY OUT ITS OPERATIONS.
- 8. LAYOUT OF PAVING, WALLS, SITE FURNITURE, SOIL, PLANTING, AND ALL OTHER LANDSCAPE MATERIALS IS TO BE STAKED OUT AND APPROVED BY THE LANDSCAPE ARCHITECT PRIOR TO INSTALLATION.
- 9. ALL DIMENSIONS AND ELEVATIONS ARE IN FEET UNLESS OTHERWISE NOTED.
 VERIFY ALL ELEVATIONS WITH FIELD CONDITIONS. REPORT ANY DISCREPANCIES
 TO CONSULTANT TEAM FOR REVIEW AND RESPONSE.
- 10. ALL UTILITIES TO BE STAKED OUT BY CONTRACTOR AND PROTECTED FOR DURATION OF CONSTRUCTION PERIOD.
- 11. PROTECT ALL EXISTING STRUCTURES
- 12. ALL SUBSTITUTIONS OF SPECIFIED MATERIALS TO BE APPROVED BY LANDSCAPE ARCHITECT.
- 13. FINAL PLANT SPACING, QUANTITY AND TREE PLACEMENT HAS BEEN REVIEWED TO THE SATISFACTION OF GENERAL MANAGER OF ENGINEERING SERVICES.
- 14. ALL WORKS ON CITY OF VANCOUVER PROPERTY TO BE AS PER THE CITY OF VANCOUVER STREET RESTORATION MANUAL.
- 15. LOCI LANDSCAPE ARCHITECTURE + URBAN DESIGN DOES NOT GUARANTEE THE EXISTENCE, LOCATION, AND ELEVATION OF UTILITIES OR CONCEALED STRUCTURES AT THE PROJECT SITE.

GENERAL TREE PROTECTION FENCING TYP NOTES:

- 1. ALL COMPONENTS AND WORKMANSHIP TO CONFORM TO BCLNA STANDARDS TYPICAL.
- 2. POSITION TREE STAKES INTO DIRECTION OF PREVAILING WINDS IF MINIMUM UTILITY SETBACKS PERMIT.
- 3. ALL TREE STAKES TO HAVE A MINIMUM 1.0m CLEARANCE FROM ALL U/G POWER, TELEPHONE AND GAS ALIGNMENTS.
- 4. ALL ROOTBALL HOLES TO BE DUG BY HAND WHEN CLOSER TO 1.0M (40") TO U/G POWER, TELEPHONE AND GAS ALIGNMENTS. FOR TREES WITH DRIPLINES FROM FROM 3M 5M (9' 15') FROM CONSTRUCTION ACTIVITY;
- 5. PLACE STANDARD 'SAFETY ORANGE' SNOWFENCE MIN. OF 4.5M (14'8") FROM TREE TRUNK. EXACT SIZE/SHAPE TO BE DETERMINED ON SITE
- 6. FOR EXCAVATION WITHIN 1-3M (3' 9') OF ANY TREE'S DRIPLINE, ROOT PRUNING REQUIRED TO A DEPTH OF 500MM (20"). IMMEDIATELY AFTER EXCAVATION, PRUNE ALL EXPOSED ROOTS FLUSH WITH THE EXCAVATION WALL.
- 7. A MAXIMUM OF 25% OF ANY TREE'S ROOTS AT THE DRIPLINE SHOULD BE IMPACTED BY EXCAVATION IF THE TREE IS EXPECTED TO SURVIVE.
- 8. INSTALL AND MAINTAIN HOARDING IN CLEAN AND SAFE CONDITION THROUGHOUT CONSTRUCTION PROCESS.
- 9. HOARDING REQUIREMENTS ARE ON ALL EXISTING TREES THROUGHOUT CONSTRUCTION. ALL EQUIPMENT, SOIL, BUILDING MATERIAL AND OTHER DEBRIS SHALL BE KEPT OUTSIDE THE HOARDING.
- 10. IF HOARDING IS PUNCTURED AND DAMAGE OCCURS TO HOARDED TREE(S), NOTIFY LANDSCAPE ARCHITECT.
- 11. THE BEST METHOD TO AVOID SOIL COMPACTION IS TO KEEP OFF. THIS INCLUDES RESTRICTING ALL TRAFFIC BOTH VEHICULAR AND PEDESTRIAN FROM CROSSING OVER THE ROOT ZONES, AND RESTRICTING EVEN TEMPORARY MATERIAL STORAGE UNDER TREES.
- 12.EXCAVATION AROUND TREES WITHIN DRIP LINE OF TREES ONLY WHERE INDICATED ON PLANS AND AS DIRECTED BY THE CONSULTANT.
- 13. DURING ANY EXCAVATION WITHIN THE DRIP LINE OF A TREE THE CONTRACTOR SHALL EXCAVATE AROUND TREE ROOTS AS DIRECTED BY THE CONSULTANT. DO NOT CUT TREE ROOTS UNLESS DIRECTED BY THE CONSULTANT.



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Project Stamp



22-01-24

No. Description

A ISSUED FOR SCHEMATIC

B ISSUED FOR DEVELOPMENT

Project Info

22052

M3 Townhomes

Project Team

North Vancouver

Creo Developments

Architect
Shape Architecture

Landscape Architect

LOCI Landscape Architecture + Urban Design

Checked By

vn By

COVER SHEET

Drawn By

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. A revision

GENERAL TREE PROTECTION FENCING TYP NOTES:

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- 4. ALL ROOTBALL HOLES TO BE DUG BY HAND WHEN CLOSER TO 1.0M (40") TO U/G POWER, TELEPHONE AND GAS ALIGNMENTS. FOR TREES WITH DRIPLINES FROM FROM 3M - 5M (9' - 15') FROM CONSTRUCTION ACTIVITY;
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- 14. TREES AND OTHER DESIRABLE VEGETATION TO BE TOTALLY FENCED. FENCING TO BE MAINTAINED FOR THE DURATION OF THE PROJECT.
- 15. EXCAVATION FOR NEW CONSTRUCTION WITHIN THE DRIP LINES OF TREES: HAND EXCAVATE TO MINIMIZE DAMAGE TO ROOT SYSTEMS
- 16. USE NARROW TINE SPADING FORKS TO PROBE AND COMB SOIL TO EXPOSE ROOTS;
- 17. RELOCATE ROOTS INTO BACKFILL AREAS WHENEVER POSSIBLE. IF LARGE MAIN LATERAL ROOTS ARE ENCOUNTERED, EXPOSE BEYOND EXCAVATION LIMITS AS REQUIRED TO BEND AND RELOCATE WITHOUT BREAKING.
- 18. UTILITY TRENCHING WITHIN THE DRIP LINES OF TREES: TUNNEL UNDER AND AROUND ROOTS BY HAND DIGGING:
- 19. DO NOT CUT MAIN LATERAL ROOTS;
- 20.CUTTING OF SMALLER ROOTS THAT INTERFERE WITH INSTALLATION OF NEW WORK SHALL BE DONE WITH CLEAN SHARP TREE PRUNING TOOLS;
- 21. ROOTS THAT ARE ENCOUNTERED IMMEDIATELY ADJACENT TO THE LOCATION OF NEW CONSTRUCTION AND ARE TOO DIFFICULT TO RELOCATE SHALL BE CUT 150MM (6") BACK FROM NEW CONSTRUCTION. USE CLEAN SHARP TREE PRUNING TOOLS;
- 22.PROTECTION OF EXPOSED ROOTS: DO NOT ALLOW EXPOSED ROOTS TO DRY OUT PRIOR TO PLACEMENT OF PERMANENT COVER.
- 23. PROVIDE ONE OF THE FOLLOWING TEMPORARY REMEDIAL MEASURES:
- 24.A. PROVIDE TEMPORARY EARTH COVER. MAINTAIN MOISTURE.
- B. PACK WITH WET PEAT MOSS . MAINTAIN MOISTURE. C . PACK WITH FOUR LAYERS OF WET UNTREATED BURLAP. MAINTAIN MOISTURE.
- 25.TEMPORARILY SUPPORT AND PROTECT EXPOSED ROOTS FROM DAMAGE UNTIL PERMANENTLY RELOCATED AND COVERED WITH BACKFILL.
- 26.WATER PUDDLE BACKFILL AROUND ROOTS TO ELIMINATE VOIDS AND AIR POCKETS
- 27. REMOVAL OF STREET TREES TO THE SATISFACTION OF THE GENERAL MANAGER OF ENGINEERING SERVICES.

TREE MANAGEMENT PLAN - REFER TO ARBORIST REPORT SYMBOL DESCRIPTION REMOVE WITH CONSENT **REMOVE**



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Project Stamp

No. Description

DESIGN

Project Info

M3 Townhomes

North Vancouver

Project Team

Architect

Drawn By

Drawn By

Creo Developments

Shape Architecture

Landscape Architect

Rev. A revision

LOCI Landscape Architecture + Urban Design

TREE MANAGEMENT PLAN

Checked By

Checked

22052

A ISSUED FOR SCHEMATIC

B ISSUED FOR DEVELOPMENT

MICHAEL N. EN

22-01-24

22-02-25

LANDSCAPE DESIGN RATIONALE

THE LANDSCAPE CONCEPT FOR THE SITE WILL FOCUS ON THREE CORE STRATEGIES FOR DESIGN: TO CREATE A SPACE FOR RESIDENTS TO SOCIALIZE AND ENGAGE WITH EACH OTHER; TO DRAW INSPIRATION FROM NEIGHBOURING BUILDS AND ECOSYSTEMS, EMPHASIZING NATURALIZED LANDSCAPES AS WELL AS RAINWATER MANAGEMENT; AND TO UTILIZE A MATERIALS PALETTE THAT REFLECTS THE SITE'S NORTH SHORE THEMATICS.

KEY LEGEND

- A RIDGEWAY ENTRY
- 1 MAIN ENTRY WITH MIXED FEATURE PLANTING, WALLS + STAIRS
- 2 FEATURE PLANTING BUFFER
- B CENTRAL MEWS + PRIVATE AMENITY
- MAIN WALKWAY; PRE-CAST UNIT PAVERS
- 4 FOUNDATION PLANTERS FOR PRIVACY SCREENING AND TREES
- 5 "THE LOUNGE" OUTDOOR AMMENITY AREA
- C LAN
- 6 FOUNDATION PLANTING + TREES ALONG LANE
- EAST 2ND AVE
- PRIVATE PATIOS + PLANTERS FOR PRIVACY SCREENING
- 8 RAINGARDEN
- 9 SODDED BLVD + STREET TREES





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No.	Description	Dat
А	ISSUED FOR SCHEMATIC DESIGN	22-01-2
В	ISSUED FOR DEVELOPMENT PERMIT	22-02-2

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OVERALL LANDSCAPE


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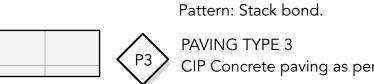
Rev. A revision

PLAN

GENERAL LAYOUT + MATERIALS NOTES:

- 1. ALL DIMENSIONS ARE METRIC UNLESS OTHERWISE NOTED. VERIFY ALL DIMENSIONS WITH FIELD CONDITIONS. REPORT ANY DISCREPANCIES TO LANDSCAPE ARCHITECT FOR REVIEW AND RESPONSE.
- 2. ALL UTILITIES TO BE STAKED OUT BY CONTRACTOR AND PROTECTED FOR DURATION OF CONSTRUCTION PERIOD.
- 3. UNLESS OTHERWISE NOTED, PROVIDE A MINIMUM 2% SLOPE ON ALL HARD AND SOFT LANDSCAPE AREAS TO ENSURE POSITIVE DRAINAGE AWAY FROM BUILDINGS OR TO DRAINAGE STRUCTURES. MAXIMUM 3:1 SLOPE IN SOFT LANDSCAPE AREAS.
- 4. THE LAYOUT OF ALL HARDSCAPE ITEMS, SITE FURNISHINGS, BOULDERS, LANDSCAPE LIGHTING, PLANTING BEDS AND OTHER MATERIALS IS TO BE STAKED OUT BY THE CONTRACTOR AND APPROVED BY THE LANDSCAPE ARCHITECT PRIOR TO INSTALLATION.
- 5. ALL SUBSTITUTIONS OF SPECIFIED MATERIALS TO BE APPROVED BY LANDSCAPE



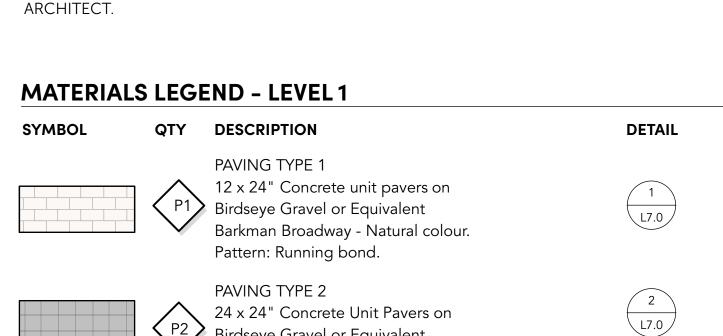

CIP Concrete paving as per CNV standards.

Texada series by Abbotsford - Charcoal.



L7.0

3 L7.1

1 L6.1

- See structural for reinforcement.

Birdseye Gravel or Equivalent

Thermally Modified Wood Decking. CONCRETE STAIRCASE

CIP Concrete Staircase with handrail - See Arch.

L1 BOULEVARD LAWN PLANTING IN-GROUND PLANTED AREA 24"-36"soil depth for trees and shrubs.

> RAISED METAL PLANTER 24"-36"soil depth for trees and shrubs.

THERMALLY MODIFIED WOOD BENCHES 4-6' Length Maglin Odgen series, Straight, Backless Benches

OUTDOOR FURNITURE By Owner.

CONCRETE ARCHITECTURAL WALL See Arch.



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MATERIALS + LAYOUT

PLAN - LEVEL 1

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Checked By

Checked

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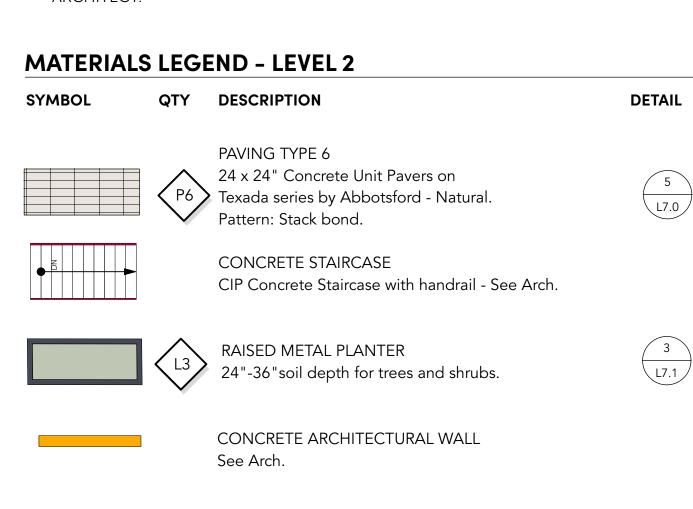
MICHAEL N. ENN


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GENERAL LAYOUT + MATERIALS NOTES:

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- 3. UNLESS OTHERWISE NOTED, PROVIDE A MINIMUM 2% SLOPE ON ALL HARD AND SOFT LANDSCAPE AREAS TO ENSURE POSITIVE DRAINAGE AWAY FROM BUILDINGS OR TO DRAINAGE STRUCTURES. MAXIMUM 3:1 SLOPE IN SOFT LANDSCAPE AREAS.
- 4. THE LAYOUT OF ALL HARDSCAPE ITEMS, SITE FURNISHINGS, BOULDERS, LANDSCAPE LIGHTING, PLANTING BEDS AND OTHER MATERIALS IS TO BE STAKED OUT BY THE CONTRACTOR AND APPROVED BY THE LANDSCAPE ARCHITECT PRIOR TO INSTALLATION.
- 5. ALL SUBSTITUTIONS OF SPECIFIED MATERIALS TO BE APPROVED BY LANDSCAPE ARCHITECT.





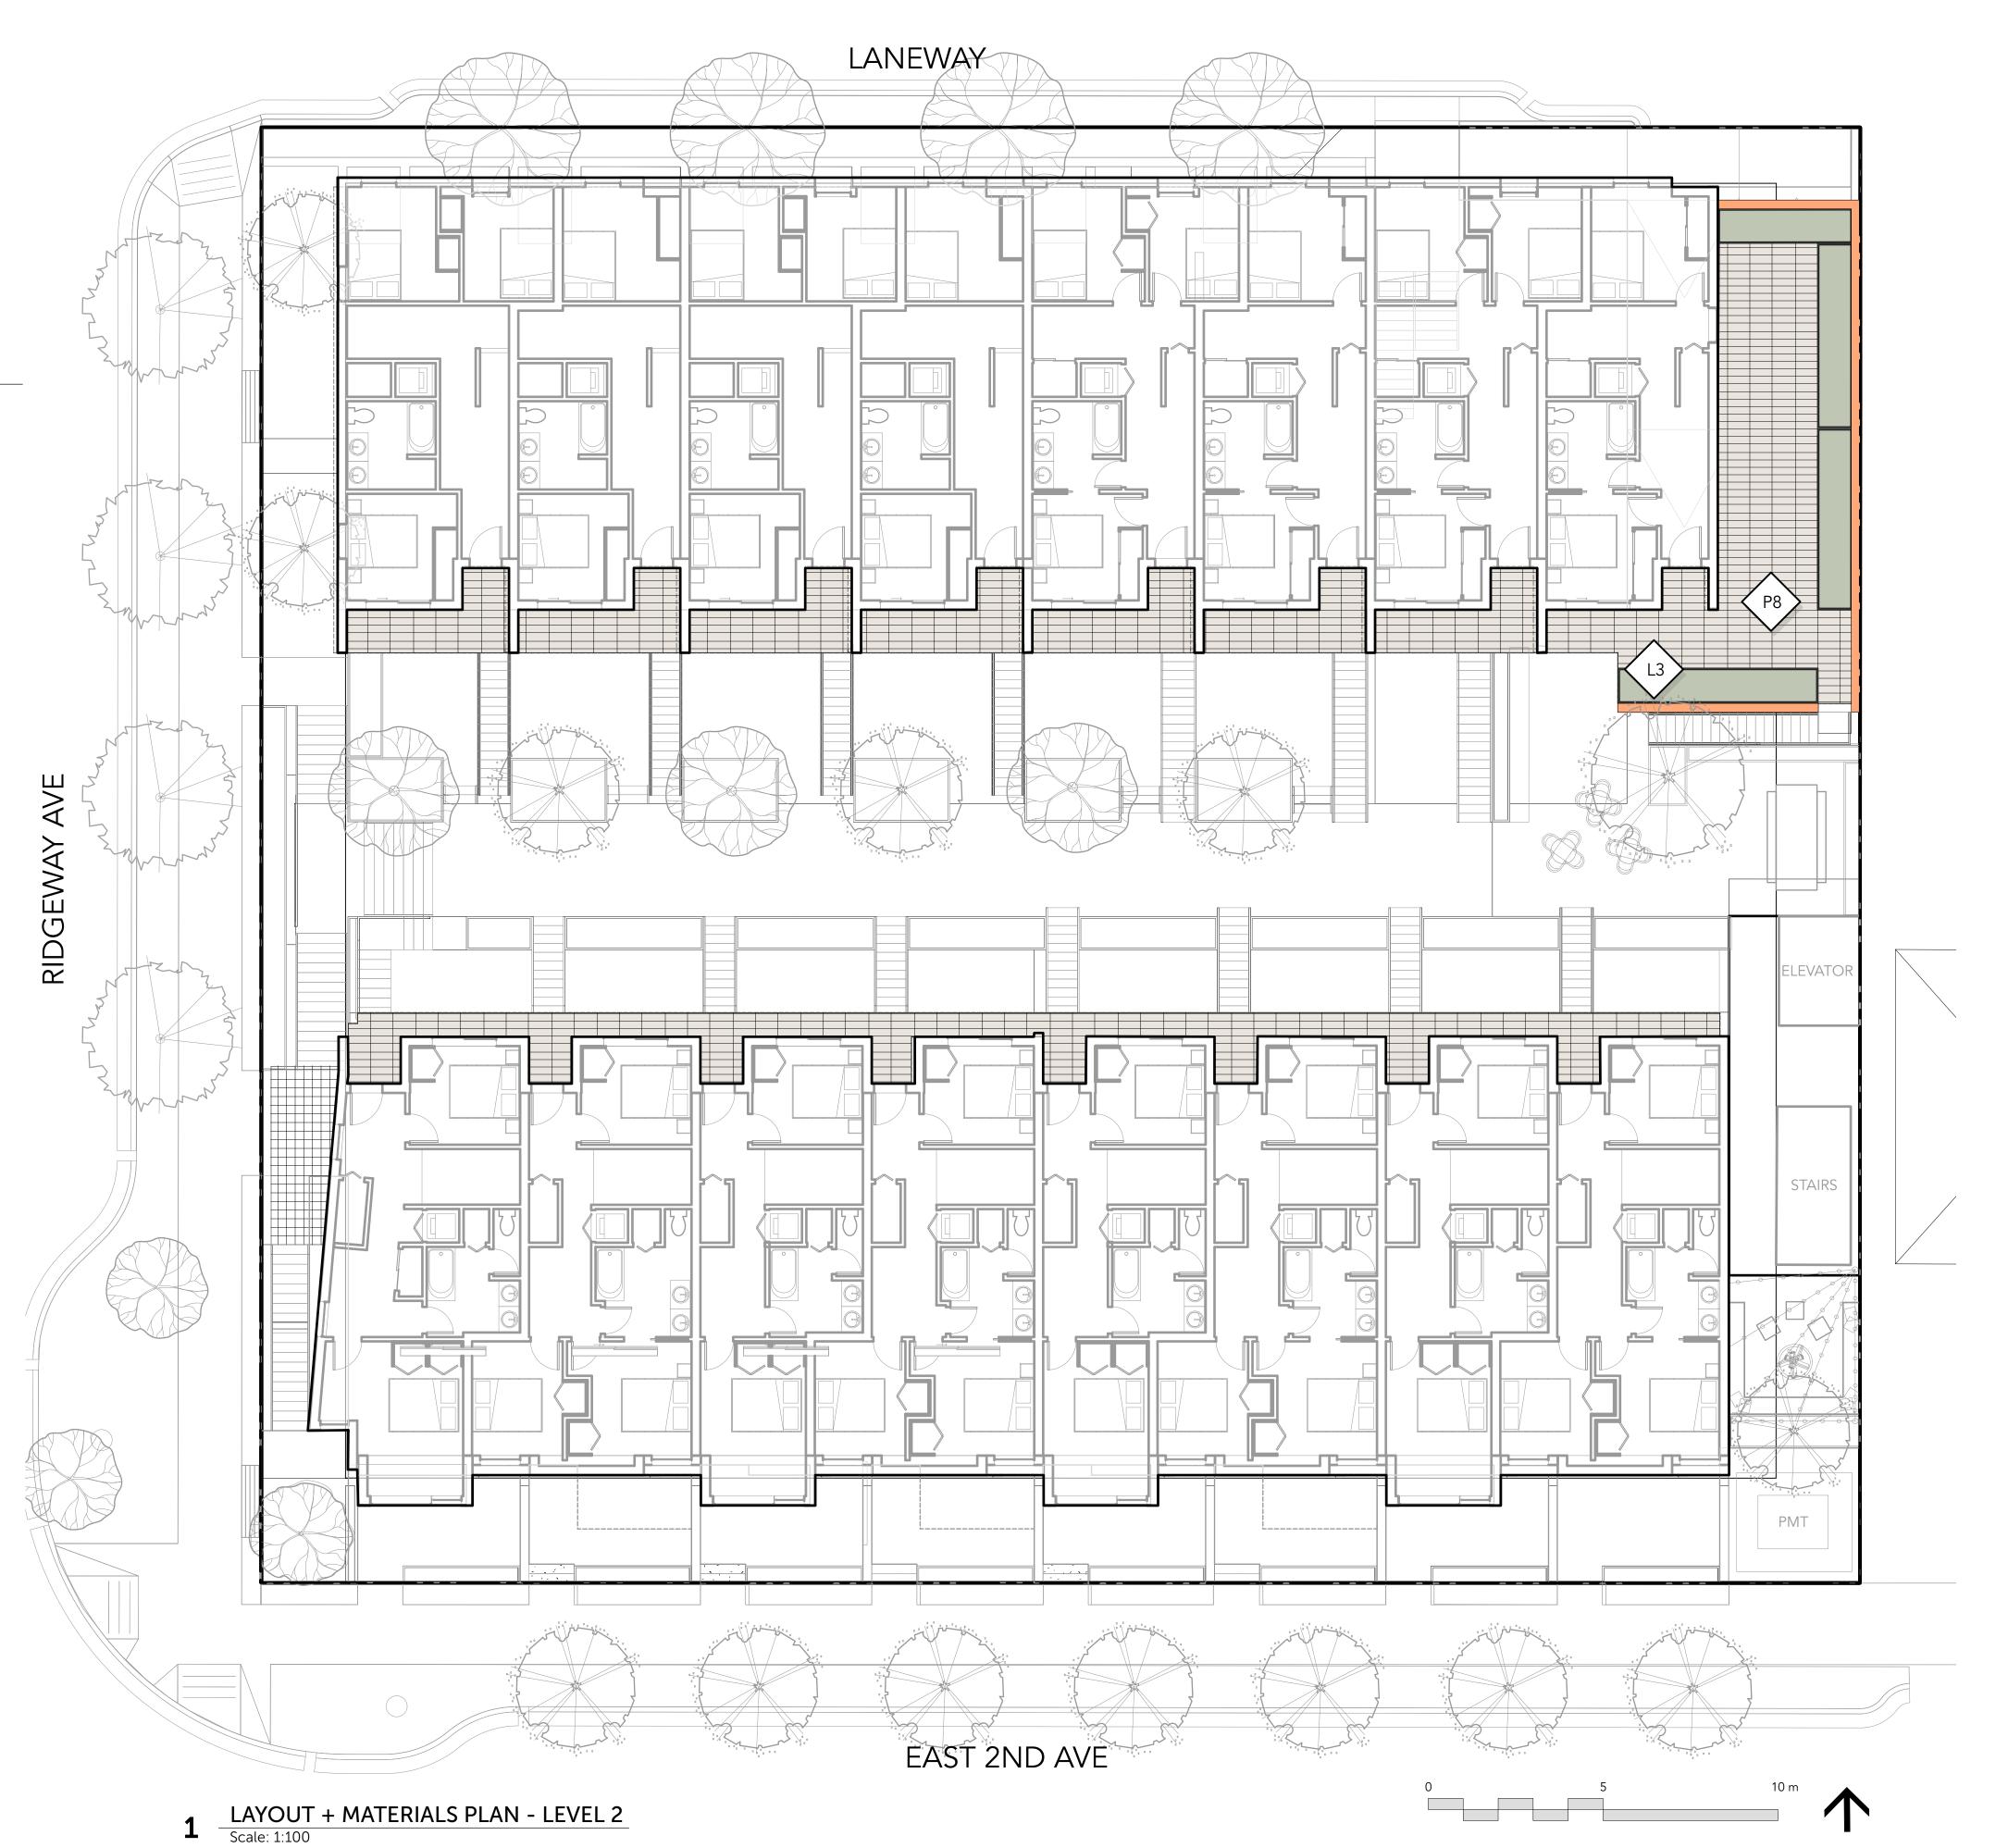

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Checked By Checked


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MATERIALS + LAYOUT PLAN - LEVEL 2

111

GENERAL LAYOUT + MATERIALS NOTES:

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- 5. ALL SUBSTITUTIONS OF SPECIFIED MATERIALS TO BE APPROVED BY LANDSCAPE ARCHITECT.



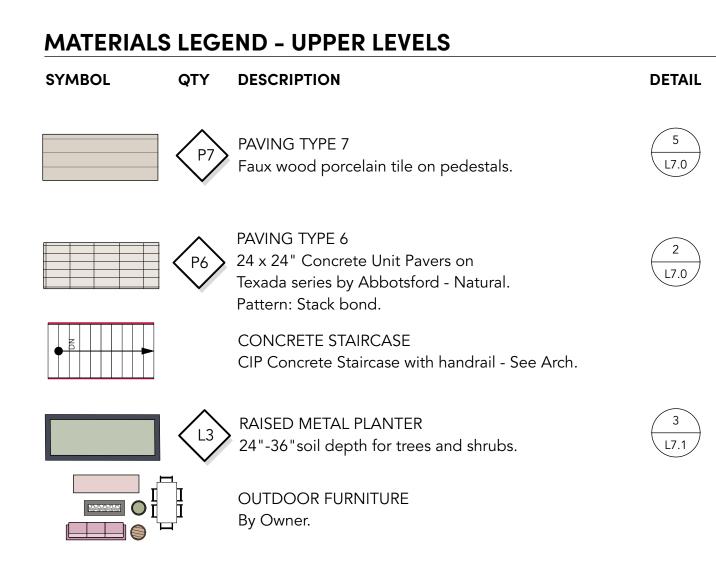

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MATERIALS + LAYOUT

PLAN - UPPER LEVELS

Rev. A revision

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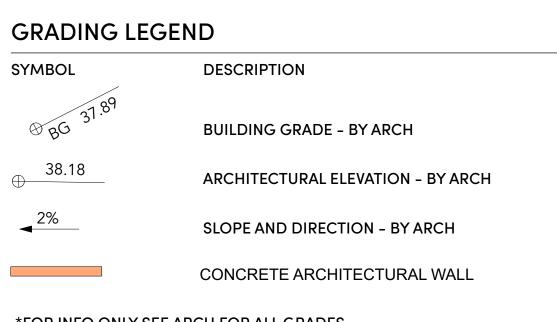
MICHAEL N. ENN

22-01-24

22-02-25

GENERAL GRADING NOTES:

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- 3. THE LAYOUT OF ALL PROPOSED HARDSCAPE ITEMS, SITE FURNITURE, LIGHTING, PLANTING BEDS AND OTHER MATERIALS IS TO BE STAKED OUT BY THE CONTRACTOR AND APPROVED BY THE LANDSCAPE ARCHITECT PRIOR TO INSTALLATION.
- 4. ALL SUBSTITUTIONS OF SPECIFIED MATERIALS TO BE APPROVED BY LANDSCAPE ARCHITECT.
- 5. REFER TO CIVIL FOR EXCAVATION DEPTHS, BACKFILL, AND BASE MATERIAL FOR ALL LANDSCAPE ITEMS SHOWN ON PLAN.
- 6. SLOPE SHALL MATCH EXISTING GRADE ALONG ALL PROPERTY LINES.
- 7. REFER TO CIVIL ENGINEER'S PRECISE GRADING PLANS FOR SITE GRADING PLANS FOR SITE GRADING, DRAINAGE, AND UTILITY LOCATIONS. IF ACTUAL SITE CONDITIONS VARY FROM WHAT IS SHOWN ON THE LANDSCAPE ARCHITECT'S PLANS, THE CONTRACTOR SHALL CONTACT THE OWNER'S REPRESENTATIVE AND LANDSCAPE ARCHITECT FOR DIRECTION AS TO HOW TO PROCEED.
- 8. THE CONTRACTOR IS RESPONSIBLE FOR VERIFYING THE ACTUAL LOCATION AND ELEVATION IN THE FIELD PRIOR TO BEGINNING CONSTRUCTION. THE CONTRACTOR SHALL PROTECT ALL EXISTING UTILITIES AND SHALL BE RESPONSIBLE FOR ANY DAMAGE TO EXISTING UTILITIES ENCOUNTERED DURING CONSTRUCTION.
- 9. ALL PROPOSED GRADES ARE TO MEET AND BLEND IN WITH EXISTING GRADING AT PROJECT LIMITS, GRADING LIMITS, AND EXISTING SIDEWALK. PRECISE ELEVATIONS INDICATED ON PLANS TO BE VERIFIED IN FIELD TO AS-BUILT CONDITION.
- 10.THE DEBRIS CREATED BY LANDSCAPE GRADING OPERATIONS SHALL BECOME THE PROPERTY OF THE CONTRACTOR AND SHALL BE DISPOSED OF LEGALLY OFF SITE.
- 11. FINAL GRADING SHALL BE REVIEWED BY THE LANDSCAPE ARCHITECT IN THE FIELD PRIOR TO INSTALLATION OF PLANTING.



*FOR INFO ONLY SEE ARCH FOR ALL GRADES SOIL DEPTH LEGEND DESCRIPTION SYMBOL SHRUB PLANTING 24" Minimum Soil Depth + 4" Drainage Layer Refer to Planting Detail TREE PLANTING 36" Minimum Soil Depth 36" + 4" Drainage Layer Refer to Planting Detail IN-GROUND PLANTING 24" Depth for Shrubs - 36" Depth for Trees IN-GROUND SOD PLANTING 12" Depth





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Landscape Architect LOCI Landscape Architecture + Urban Design

Checked By Drawn By Drawn By Checked

GRADING + SOIL DEPTH PLAN - LEVEL 1 + 2

GENERAL GRADING NOTES:

- 1. ALL UTILITIES TO BE STAKED OUT BY CONTRACTOR AND PROTECTED FOR DURATION OF CONSTRUCTION PERIOD.
- 2. UNLESS OTHERWISE NOTED, PROVIDE A MINIMUM 2% SLOPE ON ALL HARD AND SOFT LANDSCAPE AREAS TO ENSURE POSITIVE DRAINAGE AWAY FROM BUILDINGS OR TO DRAINAGE STRUCTURES. MAXIMUM 3:1 SLOPE IN SOFT LANDSCAPE AREAS.
- 3. THE LAYOUT OF ALL PROPOSED HARDSCAPE ITEMS, SITE FURNITURE, LIGHTING, PLANTING BEDS AND OTHER MATERIALS IS TO BE STAKED OUT BY THE CONTRACTOR AND APPROVED BY THE LANDSCAPE ARCHITECT PRIOR TO INSTALLATION.
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- 7. REFER TO CIVIL ENGINEER'S PRECISE GRADING PLANS FOR SITE GRADING PLANS FOR SITE GRADING, DRAINAGE, AND UTILITY LOCATIONS. IF ACTUAL SITE CONDITIONS VARY FROM WHAT IS SHOWN ON THE LANDSCAPE ARCHITECT'S PLANS, THE CONTRACTOR SHALL CONTACT THE OWNER'S REPRESENTATIVE AND LANDSCAPE ARCHITECT FOR DIRECTION AS TO HOW TO PROCEED.
- 8. THE CONTRACTOR IS RESPONSIBLE FOR VERIFYING THE ACTUAL LOCATION AND ELEVATION IN THE FIELD PRIOR TO BEGINNING CONSTRUCTION. THE CONTRACTOR SHALL PROTECT ALL EXISTING UTILITIES AND SHALL BE RESPONSIBLE FOR ANY DAMAGE TO EXISTING UTILITIES ENCOUNTERED DURING CONSTRUCTION.
- 9. ALL PROPOSED GRADES ARE TO MEET AND BLEND IN WITH EXISTING GRADING AT PROJECT LIMITS, GRADING LIMITS, AND EXISTING SIDEWALK. PRECISE ELEVATIONS INDICATED ON PLANS TO BE VERIFIED IN FIELD TO AS-BUILT CONDITION.
- 10.THE DEBRIS CREATED BY LANDSCAPE GRADING OPERATIONS SHALL BECOME THE PROPERTY OF THE CONTRACTOR AND SHALL BE DISPOSED OF LEGALLY OFF SITE.
- 11. FINAL GRADING SHALL BE REVIEWED BY THE LANDSCAPE ARCHITECT IN THE FIELD PRIOR TO INSTALLATION OF PLANTING.

SYMBOL DESCRIPTION BUILDING GRADE - BY ARCH ARCHITECTURAL ELEVATION - BY ARCH SLOPE AND DIRECTION - BY ARCH CONCRETE ARCHITECTURAL WALL

*FOR INFO ONLY SEE ARCH FOR ALL GRADES

SOIL DEPTH LEGEND


SYMBOL DESCRIPTION

SHRUB PLANTING
24" Minimum Soil Depth + 4" Drainage Layer Refer to Planting Detail

TREE PLANTING
36" Minimum Soil Depth 36" + 4" Drainage Layer Refer to Planting Detail

IN-GROUND PLANTING
24" Depth for Shrubs - 36" Depth for Trees

IN-GROUND SOD PLANTING
12" Depth

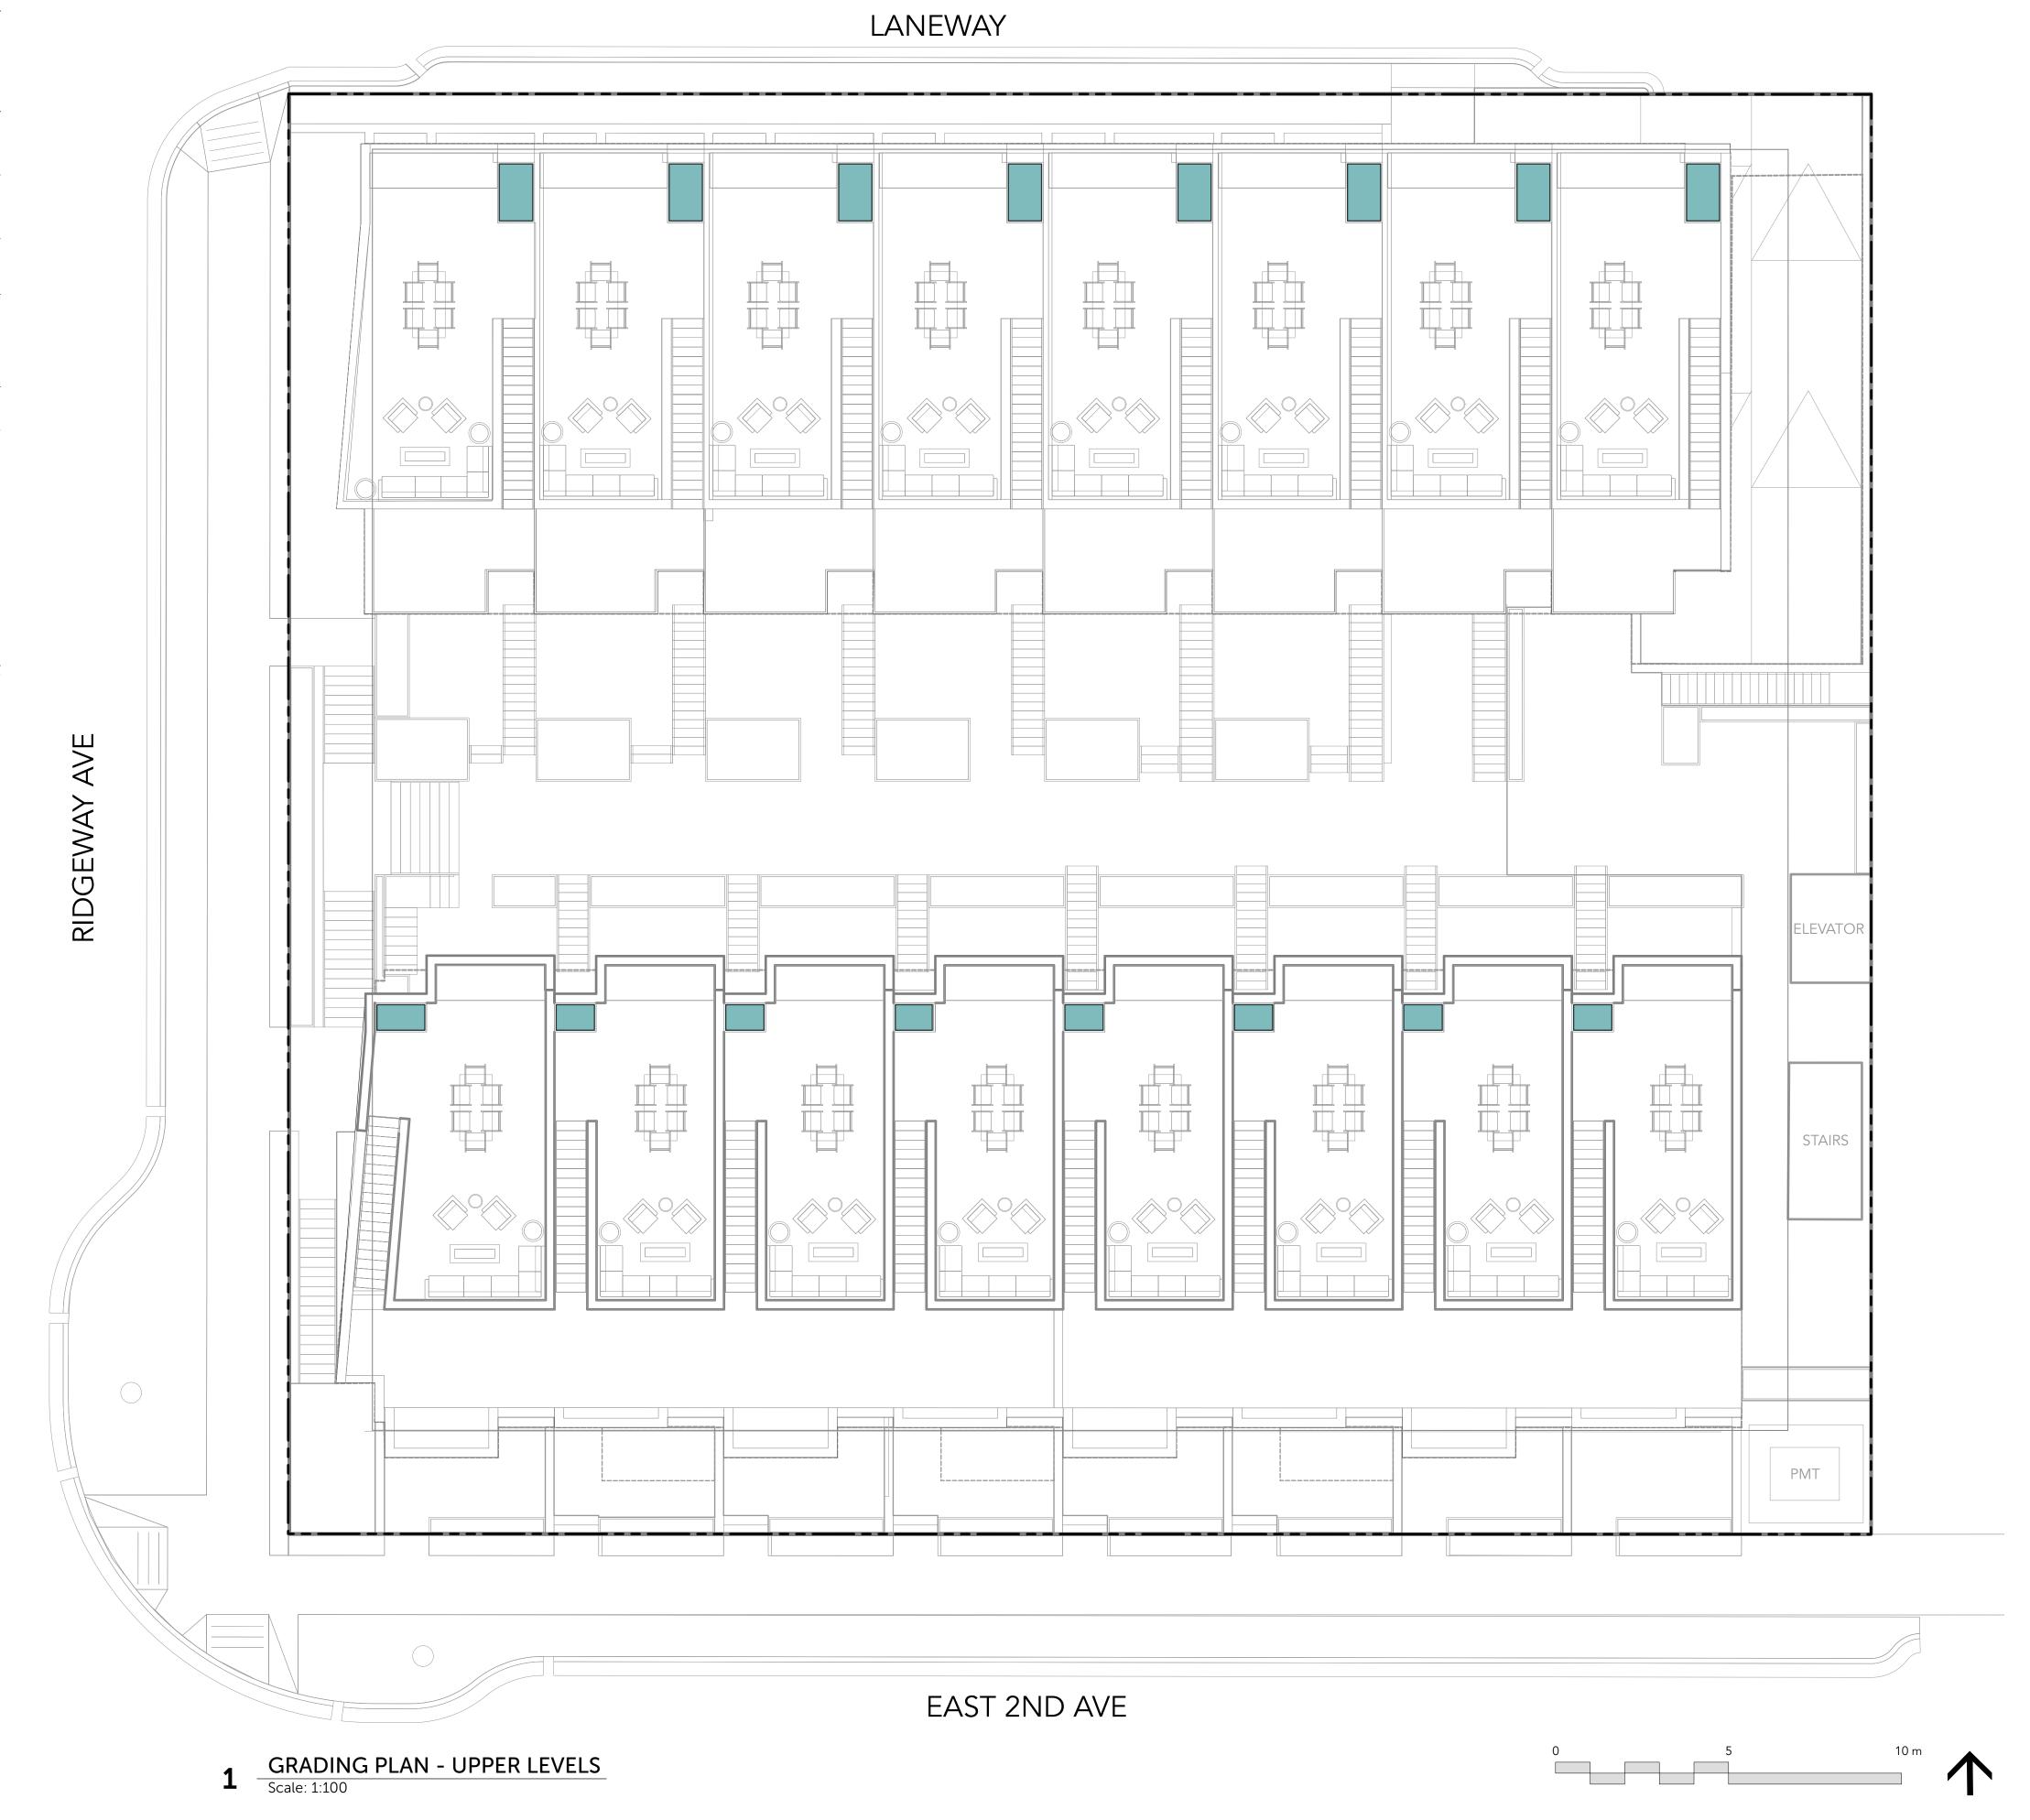

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B ISSUED FOR DEVELOPMENT 22-02-25
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Project Team

Creo Developments

Architect
Shape Architecture

Landscape Architect

LOCI Landscape Architecture + Urban Design


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GRADING + SOIL DEPTH PLAN - UPPER LEVELS

L2.1

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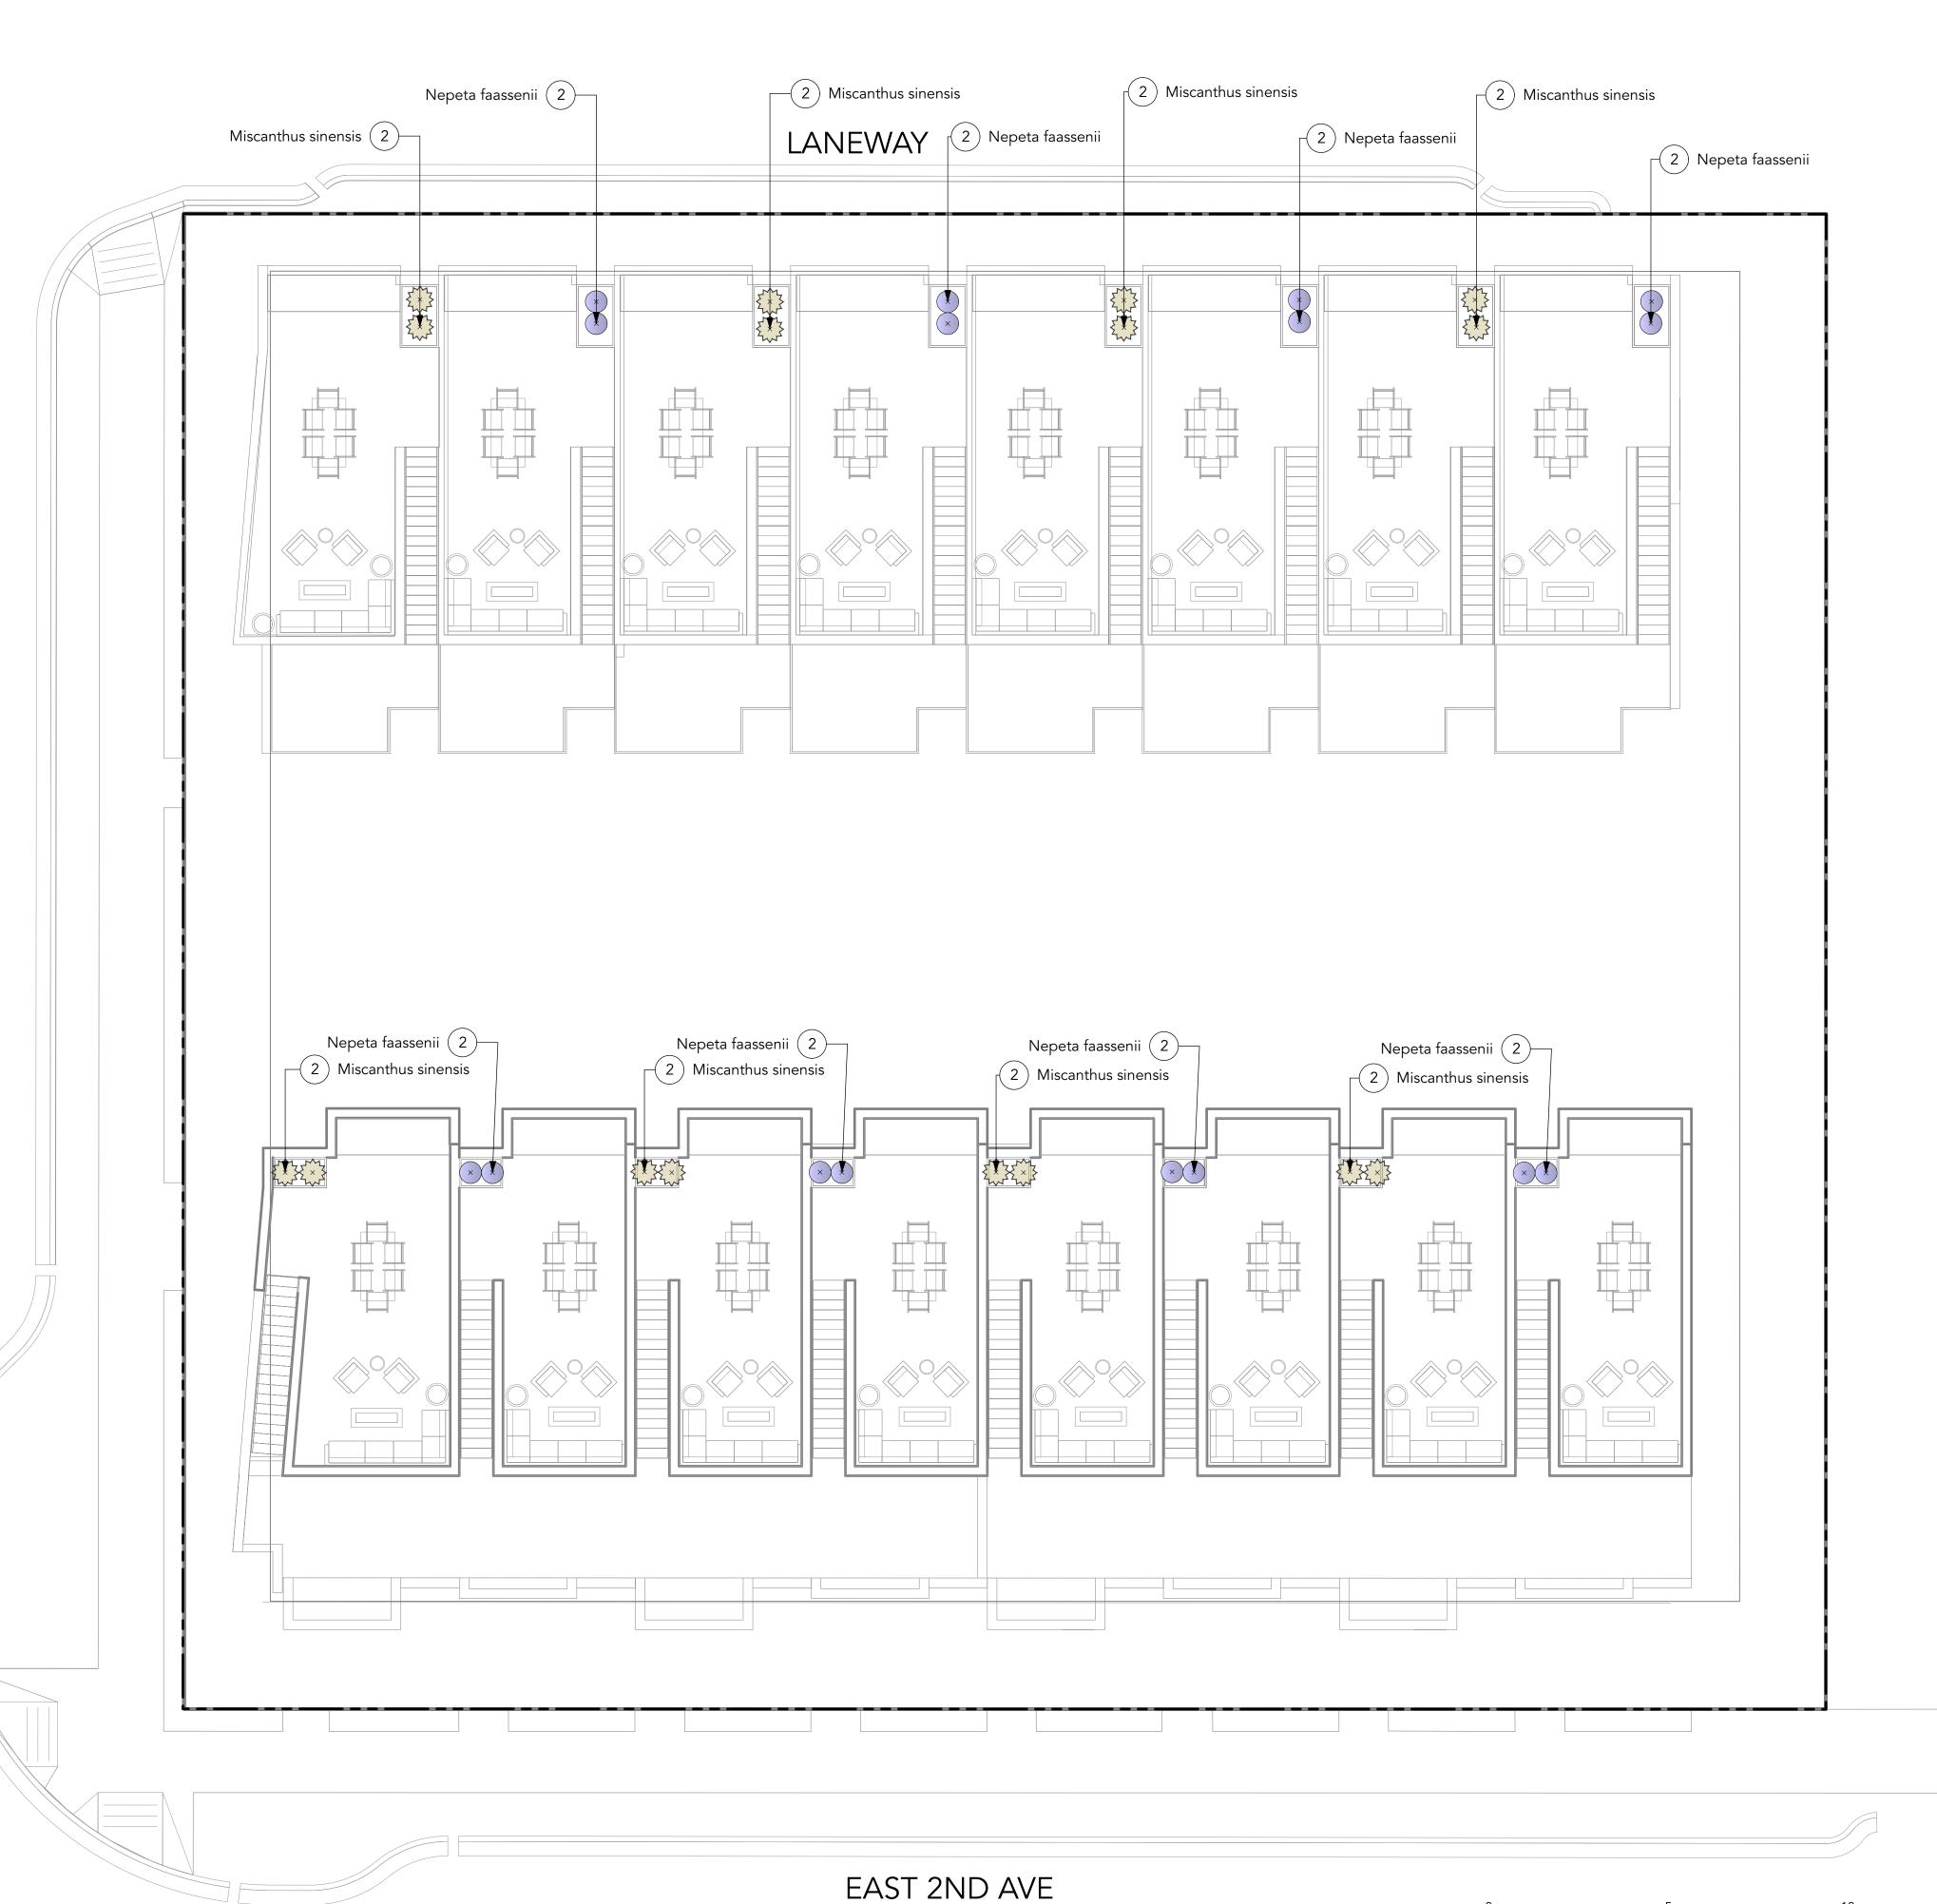
GENERAL PLANTING NOTES:

- 1. ALL PLANTING SHALL BE IN ACCORDANCE WITH BC LANDSCAPE STANDARD, LATEST EDITION
- 2. ALL TREE AND SHRUB AREAS TO BE MULCHED WITH 50MM (2") OF MEDIUM FINE MULCH, LESS THAN 50MM (2") DIAMETER.
- 3. ROOTZONE TO REST ON TAMPED PLANTING SOIL
- 4. SHRUBS: PREPARE PLANTING HOLES AS SPECIFIED. PLANT AT THE SAME GRADE AS NURSERY. WATER AND FERTILIZE AS SPECIFIED. ENSURE POSITIVE DRAINAGE THROUGHOUT PLANTING BED
- 5. TREE SIZE AND SPACING TO BE AS PER CITY OF VANCOUVER ARBORIST
- 6. TREE: PREPARE PLANTING HOLES AS SPECIFIED INSTALL TOP OF ROOTZONE 6" ABOVE FINISHED GRADE OF GROWING MEDIUM. WATER AND FERTILIZE AS SPECIFIED BY NURSERY.
- 7. FINAL SOFTSCAPE AND GRADING LAYOUTS AS WELL AS LOCATION SPACING TO BE APPROVED BY LANDSCAPE ARCHITECTS IN THE FIELD PRIOR TO INSTALLATION
- 8. IN CASE OF A DISCREPANCY BETWEEN PLANT INFORMATION ON THE LIST AND ON THE PLAN, THE LATTER SHALL PREVAIL
- 9. ALL PLANT MATERIAL TO BE MANUALLY WATERED FROM START OF INSTALLATION THROUGH THE END OF THE WARRANTY PERIOD
- 10.INSTALL TREE PROTECTION FENCING AROUND ALL EXISTING TREES TO CITY OF VANCOUVER STANDARDS. INSTALL TREE PROTECTION FENCING ON NEW PLANTING IF PHASED INSTALLATION IS REQUIRED.

JGEWAY
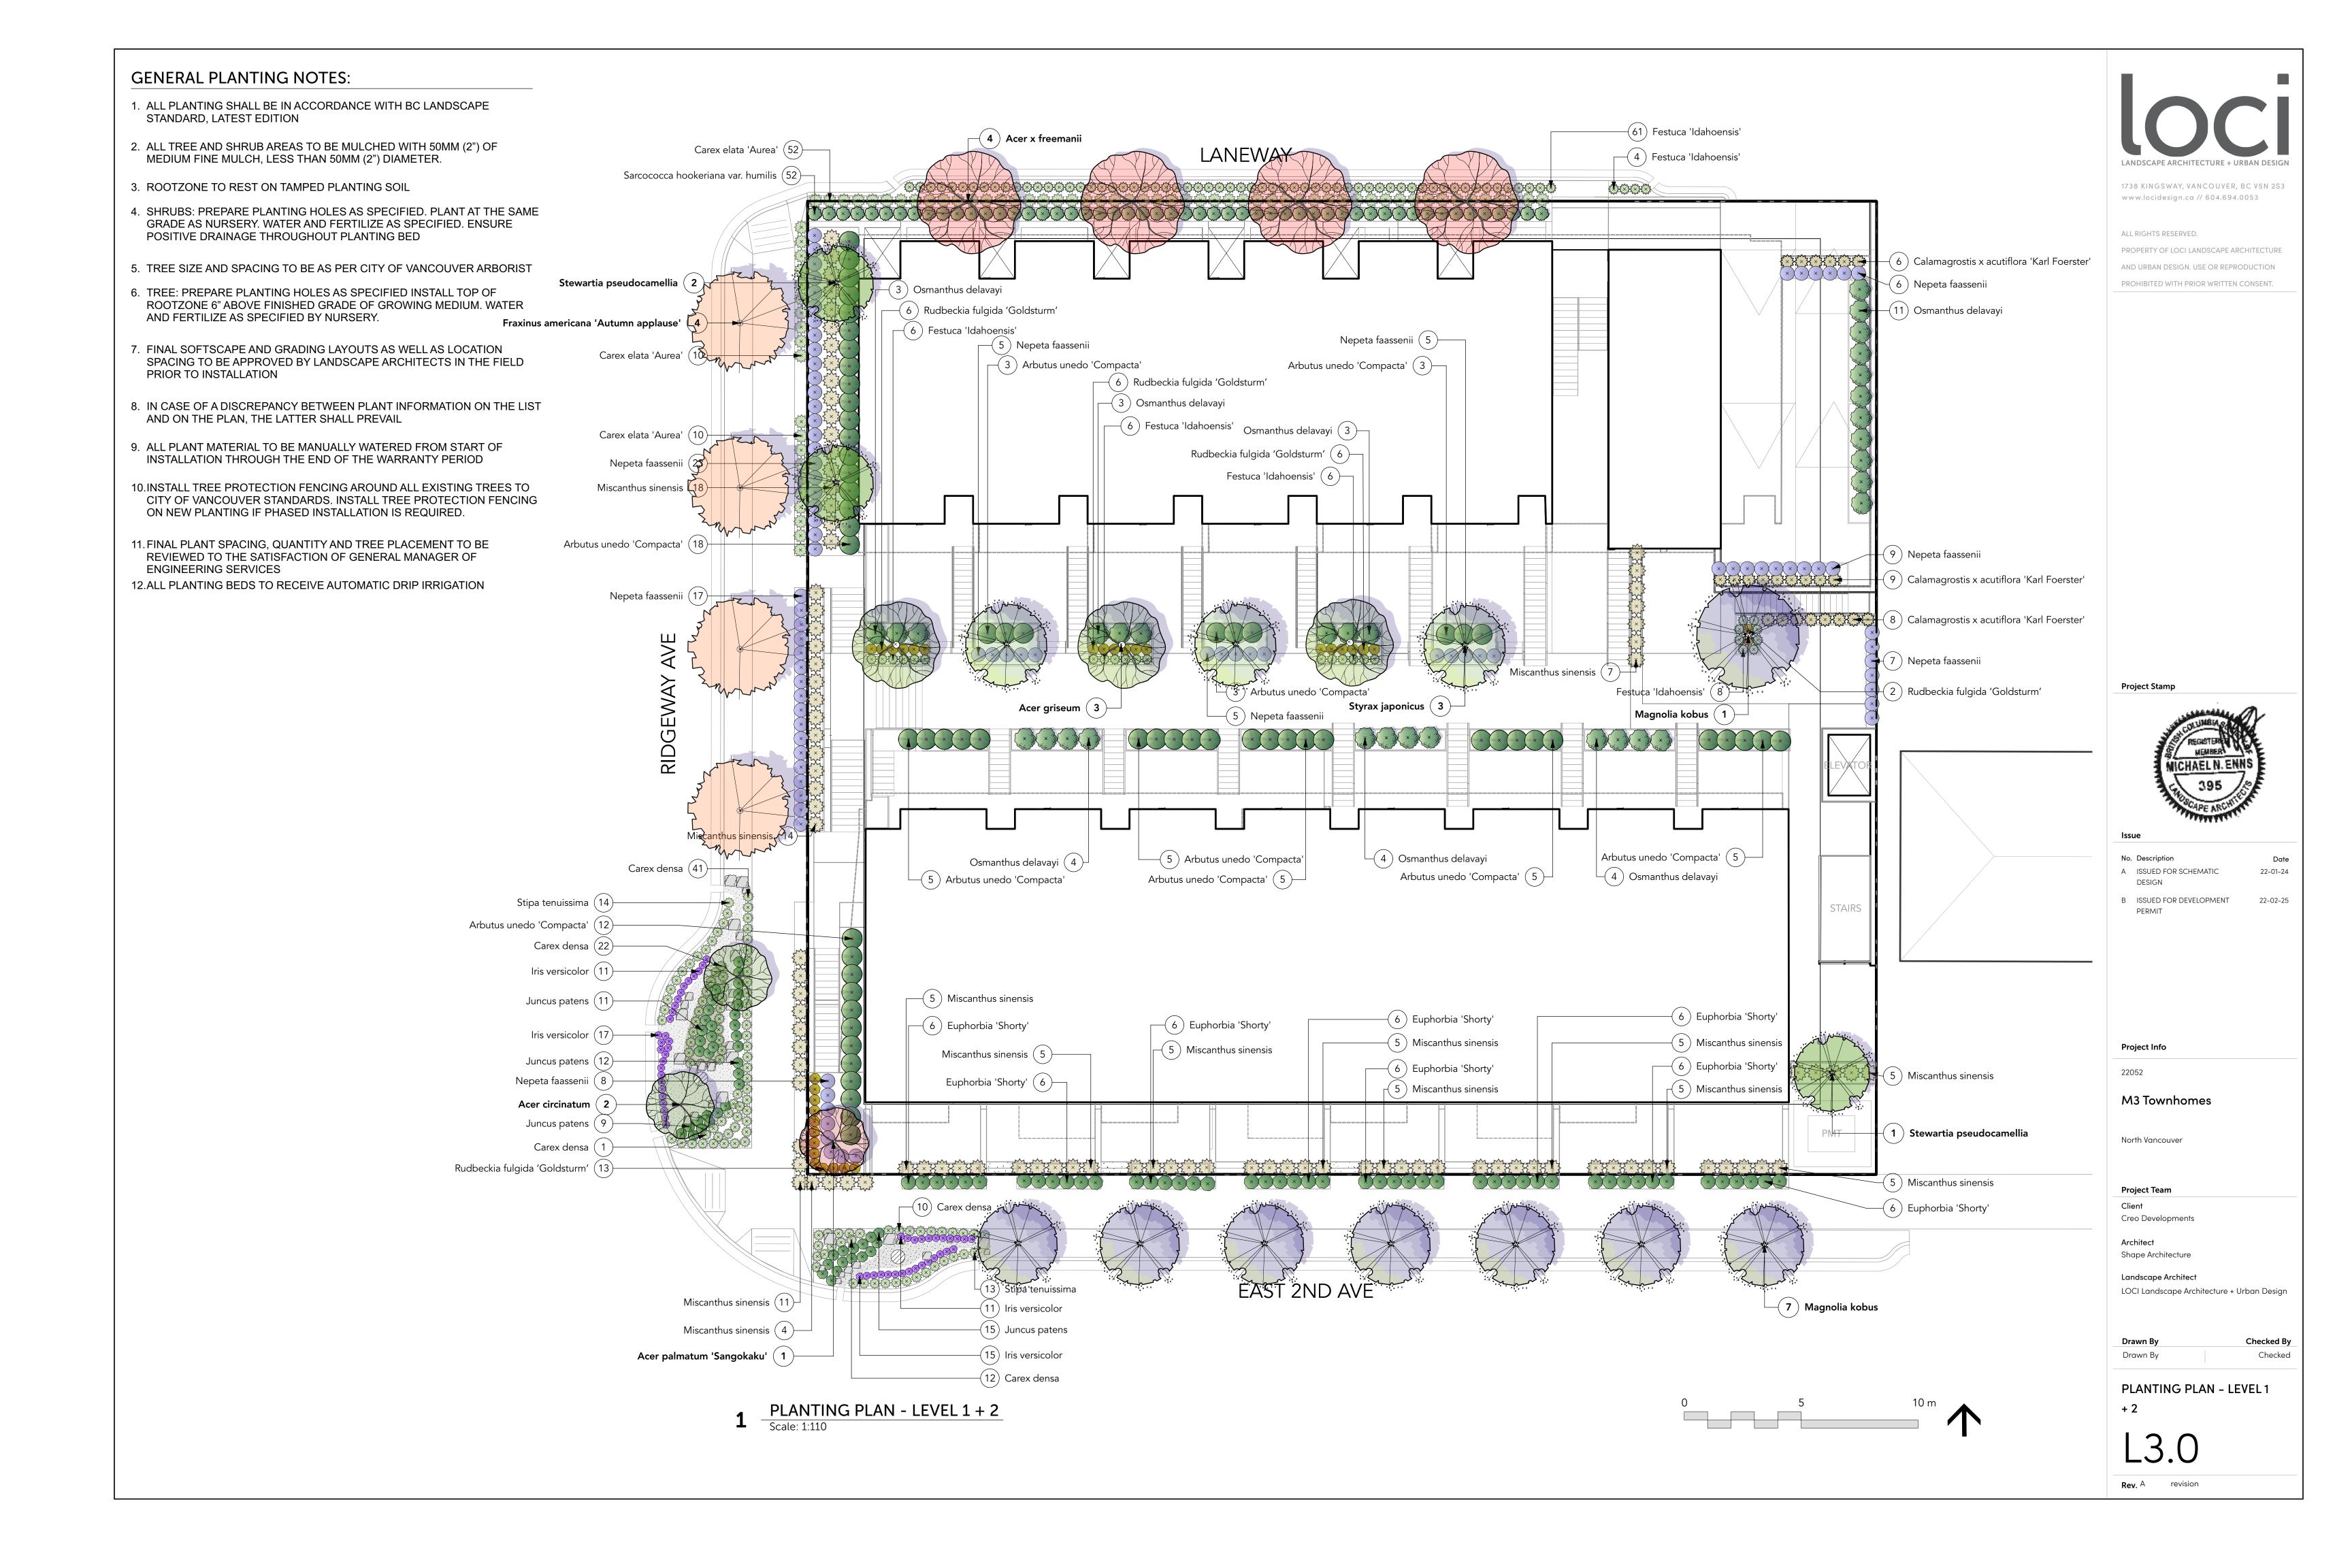
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- 11. FINAL PLANT SPACING, QUANTITY AND TREE PLACEMENT TO BE REVIEWED TO THE SATISFACTION OF GENERAL MANAGER OF ENGINEERING SERVICES
- 12.ALL PLANTING BEDS TO RECEIVE AUTOMATIC DRIP IRRIGATION



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PLANTING PLAN - UPPER LEVELS

31

Rev. A revision

1 PLANTING PLAN - UPPER LEVELS
Scale: 1:100

GENERAL LIGHTING NOTES:

- 1. THE ELECTRICAL CONTRACTOR SHALL PROVIDE SHOP DRAWINGS FOR ALL ELECTRICAL WORK FOR THE LANDSCAPE ARCHITECTS APPROVAL. SHOP DRAWINGS SHALL BE SIGNED AND SEALED BY LICENSED ELECTRICAL ENGINEER, OR MASTER ELECTRICIAN. PRIOR TO WORK COMMENCING/INSTALLATION.
- 2. ALL FIXTURE TYPES, SPACING, AND QUANTITIES TO BE CONFIRMED.
- 3. PRICE BASED ON LED LIGHT SOURCE FOR APPLICABLE LUMINAIRES
- 4. REFER TO ELECTRICAL ENGINEER FOR SERVICING REQUIREMENTS
- 5. THE LIGHTING CONTRACTOR IS OBLIGATED TO REFER TO THE LANDSCAPE PLANS AND DETAILS FOR LOCATIONS OF FIXTURES RELATIVE TO THE PROPOSED HARDSCAPE AND PLANTING PLANS. NOTED DIMENSIONS ARE APPROXIMATE. REFER TO NOTE OR ENLARGEMENT, FOR FINAL PLACEMENT. CONTACT LANDSCAPE ARCHITECT FOR CLARIFICATION, IF NEEDED.
- 6. THE LANDSCAPE ARCHITECT OR CLIENT'S REPRESENTATIVE SHALL APPROVE THE FLAGGED LAYOUT OF THE FIXTURES AND ELECTRICAL SYSTEM PRIOR TO TRENCHING AND/OR FOUNDATION PREPARATION.
- 7. THE ELECTRICAL/LIGHTING CONTRACTOR IS RESPONSIBLE TO COORDINATE THE PLACEMENT OF SLEEVES PRIOR TO PAVING, SLEEVE MATERIAL SHALL BE SCHEDULE 40 AND AT A MINIMUM DEPTH TO MEET ALL ELECTRICAL CODES.
- 8. THE ELECTRICAL/LIGHTING CONTRACTOR IS RESPONSIBLE FOR ALL PERMITS, LICENSES, AND ASSOCIATED FEES REQUIRED TO INSTALL THE SYSTEM(S) INCLUDING ALL ELECTRICAL CONDUIT, LIGHT FIXTURES, WIRE, PANELS, JUNCTION BOXES AND NECESSARY EQUIPMENT FOR THE COMPLETION OF THE WORK.
- 9. THE ELECTRICAL/LIGHTING CONTRACTOR IS RESPONSIBLE FOR CONTACTING UTILITY COMPANIES, COMMUNICATIONS PROVIDERS AND OTHERS TO IDENTIFY AND MARK LOCATIONS OF ALL UNDERGROUND UTILITIES WITHIN THE SCOPE OF WORK. KNOWN UTILITIES WHICH MAY BE ENCOUNTERED INCLUDE: ELECTRICAL, STORM SEWER, WATER, AND SANITARY SEWER.
- 10. VERIFY IN FIELD, ALL LOCATIONS OF FIXTURES, ELECTRICAL LINES OR OTHER LIGHTING SYSTEM ELEMENTS WITHIN THE DRIP LINE OF ANY EXISTING TREES. NOTIFY LANDSCAPE ARCHITECT OF SUCH OCCURRENCES PRIOR TO COMMENCEMENT OF WORK. HAND EXCAVATE WITHIN THE DRIPLINE OF ANY TREE, REFER TO SPECIFICATIONS.
- 11. ELECTRICAL CONDUIT LAYOUT IS DIAGRAMMATIC ON DOCUMENTS. ADJUST LOCATIONS ON SITE TO ACCOMMODATE EXISTING JOB CONDITIONS AND TO ACHIEVE MINIMAL IMPACT TO IN PLACE AND FUTURE ELEMENTS. AVOID INSTALLATIONS UNDER TREES.
- 12. THE CONTRACTOR SHALL VERIFY THE LOCATION OF EXISTING ELECTRIC POWER, AND PROPOSED CONNECTIONS AND METERS IN THE FIELD FOR APPROVAL OF THE LANDSCAPE ARCHITECT OR OWNER'S REPRESENTATIVE PRIOR TO INSTALLATION.
- 13. THE CONTRACTOR SHALL PROVIDE CIRCUIT BREAKERS, AND PHOTO CELL CONTACTORS FOR ACTIVATION OF LIGHTING CIRCUITS.
- 14. THE CONTRACTOR SHALL PROVIDE CIRCUIT BREAKERS AND ASTRONOMIC TIME CLOCK FOR DE-ACTIVATION ON LIGHTING CIRCUITS.
- 15. THE LIGHTING SYSTEM SHALL BE PHOTOCELL ON, TIMER OFF.

LIGHTING LEGEND - GROUND LEVEL

(ΥTÇ	TYPE	MANUFACTURER	DESCRIPTION
TYPE A		Spot Flood	KICHLER	120V-277V LED Small Accent, 5W & 10W
TYPE B		Wall Insert -Concrete Architectural wall	KUZCO	Sonic ER3005 Step Lights
TYPE C		LED Strip	Bruck	Orion Belt Narrow Beam Spread LED, Mounted Underneath Seat Wall Overhang
TYPE D		LED string lights on pole	Hometown Evolution Inc.	C9 Commercial String Light Sets Black Wire With G50 Clear Bulbs
		Bollard	VISTA	PR-4202-B-W-LB2ND
TYPE E				
			_	









C Type C-LED Strip



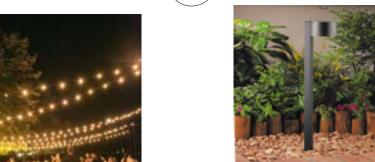

Type E- Vista Bollard Lighting

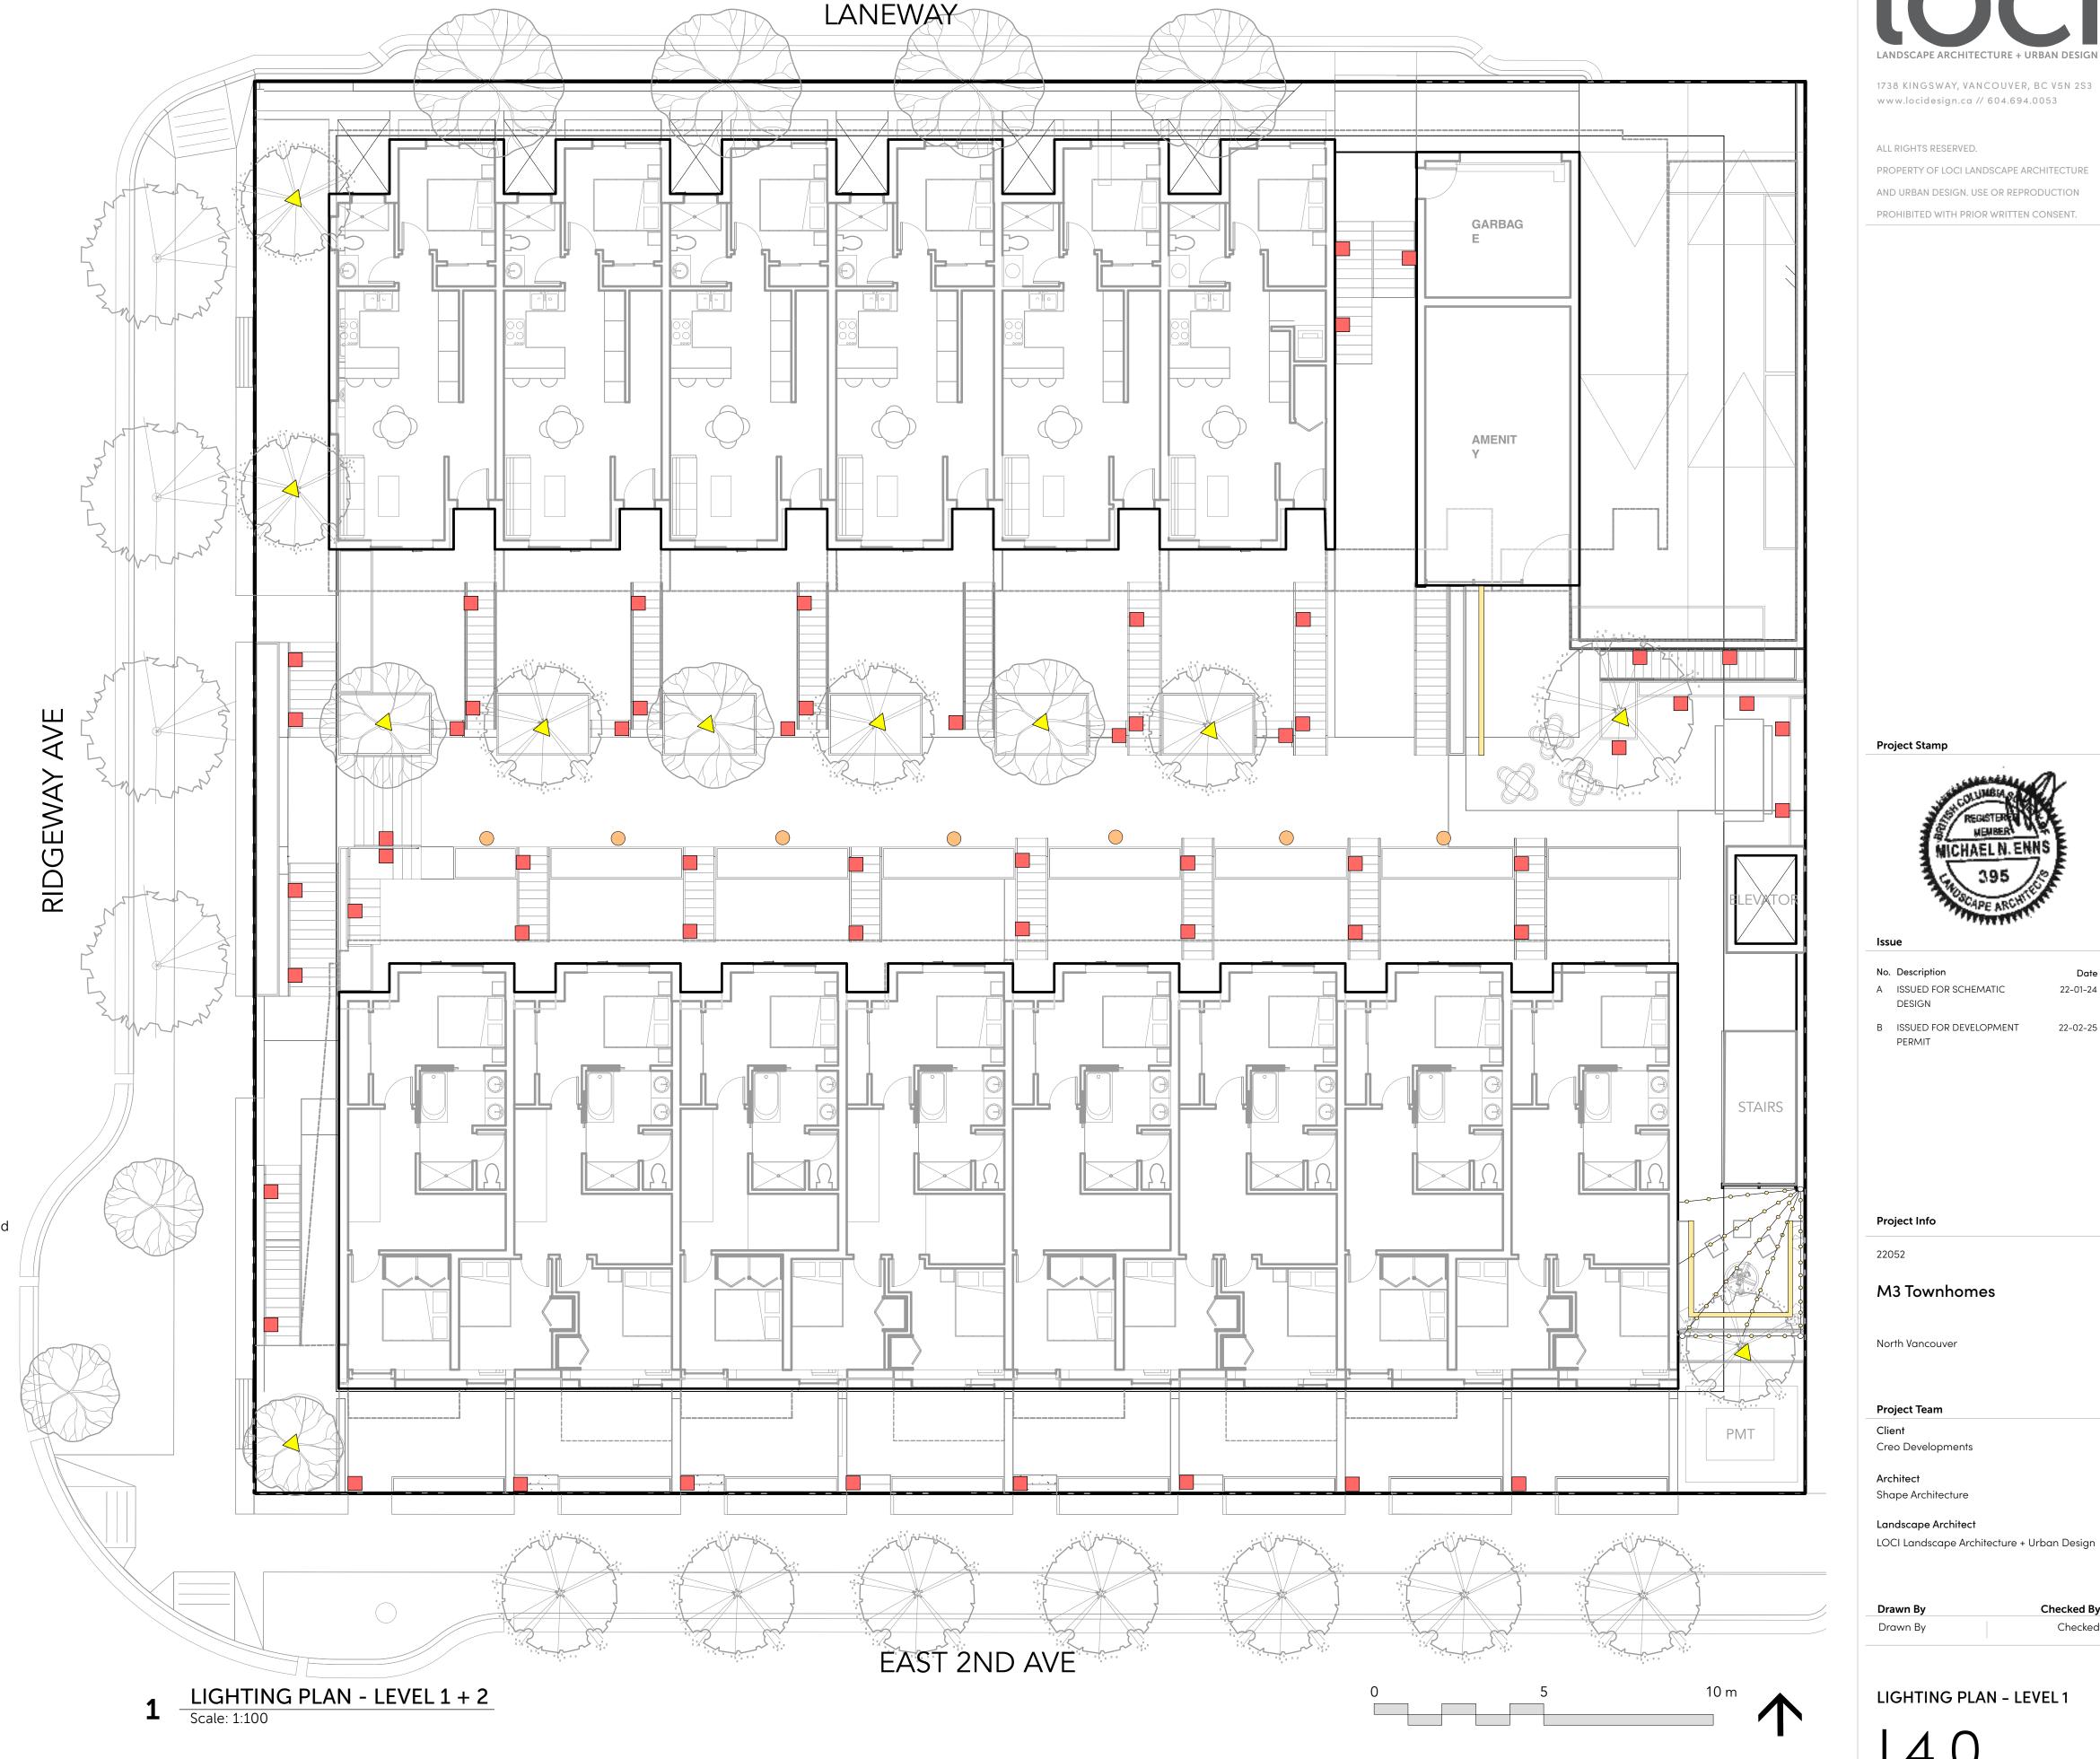

MICHAEL N. ENN

22-01-24

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OVERALL PLANT LIST

Symbol DECIDUOUS	•	Botanical Name	Common Name	Scheduled Size	Spacing	Not
	2	Acer circinatum	Vine Maple	7cm cal.	As Shown	B&E
	3	Acer griseum	Paperbark Maple	7cm cal.	As Shown	B&E
	1	Acer palmatum 'Sangokaku'	Coral Bark Japanese Maple	5cm cal.	As Shown	B&I
	4	Acer x freemanii	Autumn Blaze Maple	7cm cal.	As Shown	B&E
Example 1	4	Fraxinus americana 'Autumn applause'	Autumn Applause White Ash	7cm cal.	As Shown	B&I
	8	Magnolia kobus	Kobus Magnolia	8cm cal.	As Shown	B&E
	3	Stewartia pseudocamellia	Japanese Stewartia	6cm cal.	As Shown	B&E
	3	Styrax japonicus	Japanese Snowbell	7cm cal.	As Shown	B&E
IRUBS:						
	64	Arbutus unedo 'Compacta'	Compact Strawberry Bush	#2 Pot	0.76 o.c.	
	32	Osmanthus delavayi	Sweet Olive	#2 Pot	0.91 o.c.	
	52	Sarcococca hookeriana var. humilis	Himalayan Sweet Box	#2 Pot	0.61 o.c.	
RENNIALS	, GRASSES, G	ROUNDCOVER:				
£	23	Calamagrostis x acutiflora 'Karl Foerster'	Karl Foerster's Feather Reed Grass	#2 pot	0.61 o.c.	
	86	Carex densa	Dense Sedge	#1 pot	0.46 o.c.	
	72	Carex elata 'Aurea'	Bowles Golden Sedge	#2 pot	0.61 o.c.	
	48	Euphorbia 'Shorty'	Shorty Spurge	#2 Pot	0.61 o.c.	
	91	Festuca 'Idahoensis'	Idaho fescue	#1 pot	0.46 o.c.	
	54	Iris versicolor	Purple Iris	#1 Pot	0.3 o.c.	
	47	Juncus patens	Soft Common Rush	#2 Pot	0.46 o.c.	
	99	Miscanthus sinensis	Maiden Grass	#2 Pot	0.76 o.c.	
	85	Nepeta faassenii	'Cat's Meow' Catmint	#1 Pot	0.61 o.c.	
	33	Rudbeckia fulgida 'Goldsturm'	Black-Eyed Susan	#2 Pot	0.46 o.c.	
£	27	Stipa tenuissima	Mexican Feather Grass	#1 pot, 18" o.c.	0.46 o.c.	

PLANT IMAGES

TREES





Acer griseum
Paperbark Maple







Fraxinus ' Autumn applause White Ash





Stewartia pseudocamellia

Japanese Stewartia

Styrax japonicus

Japanese Snowbell

SHRUBS







Osmanthus delavayi **Sweet Olive**



ORNAMENTAL GRASSES, PERENNIALS, FERNS, AND GROUNDCOVERS



Calamagrostis x acutiflora 'Karl Foerster'

Juncus patens **Rush**



Carex densa

Dense Sedge



Miscanthus sinensis 'Morning Light'

Morning Light Maiden Grass

Nepeta faassenii

Catmint

Carex elata 'Aurea' **Bowles Golden Sedge**



Euphorbia 'Shorty'
Shorty Spurge

Rudeckia fulgida 'Goldstrum'

Black-Eyed Susan



Festuca 'Idahoensis' Idaho fescue



Iris versicolor Purple Iris

Stipa tenuissima Mexican Feather Grass

No. Description

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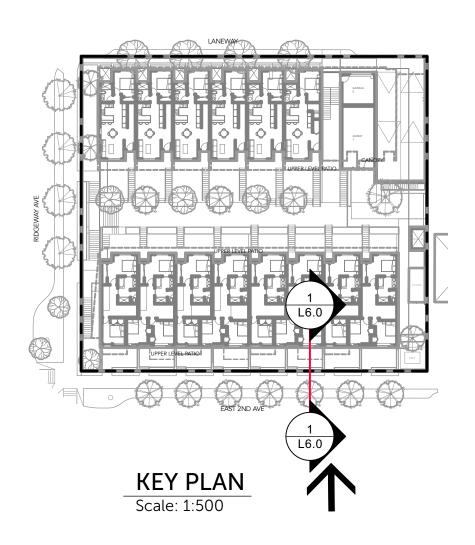
Architect


Shape Architecture

Landscape Architect LOCI Landscape Architecture + Urban Design

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PLANT LIST + IMAGES





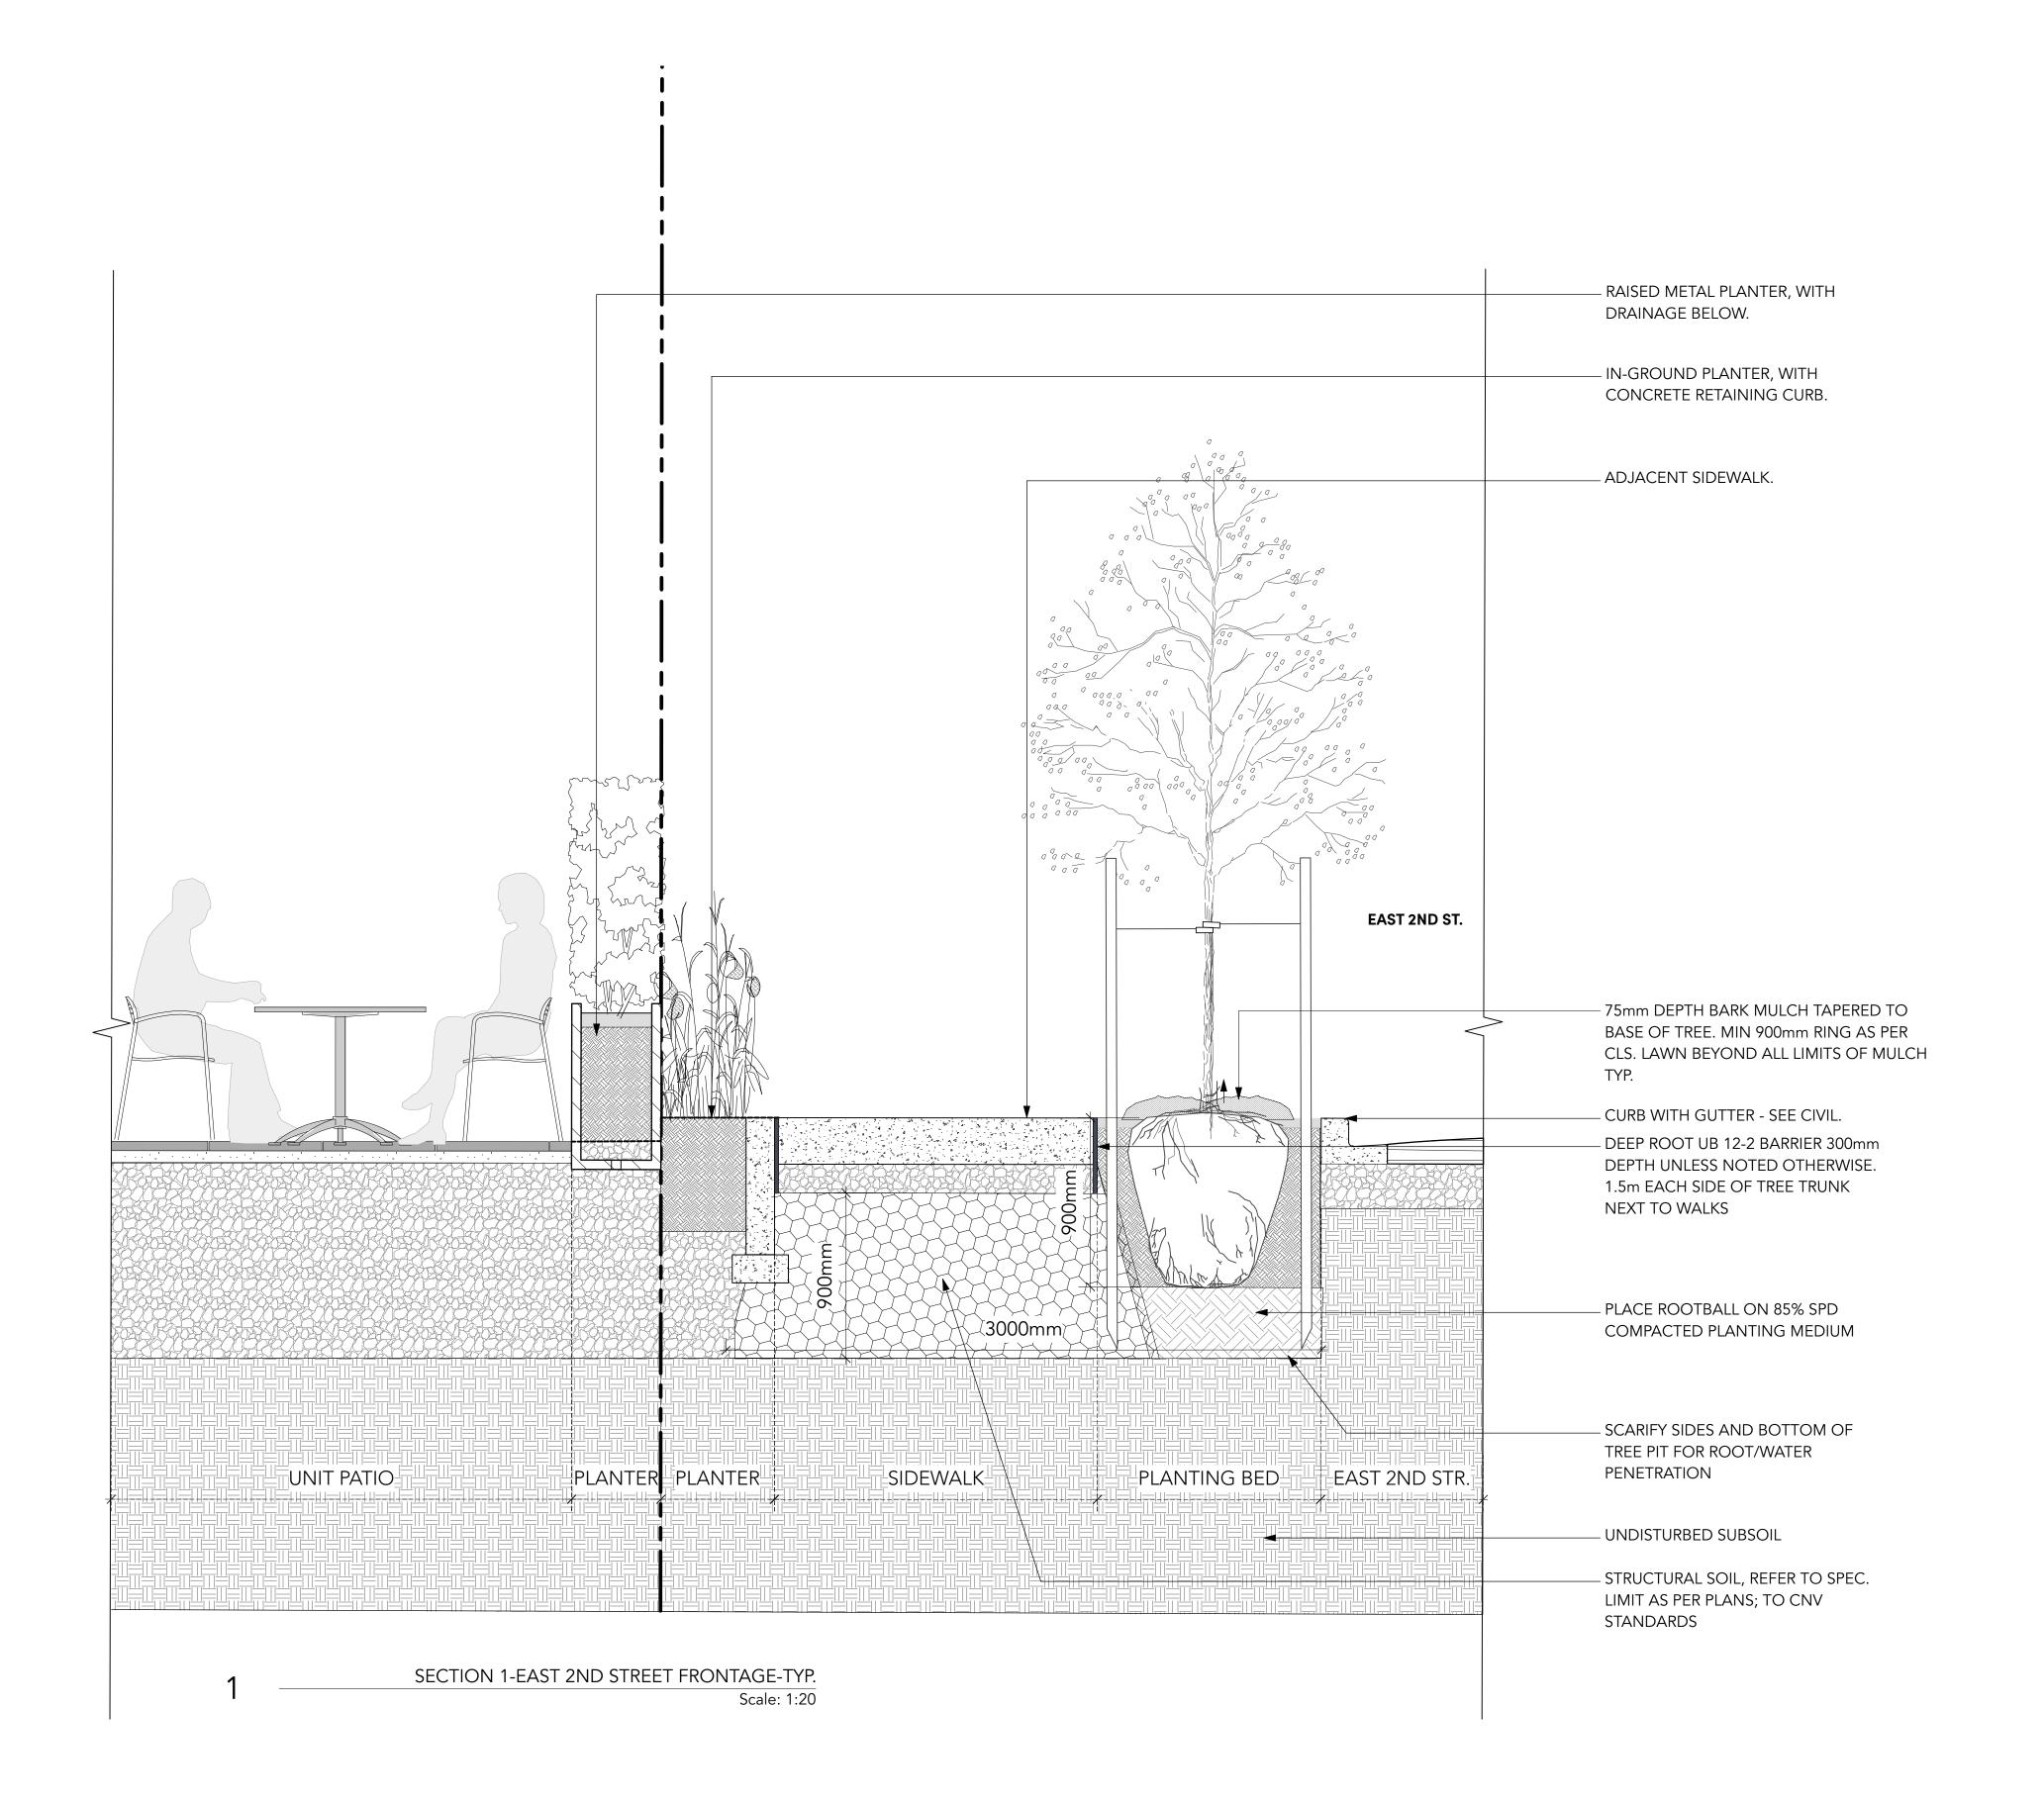

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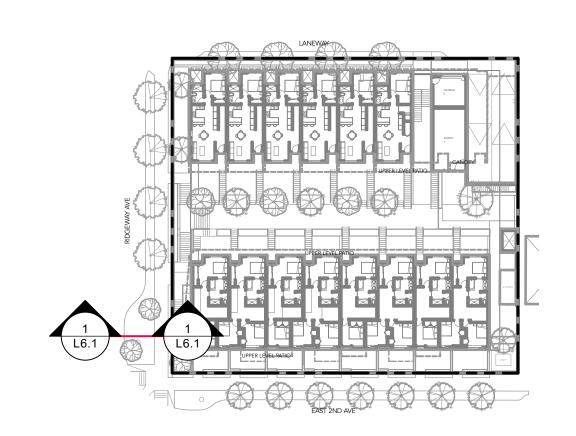
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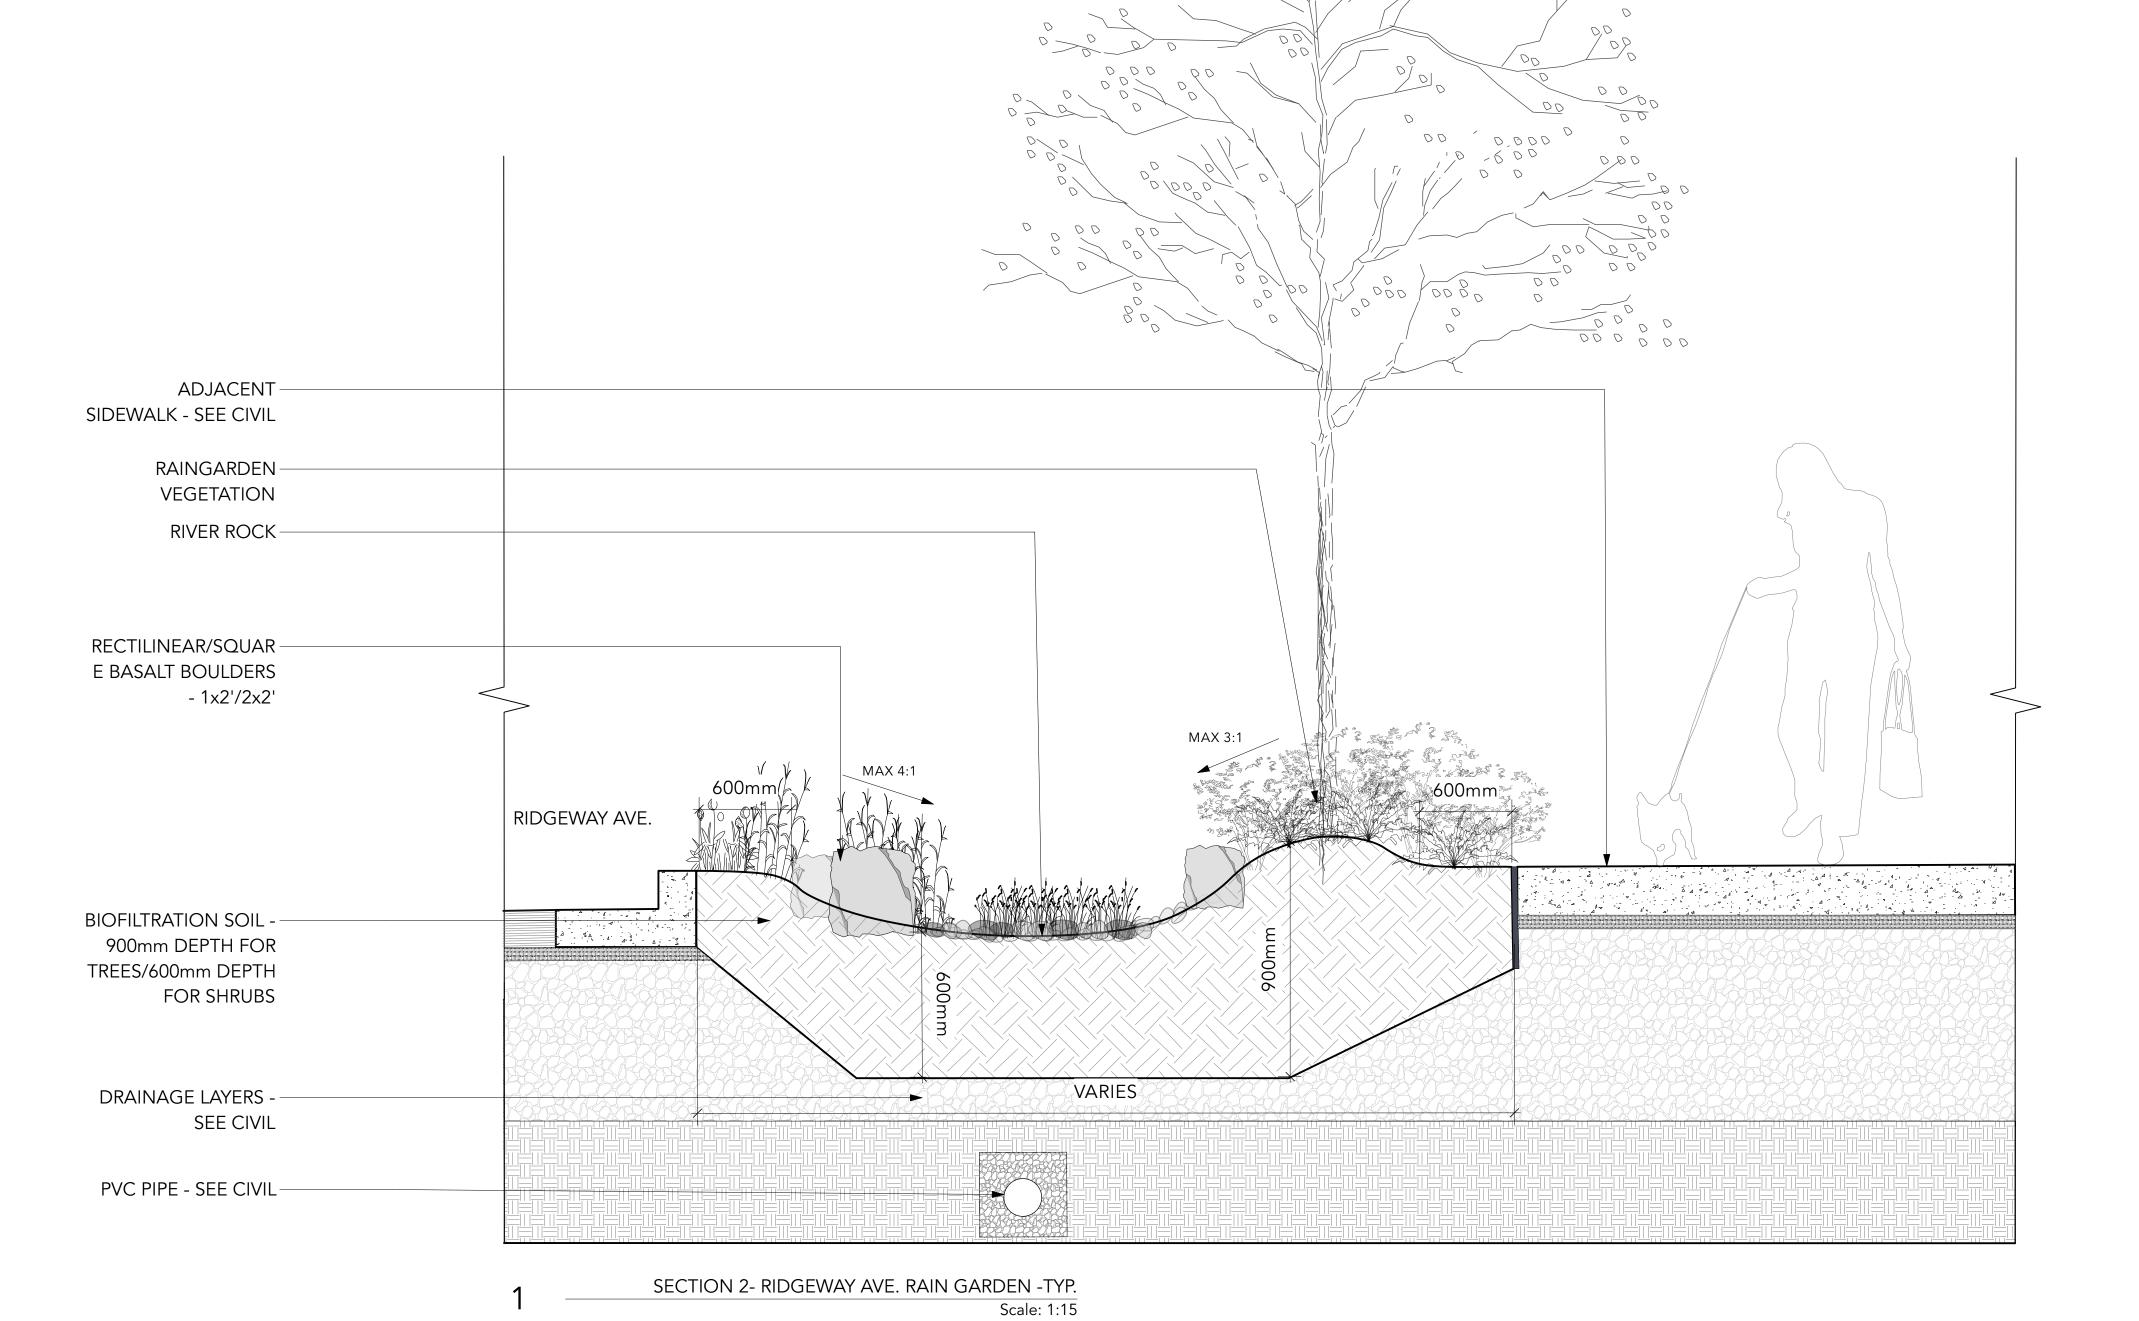
LANDSCAPE SECTIONS

L6.0



2 KEY PLAN





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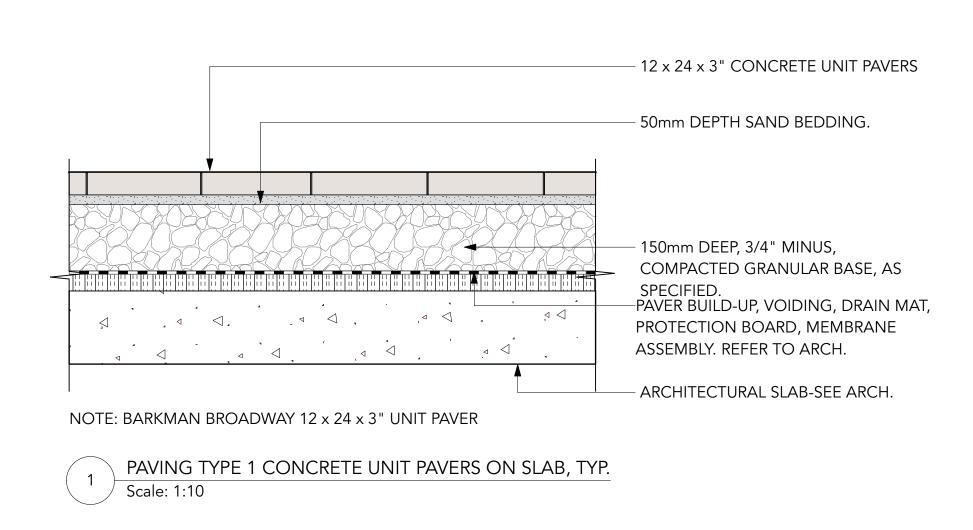
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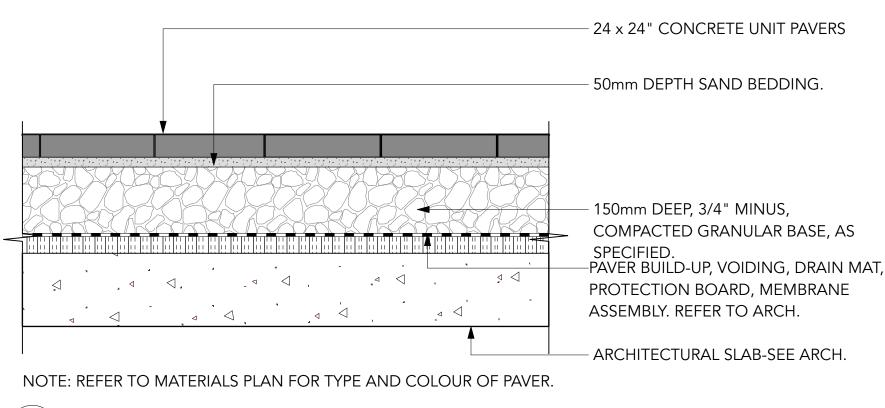
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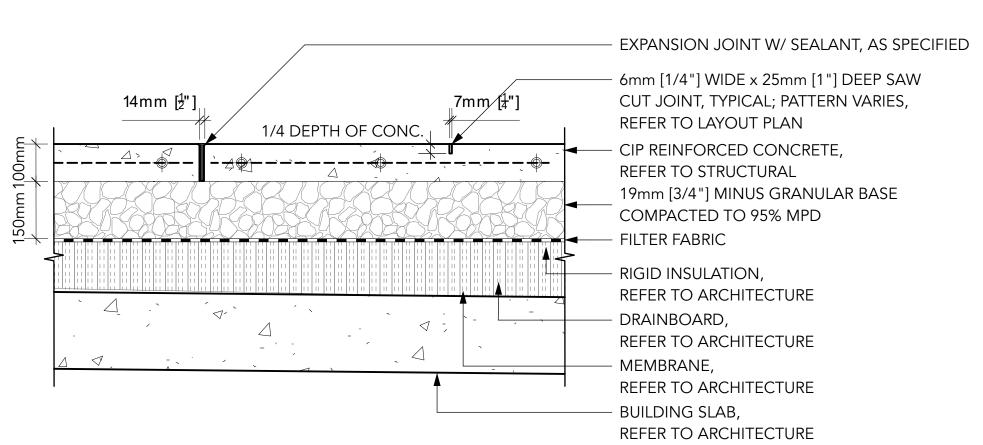
LANDSCAPE SECTIONS

L6.





PAVING TYPE 2 & 6: TEXADA PAVER ON SLAB, TYP Scale: 1:10





NOTES:

Scale: 1:10

- 1. TROWEL WITH LIGHT SANDBLAST
- 2. SEE TYPICAL LAYOUT PLAN FOR JOINT PATTERN AND BAND WIDTH
- 3. EXP. JOINTS 6096mm [20'0"] O.C. MAX (@ CURB, BUILDING EDGE CUT LINES, CHANGES IN MATERIALS. SPACING TO COINCIDE W/ PATTERN)
- 4. CONTROL JOINTS @ 1524mm [5'0"] O.C. MAX
- 5. FINAL LOCATIONS TO BE CONFIRMED ON SITE
- 6. STRUCTURAL ENGINEER TO CONFIRM DEPTH AND REINFORCEMENT

PAVING TYPE 3 & 4: CIP CONCRETE PAVING ON SLAB, TYP Scale: 1:10

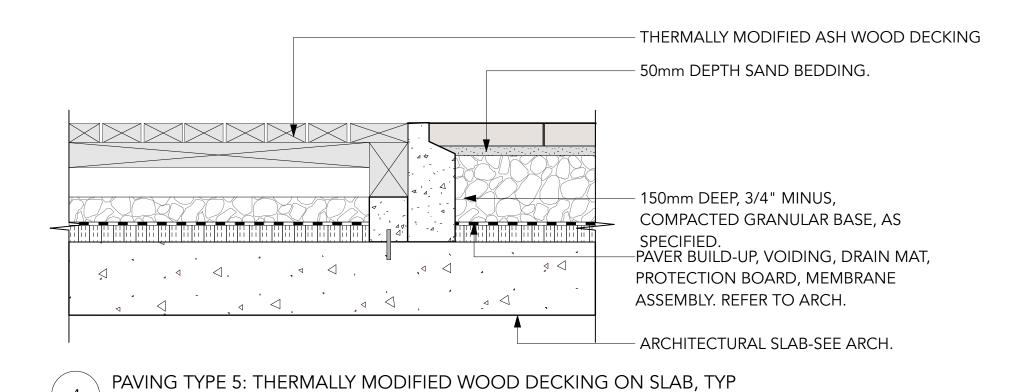

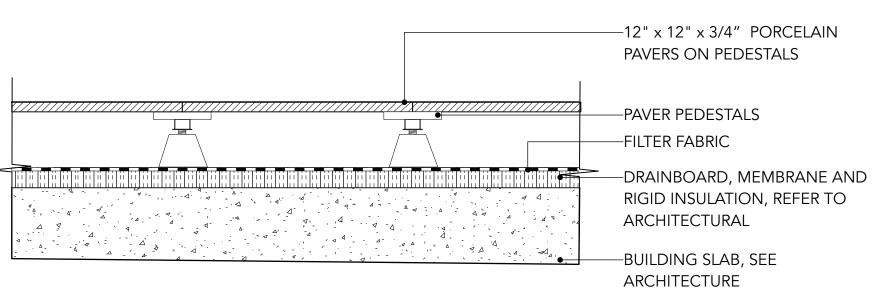

PAVING TYPE 7: PORCELAIN FAUX WOOD ON PEDESTALS ON SLAB, TYP Scale: 1:10



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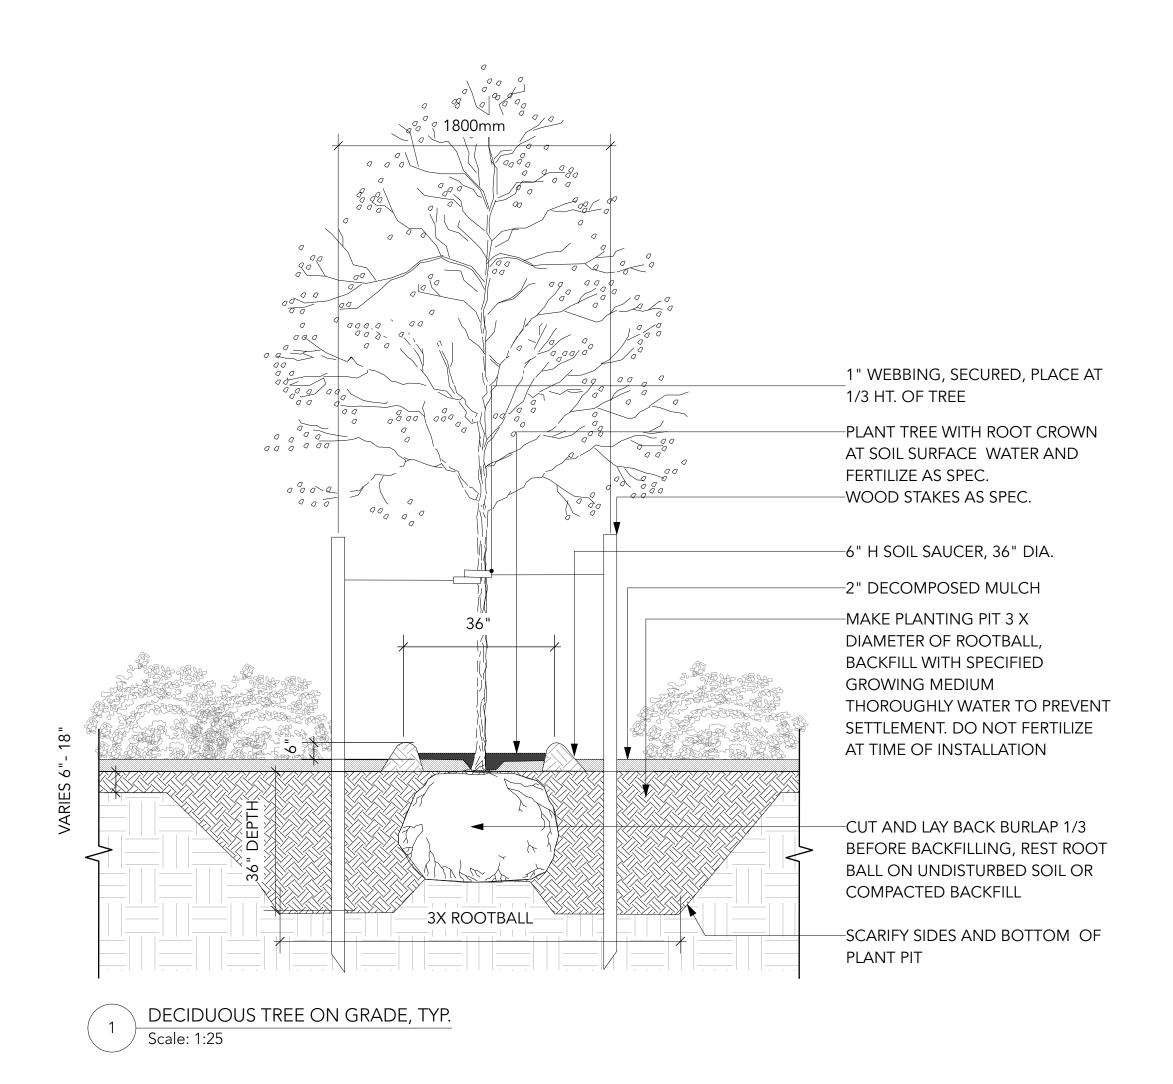
Landscape Architect


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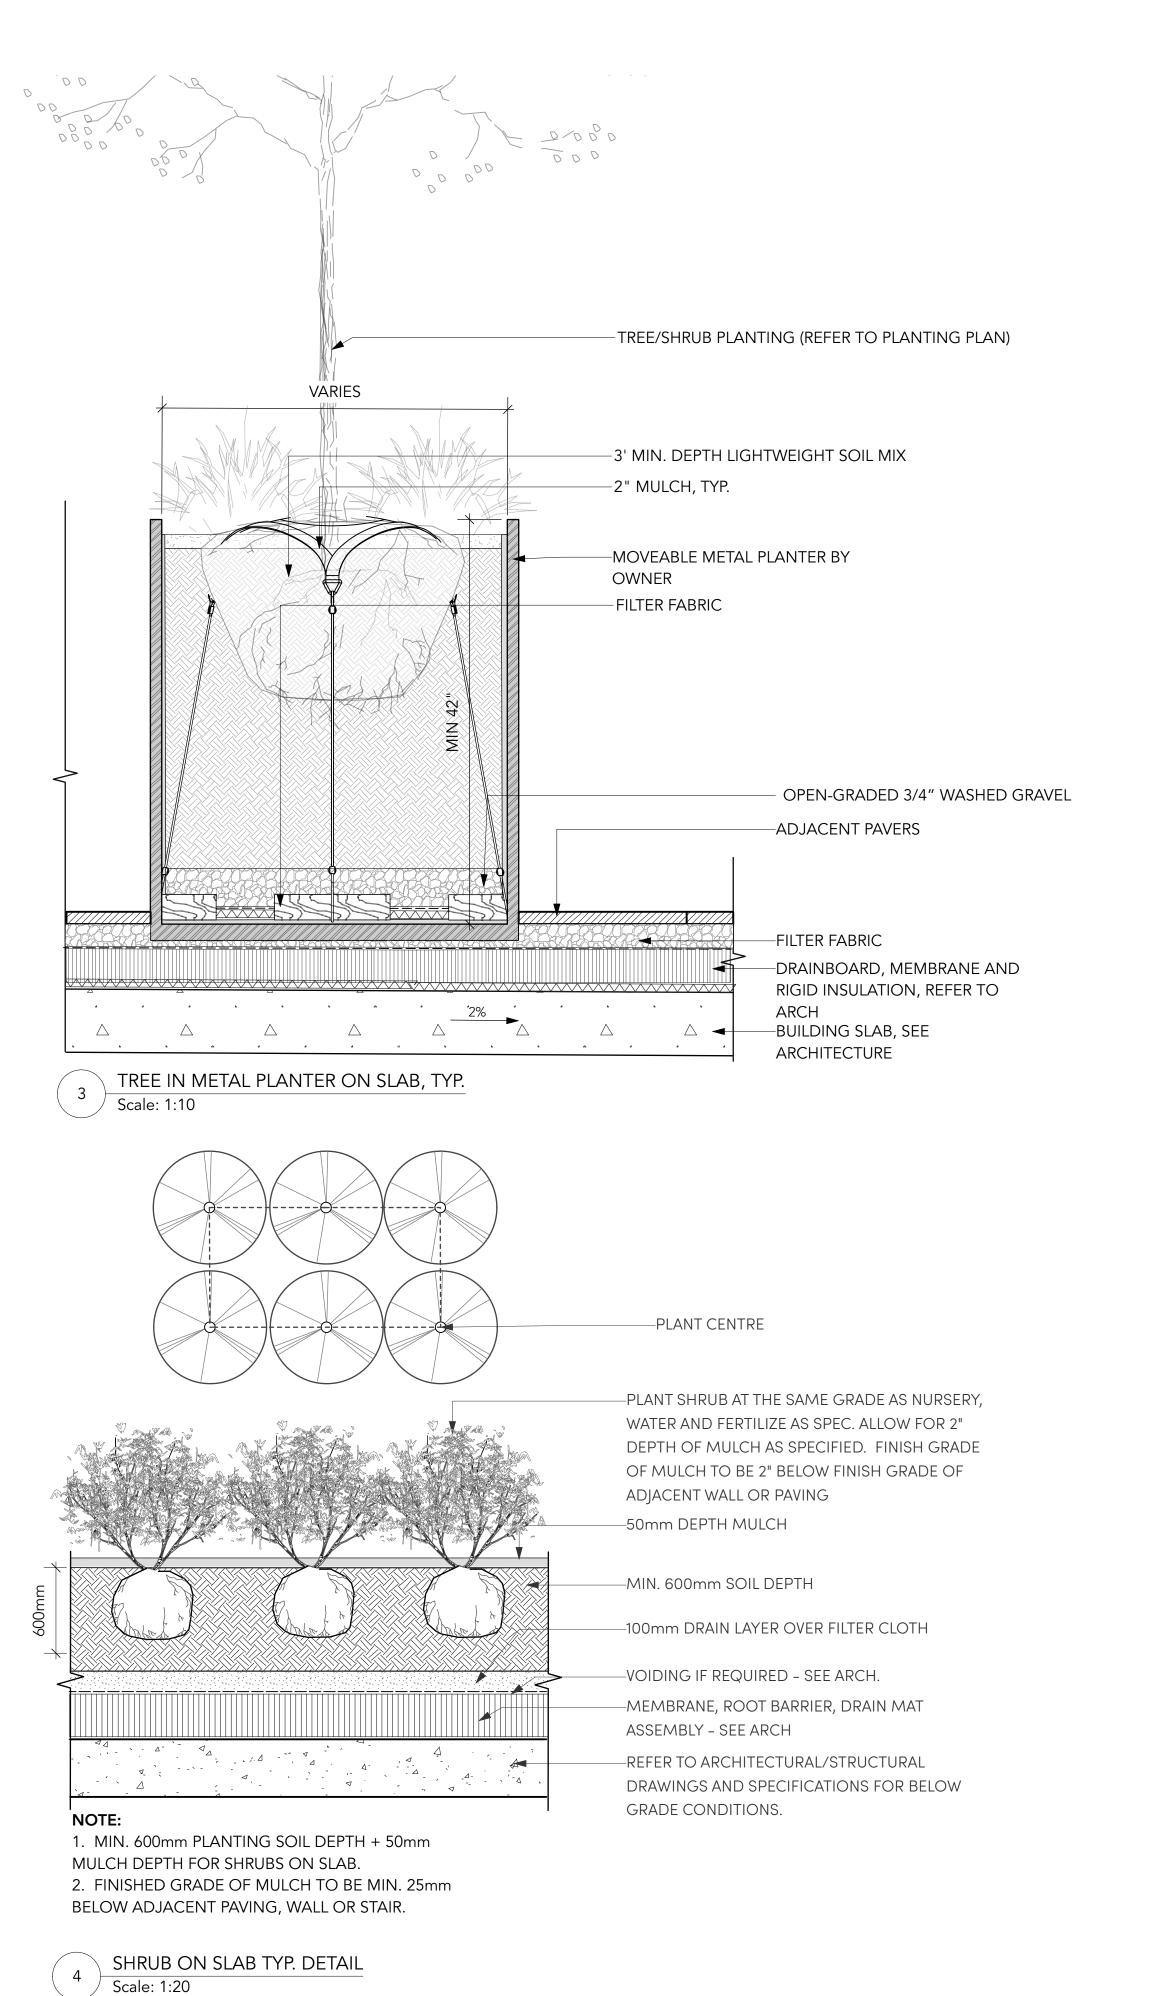
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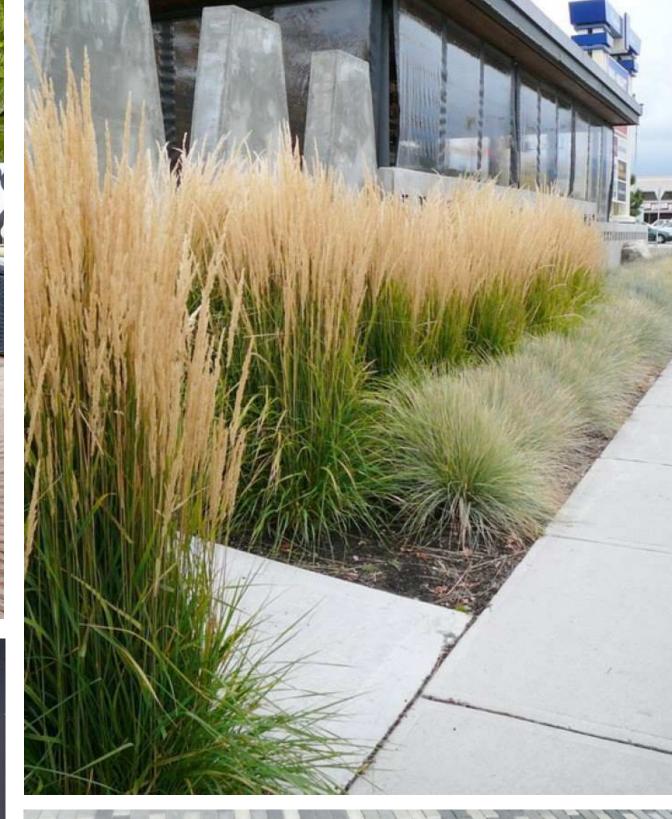
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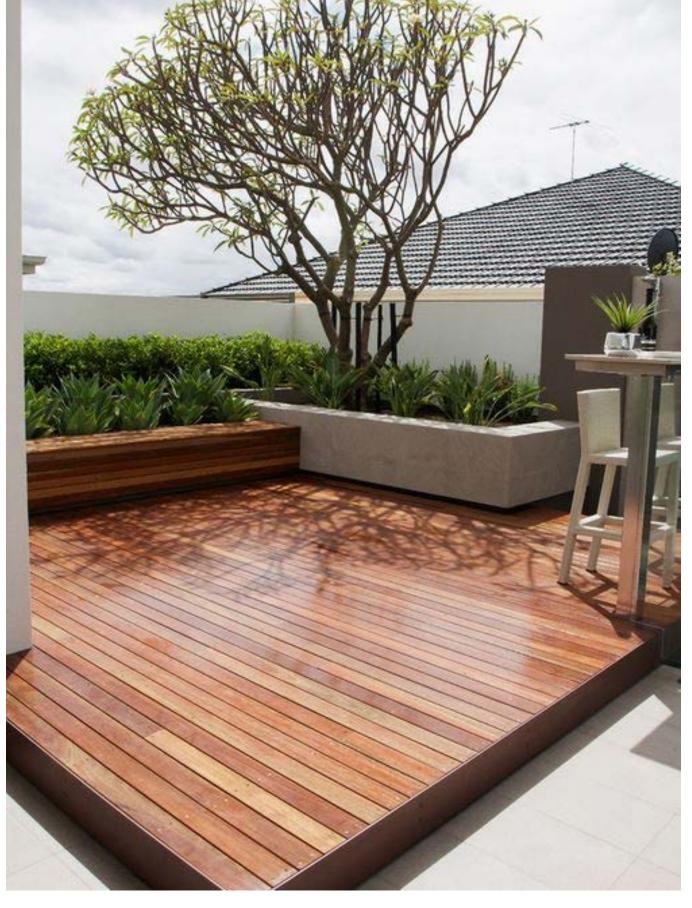











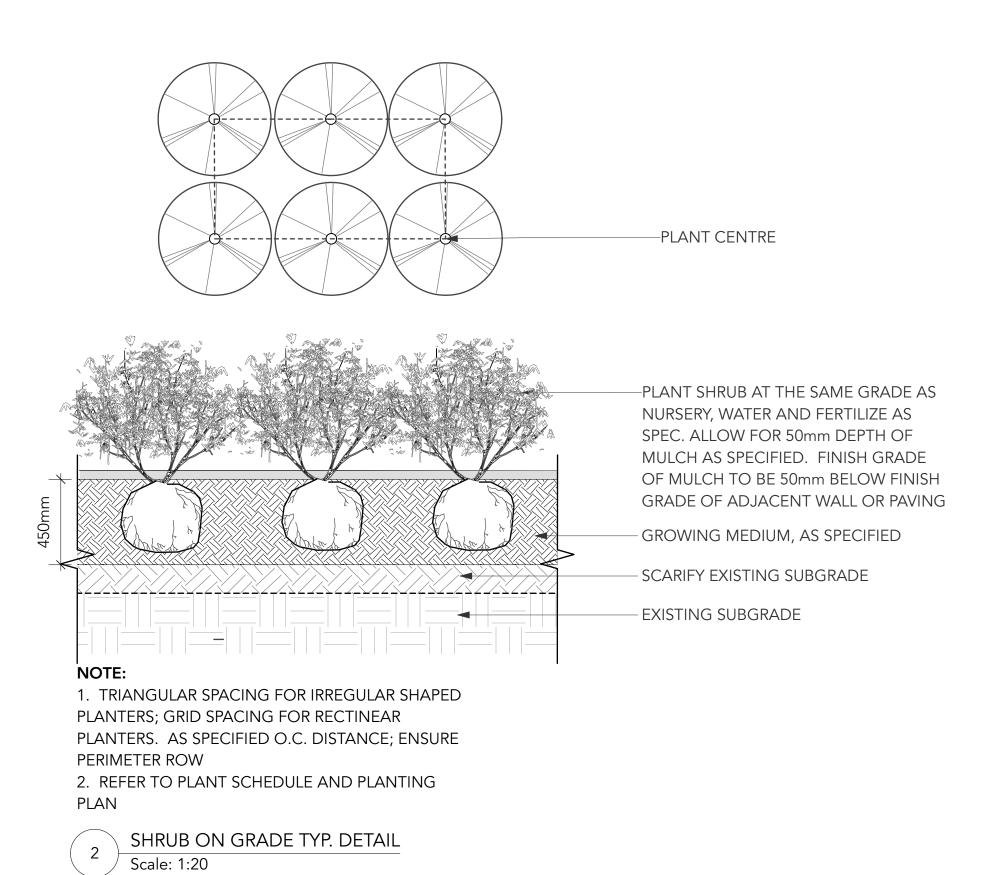

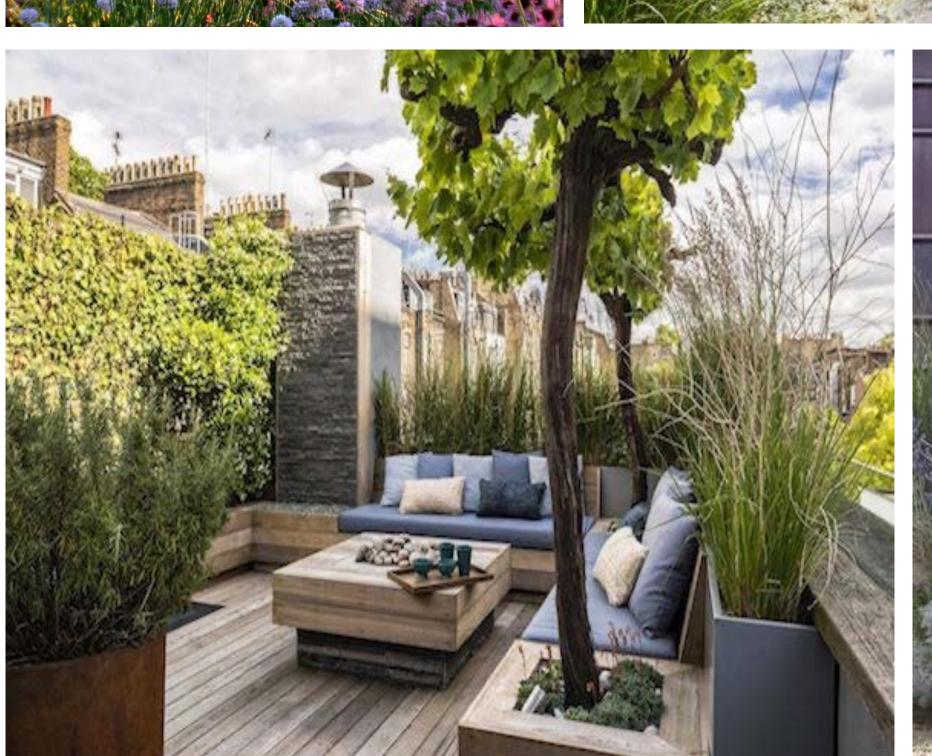





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