M3 TOWNHOMES

Development Permit Resubmission

CREO DEVELOPMENT LTD. // CLIENT

BEN FISHER ben@creodevelopments.ca 778.938.6227

SHAPE ARCHITECTURE // ARCHITECT

Dwayne Smyth d.smyth@shapearchitecture.ca 604.312.8258

Alex Russell a.russell@shapearchitecture.ca 778.735.1419

LOCI LANDSCAPE ARCHITECTURE + URBAN DESIGN // LANDSCAPE ARCHITECT

Mike Enns, BCSLA CSLA // Principal mike@locidesign.ca 604.763.2886

Chloé Brown // Project Coordinator chloe@locidesign.ca 519.288.1153

LANDSCAPE DRAWING INDEX PERMIT

Sheet No.	Sheet Name
L0.0	COVER SHEET
L0.1	TREE MANAGEMENT PLAN
L0.2	OVERALL LANDSCAPE PLAN
L1.0	MATERIALS + LAYOUT PLAN
L1.1	MATERIALS + LAYOUT PLAN - UPPER LEVE
L2.0	GRADING + SOIL DEPTH PLAN
L3.0	PLANTING PLAN - WEST
L3.1	PLANTING PLAN - EAST
L3.2	PLANTING PLAN - TREES OVERALL
L4.0	LIGHTING PLAN
L5.0	PLANT LIST + IMAGES
L6.0	LANDSCAPE SECTIONS
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L7.0	DETAILS
L7.1	DETAILS
L8.0	PRECEDENT IMAGES

GENERAL NOTES

- 1. ALL PLANTING SHALL BE IN ACCORDANCE WITH BC LANDSCAPE STANDARD, LATEST EDITION.
- 2. ALL PLANTING AREAS TO RECEIVE AUTOMATIC DRIP IRRIGATION, WITH TIME CLOCK AND RAIN SENSOR
- 3. ALL LANDSCAPE ARCHITECTURAL DRAWINGS IN THIS PACKAGE SHALL BE READ IN CONJUNCTION WITH ALL OTHER CONSULTANT DRAWINGS, DETAILS, SPECIFICATIONS, AND ANY OTHER CORRESPONDENCE THAT MAY BE ISSUED DURING THE COURSE OF THE CONTRACT.
- 4. IF A DISCREPANCY OCCURS BETWEEN THE DRAWINGS AND THE SPECIFICATIONS OR ANY OTHER DOCUMENT ASSOCIATED WITH THE PROJECT, THE CONFLICT SHALL BE REPORTED IN WRITING TO THE LANDSCAPE ARCHITECT TO OBTAIN CLARIFICATION AND APPROVAL BEFORE PROCEEDING WITH WORKS.
- 5. ALL EXISTING INFORMATION IS BASED ON AVAILABLE RECORDS AND SHALL NOT BE CONSTRUED TO BE COMPLETE OR ACCURATE.
- 6. THE CONTRACTOR SHALL VISIT THE SITE TO VERIFY THE TRUE EXISTING CONDITIONS. ANY UNCLEAR ISSUES SHALL BE CLARIFIED WITH THE CONSULTANT TEAM. NO CLAIM SHALL BE ALLOWED FOR EXTRAS WHICH MAY ARISE THROUGH NEGLECT OF THIS ADVICE.
- 7. THE CONTRACTOR IS RESPONSIBLE FOR DETERMINING THE EXISTENCE, LOCATION, AND ELEVATION OF ALL UTILITIES AND CONCEALED STRUCTURES, AND IS RESPONSIBLE FOR NOTIFYING THE APPROPRIATE COMPANY, DEPARTMENT OR PERSON(S) OF ITS INTENTION TO CARRY OUT ITS OPERATIONS.
- 8. LAYOUT OF PAVING, WALLS, SITE FURNITURE, SOIL, PLANTING, AND ALL OTHER LANDSCAPE MATERIALS IS TO BE STAKED OUT AND APPROVED BY THE LANDSCAPE ARCHITECT PRIOR TO INSTALLATION.
- 9. ALL DIMENSIONS AND ELEVATIONS ARE IN FEET UNLESS OTHERWISE NOTED.
 VERIFY ALL ELEVATIONS WITH FIELD CONDITIONS. REPORT ANY DISCREPANCIES
 TO CONSULTANT TEAM FOR REVIEW AND RESPONSE.
- 10. ALL UTILITIES TO BE STAKED OUT BY CONTRACTOR AND PROTECTED FOR DURATION OF CONSTRUCTION PERIOD.
- 11. PROTECT ALL EXISTING STRUCTURES
- 12. ALL SUBSTITUTIONS OF SPECIFIED MATERIALS TO BE APPROVED BY LANDSCAPE ARCHITECT.
- 13. FINAL OFFSITE PLANT SPACING, QUANTITY AND TREE PLACEMENT HAS BEEN REVIEWED TO THE SATISFACTION OF GENERAL MANAGER OF ENGINEERING SERVICES.
- 14. ALL WORKS ON CITY OF VANCOUVER PROPERTY TO BE AS PER THE CNV STREET RESTORATION MANUAL.
- 15. LOCI LANDSCAPE ARCHITECTURE + URBAN DESIGN DOES NOT GUARANTEE THE EXISTENCE, LOCATION, AND ELEVATION OF UTILITIES OR CONCEALED STRUCTURES AT THE PROJECT SITE.

GENERAL TREE PROTECTION FENCING TYP NOTES:

- 1. ALL COMPONENTS AND WORKMANSHIP TO CONFORM TO BCLNA STANDARDS TYPICAL.
- 2. POSITION TREE STAKES INTO DIRECTION OF PREVAILING WINDS IF MINIMUM UTILITY SETBACKS PERMIT.
- 3. ALL TREE STAKES TO HAVE A MINIMUM 1.0m CLEARANCE FROM ALL U/G POWER, TELEPHONE AND GAS ALIGNMENTS.
- 4. ALL ROOTBALL HOLES TO BE DUG BY HAND WHEN CLOSER TO 1.0M (40") TO U/G POWER, TELEPHONE AND GAS ALIGNMENTS. FOR TREES WITH DRIPLINES FROM FROM 3M 5M (9' 15') FROM CONSTRUCTION ACTIVITY;
- 5. PLACE STANDARD 'SAFETY ORANGE' SNOWFENCE MIN. OF 4.5M (14'8") FROM TREE TRUNK. EXACT SIZE/SHAPE TO BE DETERMINED ON SITE
- 6. FOR EXCAVATION WITHIN 1-3M (3' 9') OF ANY TREE'S DRIPLINE, ROOT PRUNING REQUIRED TO A DEPTH OF 500MM (20"). IMMEDIATELY AFTER EXCAVATION, PRUNE ALL EXPOSED ROOTS FLUSH WITH THE EXCAVATION WALL
- 7. A MAXIMUM OF 25% OF ANY TREE'S ROOTS AT THE DRIPLINE SHOULD BE IMPACTED BY EXCAVATION IF THE TREE IS EXPECTED TO SURVIVE.
- 8. INSTALL AND MAINTAIN HOARDING IN CLEAN AND SAFE CONDITION THROUGHOUT CONSTRUCTION PROCESS.
- 9. HOARDING REQUIREMENTS ARE ON ALL EXISTING TREES THROUGHOUT CONSTRUCTION. ALL EQUIPMENT, SOIL, BUILDING MATERIAL AND OTHER DEBRIS SHALL BE KEPT OUTSIDE THE HOARDING.
- 10.IF HOARDING IS PUNCTURED AND DAMAGE OCCURS TO HOARDED TREE(S), NOTIFY LANDSCAPE ARCHITECT.
- 11. THE BEST METHOD TO AVOID SOIL COMPACTION IS TO KEEP OFF. THIS INCLUDES RESTRICTING ALL TRAFFIC BOTH VEHICULAR AND PEDESTRIAN FROM CROSSING OVER THE ROOT ZONES, AND RESTRICTING EVEN TEMPORARY MATERIAL STORAGE UNDER TREES.
- 12. EXCAVATION AROUND TREES WITHIN DRIP LINE OF TREES ONLY WHERE INDICATED ON PLANS AND AS DIRECTED BY THE CONSULTANT.
- 13. DURING ANY EXCAVATION WITHIN THE DRIP LINE OF A TREE THE CONTRACTOR SHALL EXCAVATE AROUND TREE ROOTS AS DIRECTED BY THE CONSULTANT. DO NOT CUT TREE ROOTS UNLESS DIRECTED BY THE CONSULTANT.
- 14. TREES AND OTHER DESIRABLE VEGETATION TO BE TOTALLY FENCED. FENCING TO BE MAINTAINED FOR THE DURATION OF THE PROJECT.
- HAND EXCAVATE TO MINIMIZE DAMAGE TO ROOT SYSTEMS
- 16. USE NARROW TINE SPADING FORKS TO PROBE AND COMB SOIL TO EXPOSE ROOTS;

15. EXCAVATION FOR NEW CONSTRUCTION WITHIN THE DRIP LINES OF TREES:

- 17. RELOCATE ROOTS INTO BACKFILL AREAS WHENEVER POSSIBLE. IF LARGE MAIN LATERAL ROOTS ARE ENCOUNTERED, EXPOSE BEYOND EXCAVATION LIMITS AS REQUIRED TO BEND AND RELOCATE WITHOUT BREAKING.
- 18. UTILITY TRENCHING WITHIN THE DRIP LINES OF TREES: TUNNEL UNDER AND AROUND ROOTS BY HAND DIGGING;
- 19. DO NOT CUT MAIN LATERAL ROOTS;
- 20.CUTTING OF SMALLER ROOTS THAT INTERFERE WITH INSTALLATION OF NEW WORK SHALL BE DONE WITH CLEAN SHARP TREE PRUNING TOOLS;
- 21. ROOTS THAT ARE ENCOUNTERED IMMEDIATELY ADJACENT TO THE LOCATION OF NEW CONSTRUCTION AND ARE TOO DIFFICULT TO RELOCATE SHALL BE CUT 150MM (6") BACK FROM NEW CONSTRUCTION. USE CLEAN SHARP TREE PRUNING TOOLS;
- 22.PROTECTION OF EXPOSED ROOTS: DO NOT ALLOW EXPOSED ROOTS TO DRY OUT PRIOR TO PLACEMENT OF PERMANENT COVER.
- 23.PROVIDE ONE OF THE FOLLOWING TEMPORARY REMEDIAL MEASURES:
- 24.A. PROVIDE TEMPORARY EARTH COVER. MAINTAIN MOISTURE.
 B. PACK WITH WET PEAT MOSS. MAINTAIN MOISTURE.
 C. PACK WITH FOUR LAYERS OF WET UNTREATED BURLAP. MAINTAIN MOISTURE.
- 25.TEMPORARILY SUPPORT AND PROTECT EXPOSED ROOTS FROM DAMAGE UNTIL PERMANENTLY RELOCATED AND COVERED WITH BACKFILL.
- 26.WATER PUDDLE BACKFILL AROUND ROOTS TO ELIMINATE VOIDS AND AIR POCKETS
- 27. REMOVAL OF STREET TREES TO THE SATISFACTION OF THE GENERAL MANAGER OF ENGINEERING SERVICES.



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Project Stamp



Issue

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A ISSUED FOR SCHEMATIC 22-01-24
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Landscape Architect

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Checked By

Checked


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COVER SHEET

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revision



TREE MANAGEMENT PLAN

Scale: 1:150
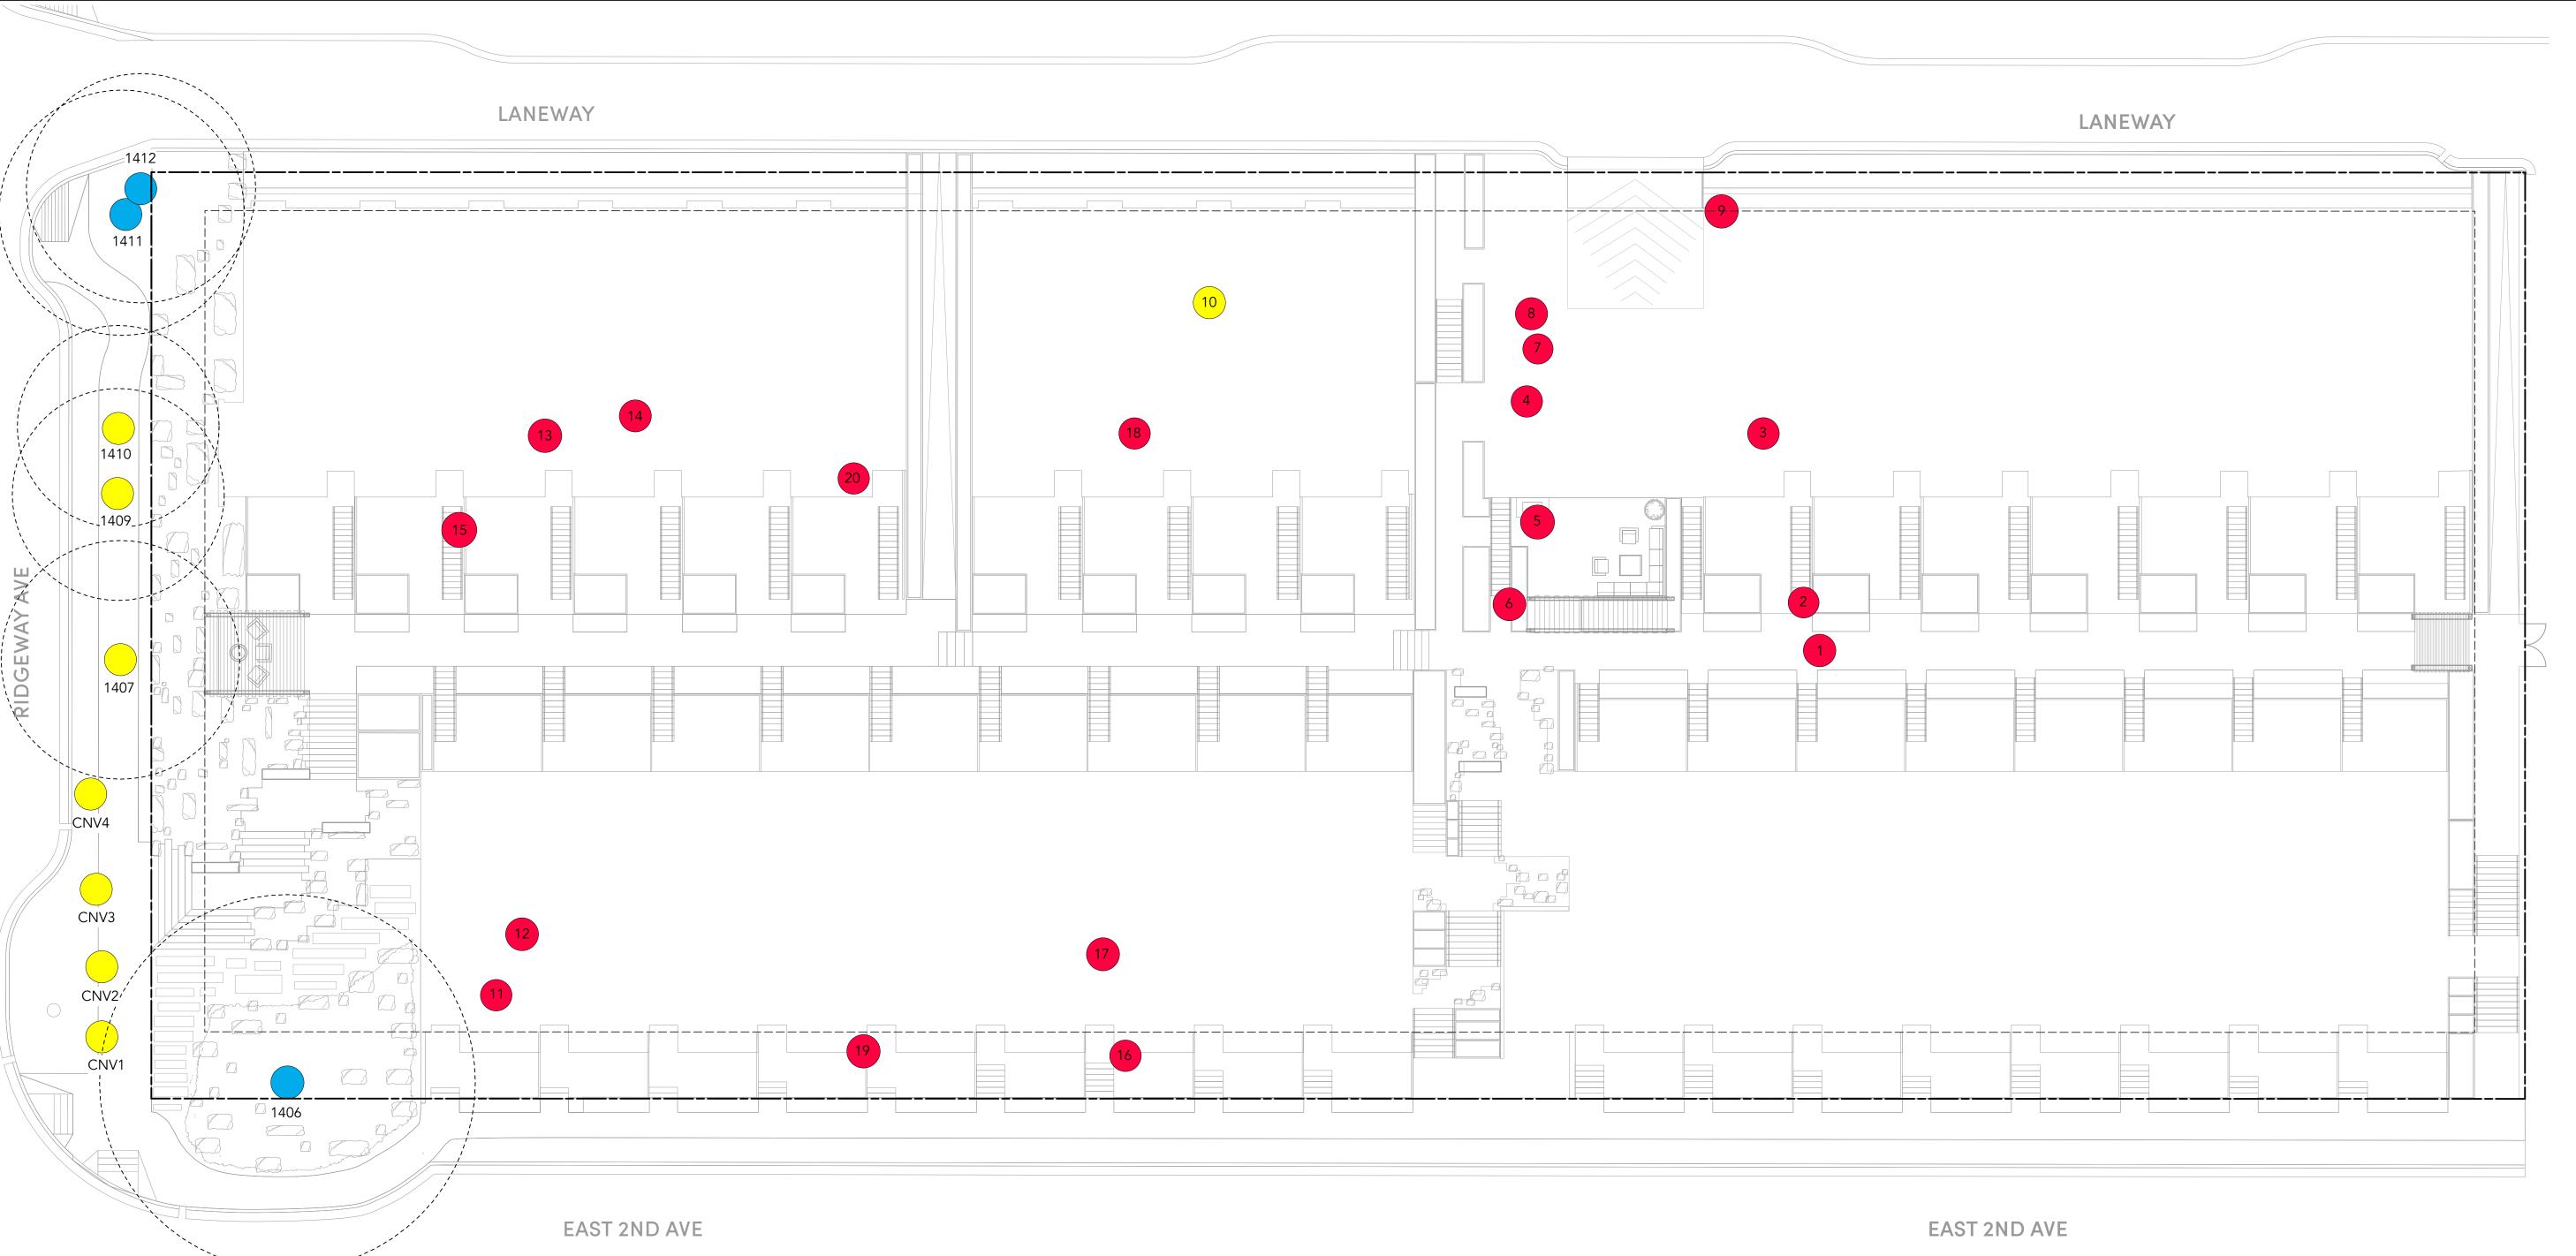
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TREE MANAGEMENT PLAN - REFER TO ARBORIST REPORT

SYMBOL DESCRIPTION

REMOVE WITH CONSENT



REMOVE

PLEASE REFER TO ARBORIST REPORT FOR FURTHER INFORMATION



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Shape Architecture


Landscape Architect

LOCI Landscape Architecture + Urban Design

Drawn ByChecked ByDrawn ByChecked

TREE MANAGEMENT PLAN


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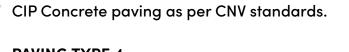
- DRAINAGE STRUCTURES. MAXIMUM 3:1 SLOPE IN SOFT LANDSCAPE AREAS.
- 4. THE LAYOUT OF ALL HARDSCAPE ITEMS, SITE FURNISHINGS, BOULDERS, LANDSCAPE LIGHTING, PLANTING BEDS AND OTHER MATERIALS IS TO BE STAKED OUT BY THE CONTRACTOR AND APPROVED BY THE LANDSCAPE ARCHITECT PRIOR TO INSTALLATION.
- 5. ALL SUBSTITUTIONS OF SPECIFIED MATERIALS TO BE APPROVED BY LANDSCAPE ARCHITECT.

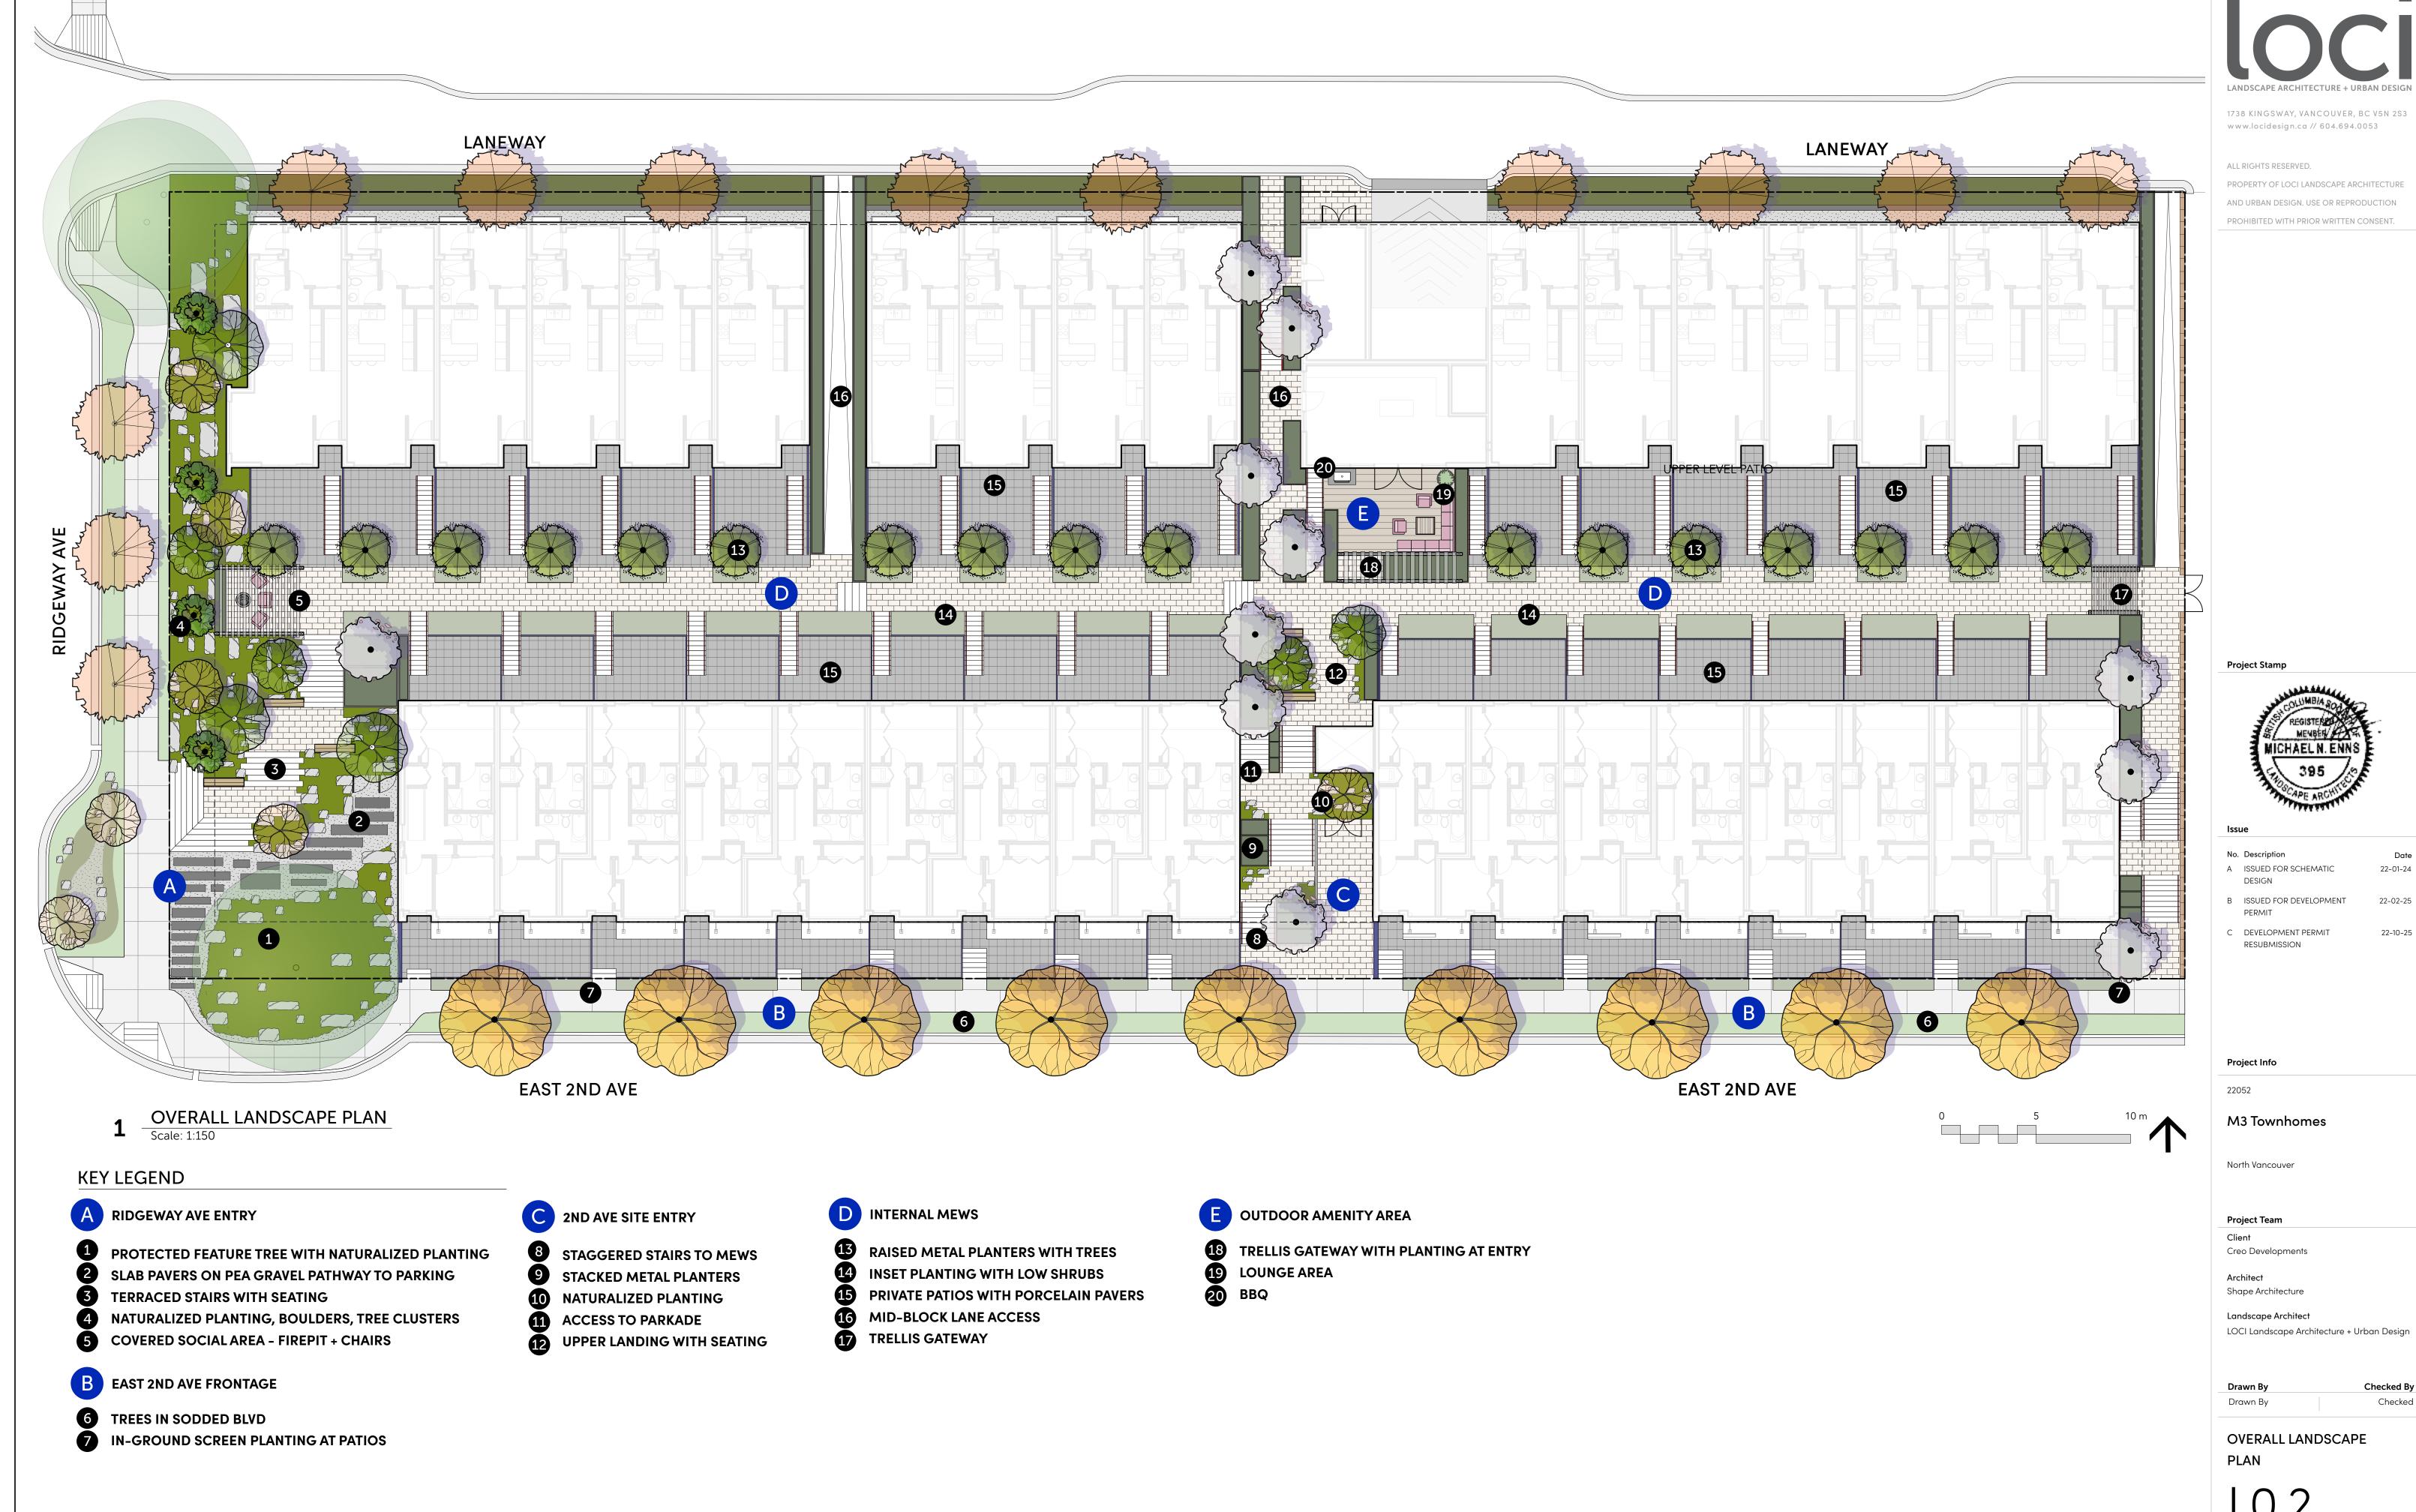
24 x 24" Porcelain Pavers on Pedestals + Seed Tray.







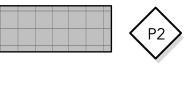


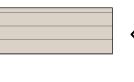

PAVING TYPE 4 8 x 48" NOON Belgard Faux Wood Porcelain Tile on




Basalt Slabs (Size Varies) On Birds Eye Gravel 4" Depth. L7.0

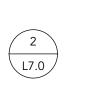


3 L7.0





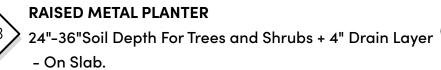

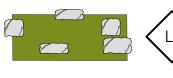


NATURALIZED PLANTED AREA 12–36"Soil Depth for Trees and Shrubs w/ Boulder Clusters.

L7.1





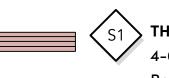

> THERMALLY MODIFIED WOOD BENCHES 4-6' Length Maglin Odgen series, Straight, Backless Benches w/ Concrete Footings.

See Arch.

CONCRETE STAIRCASE CIP Concrete Staircase with handrail - See Arch.

FEATURE TRELLIS STRUCTURES Product TBD - See Arch.



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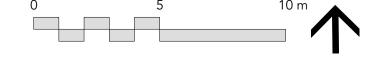
Shape Architecture Landscape Architect

LOCI Landscape Architecture + Urban Design

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MATERIALS + LAYOUT PLAN






GENERAL LAYOUT + MATERIALS NOTES:

- 1. ALL DIMENSIONS ARE METRIC UNLESS OTHERWISE NOTED. VERIFY ALL DIMENSIONS WITH FIELD CONDITIONS. REPORT ANY DISCREPANCIES TO LANDSCAPE ARCHITECT FOR REVIEW AND RESPONSE.
- 2. ALL UTILITIES TO BE STAKED OUT BY CONTRACTOR AND PROTECTED FOR DURATION OF CONSTRUCTION PERIOD.
- 3. UNLESS OTHERWISE NOTED, PROVIDE A MINIMUM 2% SLOPE ON ALL HARD AND SOFT LANDSCAPE AREAS TO ENSURE POSITIVE DRAINAGE AWAY FROM BUILDINGS OR TO DRAINAGE STRUCTURES. MAXIMUM 3:1 SLOPE IN SOFT LANDSCAPE AREAS.
- 4. THE LAYOUT OF ALL HARDSCAPE ITEMS, SITE FURNISHINGS, BOULDERS, LANDSCAPE LIGHTING, PLANTING BEDS AND OTHER MATERIALS IS TO BE STAKED OUT BY THE CONTRACTOR AND APPROVED BY THE LANDSCAPE ARCHITECT PRIOR TO INSTALLATION.
- 5. ALL SUBSTITUTIONS OF SPECIFIED MATERIALS TO BE APPROVED BY LANDSCAPE ARCHITECT.

MATERIALS LEGEND - UPPER LEVEL

SYMBOL KEY DESCRIPTION

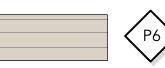




PAVING TYPE 6 8 x 48" NOON Belgard Faux Wood Porcelain Tile on



DETAIL

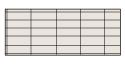




Texada - Natural. Pattern: Stack bond.

24 x 24" Porcelain Pavers on Pedestals.



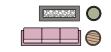

OUTDOOR FURNITURE By Owner.

PAVING TYPE 7

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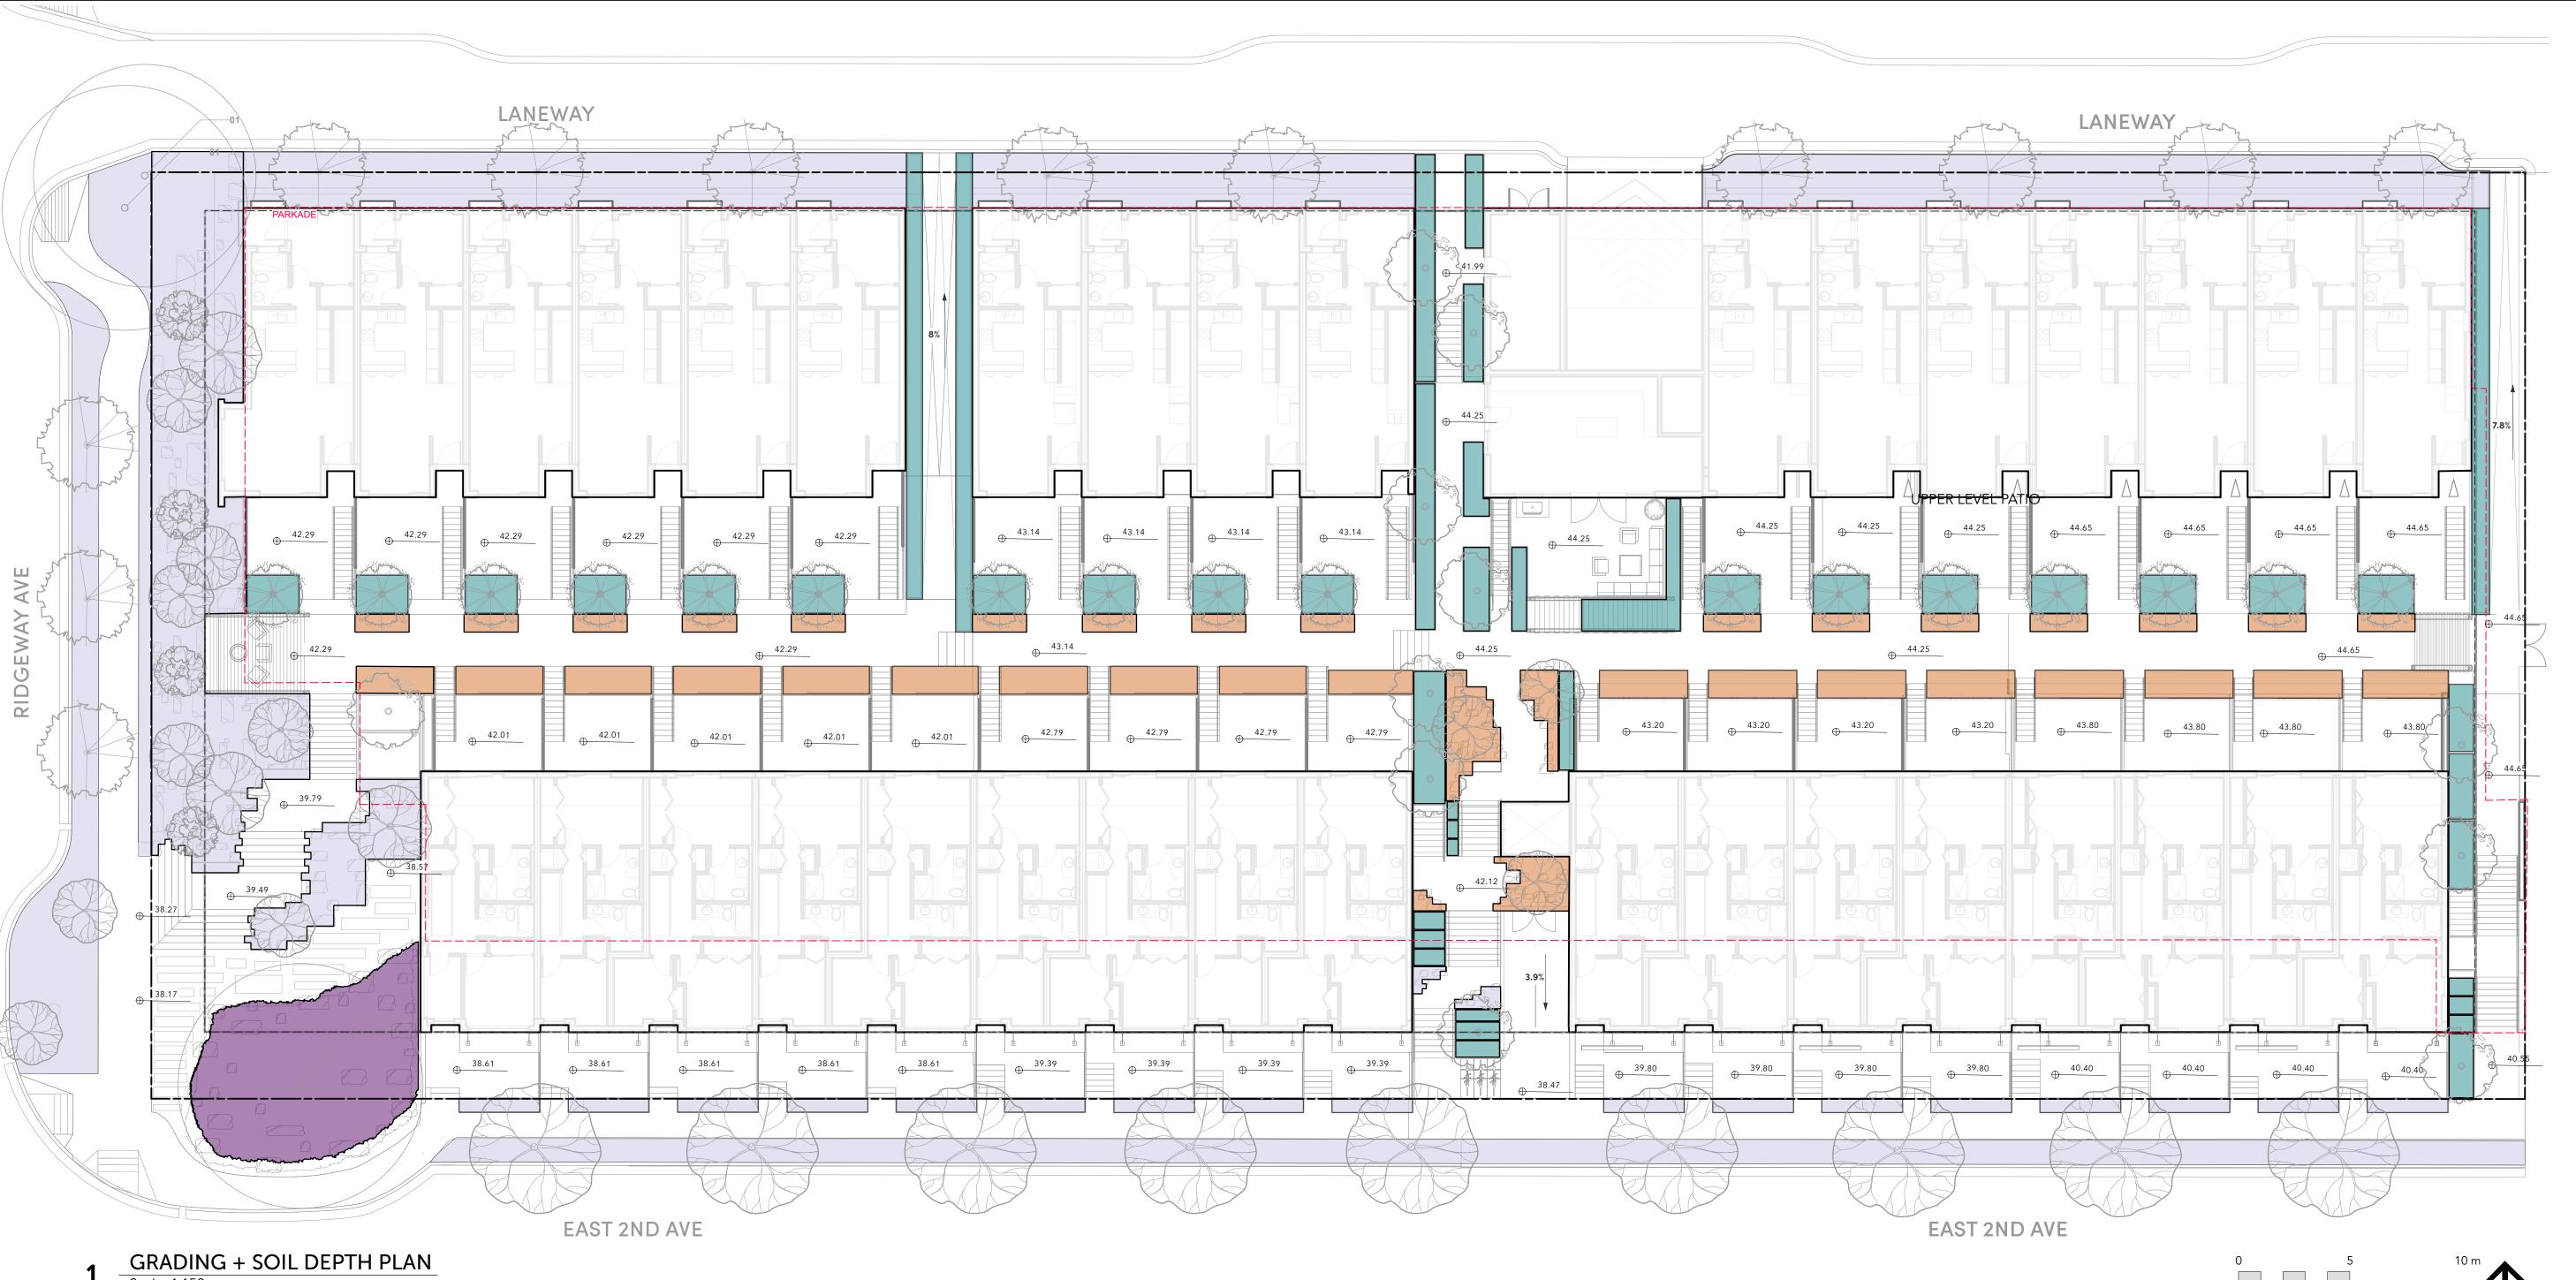
Shape Architecture

Landscape Architect

LOCI Landscape Architecture + Urban Design

Checked By Drawn By Checked

MATERIALS + LAYOUT PLAN - UPPER LEVEL



GENERAL GRADING NOTES:

- 1. ALL UTILITIES TO BE STAKED OUT BY CONTRACTOR AND PROTECTED FOR DURATION OF CONSTRUCTION PERIOD.
- 2. UNLESS OTHERWISE NOTED, PROVIDE A MINIMUM 2% SLOPE ON ALL HARD AND SOFT LANDSCAPE AREAS TO ENSURE POSITIVE DRAINAGE AWAY FROM BUILDINGS OR TO DRAINAGE STRUCTURES. MAXIMUM 3:1 SLOPE IN SOFT LANDSCAPE AREAS.
- 3. THE LAYOUT OF ALL PROPOSED HARDSCAPE ITEMS, SITE FURNITURE, LIGHTING, PLANTING BEDS AND OTHER MATERIALS IS TO BE STAKED OUT BY THE CONTRACTOR AND APPROVED BY THE LANDSCAPE ARCHITECT PRIOR TO INSTALLATION.
- 4. ALL SUBSTITUTIONS OF SPECIFIED MATERIALS TO BE APPROVED BY LANDSCAPE ARCHITECT.
- 5. REFER TO CIVIL FOR EXCAVATION DEPTHS, BACKFILL, AND BASE MATERIAL FOR ALL LANDSCAPE ITEMS SHOWN ON PLAN.
- 6. SLOPE SHALL MATCH EXISTING GRADE ALONG ALL PROPERTY LINES.
- 7. REFER TO CIVIL ENGINEER'S PRECISE GRADING PLANS FOR SITE GRADING PLANS FOR SITE GRADING, DRAINAGE, AND UTILITY LOCATIONS. IF ACTUAL SITE CONDITIONS VARY FROM WHAT IS SHOWN ON THE LANDSCAPE ARCHITECT'S PLANS, THE CONTRACTOR SHALL CONTACT THE OWNER'S REPRESENTATIVE AND LANDSCAPE ARCHITECT FOR DIRECTION AS TO HOW TO PROCEED.

- 8. THE CONTRACTOR IS RESPONSIBLE FOR VERIFYING THE ACTUAL LOCATION AND ELEVATION IN THE FIELD PRIOR TO BEGINNING CONSTRUCTION. THE CONTRACTOR SHALL PROTECT ALL EXISTING UTILITIES AND SHALL BE RESPONSIBLE FOR ANY DAMAGE TO EXISTING UTILITIES ENCOUNTERED DURING CONSTRUCTION.
- 9. ALL PROPOSED GRADES ARE TO MEET AND BLEND IN WITH EXISTING GRADING AT PROJECT LIMITS, GRADING LIMITS, AND EXISTING SIDEWALK. PRECISE ELEVATIONS INDICATED ON PLANS TO BE VERIFIED IN FIELD TO AS-BUILT CONDITION.
- 10.THE DEBRIS CREATED BY LANDSCAPE GRADING OPERATIONS SHALL BECOME THE PROPERTY OF THE CONTRACTOR AND SHALL BE DISPOSED OF LEGALLY OFF SITE.
- 11. FINAL GRADING SHALL BE REVIEWED BY THE LANDSCAPE ARCHITECT IN THE FIELD PRIOR TO INSTALLATION OF PLANTING.

GRADING LEGEND

SYMBOL DESCRIPTION

⊕ 38.18 ARCHITECTURAL ELEVATION - BY ARCH

SLOPE AND DIRECTION - BY ARCH

*FOR INFO ONLY SEE ARCH FOR ALL GRADES

* The state of the s

SOIL DEPTH LEGEND

SYMBOL DESCRIPTION

TREE + SHRUB PLANTING IN METAL PLANTERS ON SLAB
24-36" Soil Depth + 4" Drainage Layer

IN-GROUND SHALLOW PLANTING ON SLAB
12-30" Depth; Low Groundcover with Low Berms for

Small Trees.

INSET PLANTING ON GRADE

18-36" Soil Depth for Trees + Shrubs.

IN-GROUND SHALLOW PLANTING IN PROTECTED TREE ZONE
4-6" Soil for Groundcovers + Grass Plugs

LANDSCAPE ARCHITECTURE + URBAN DESIGN

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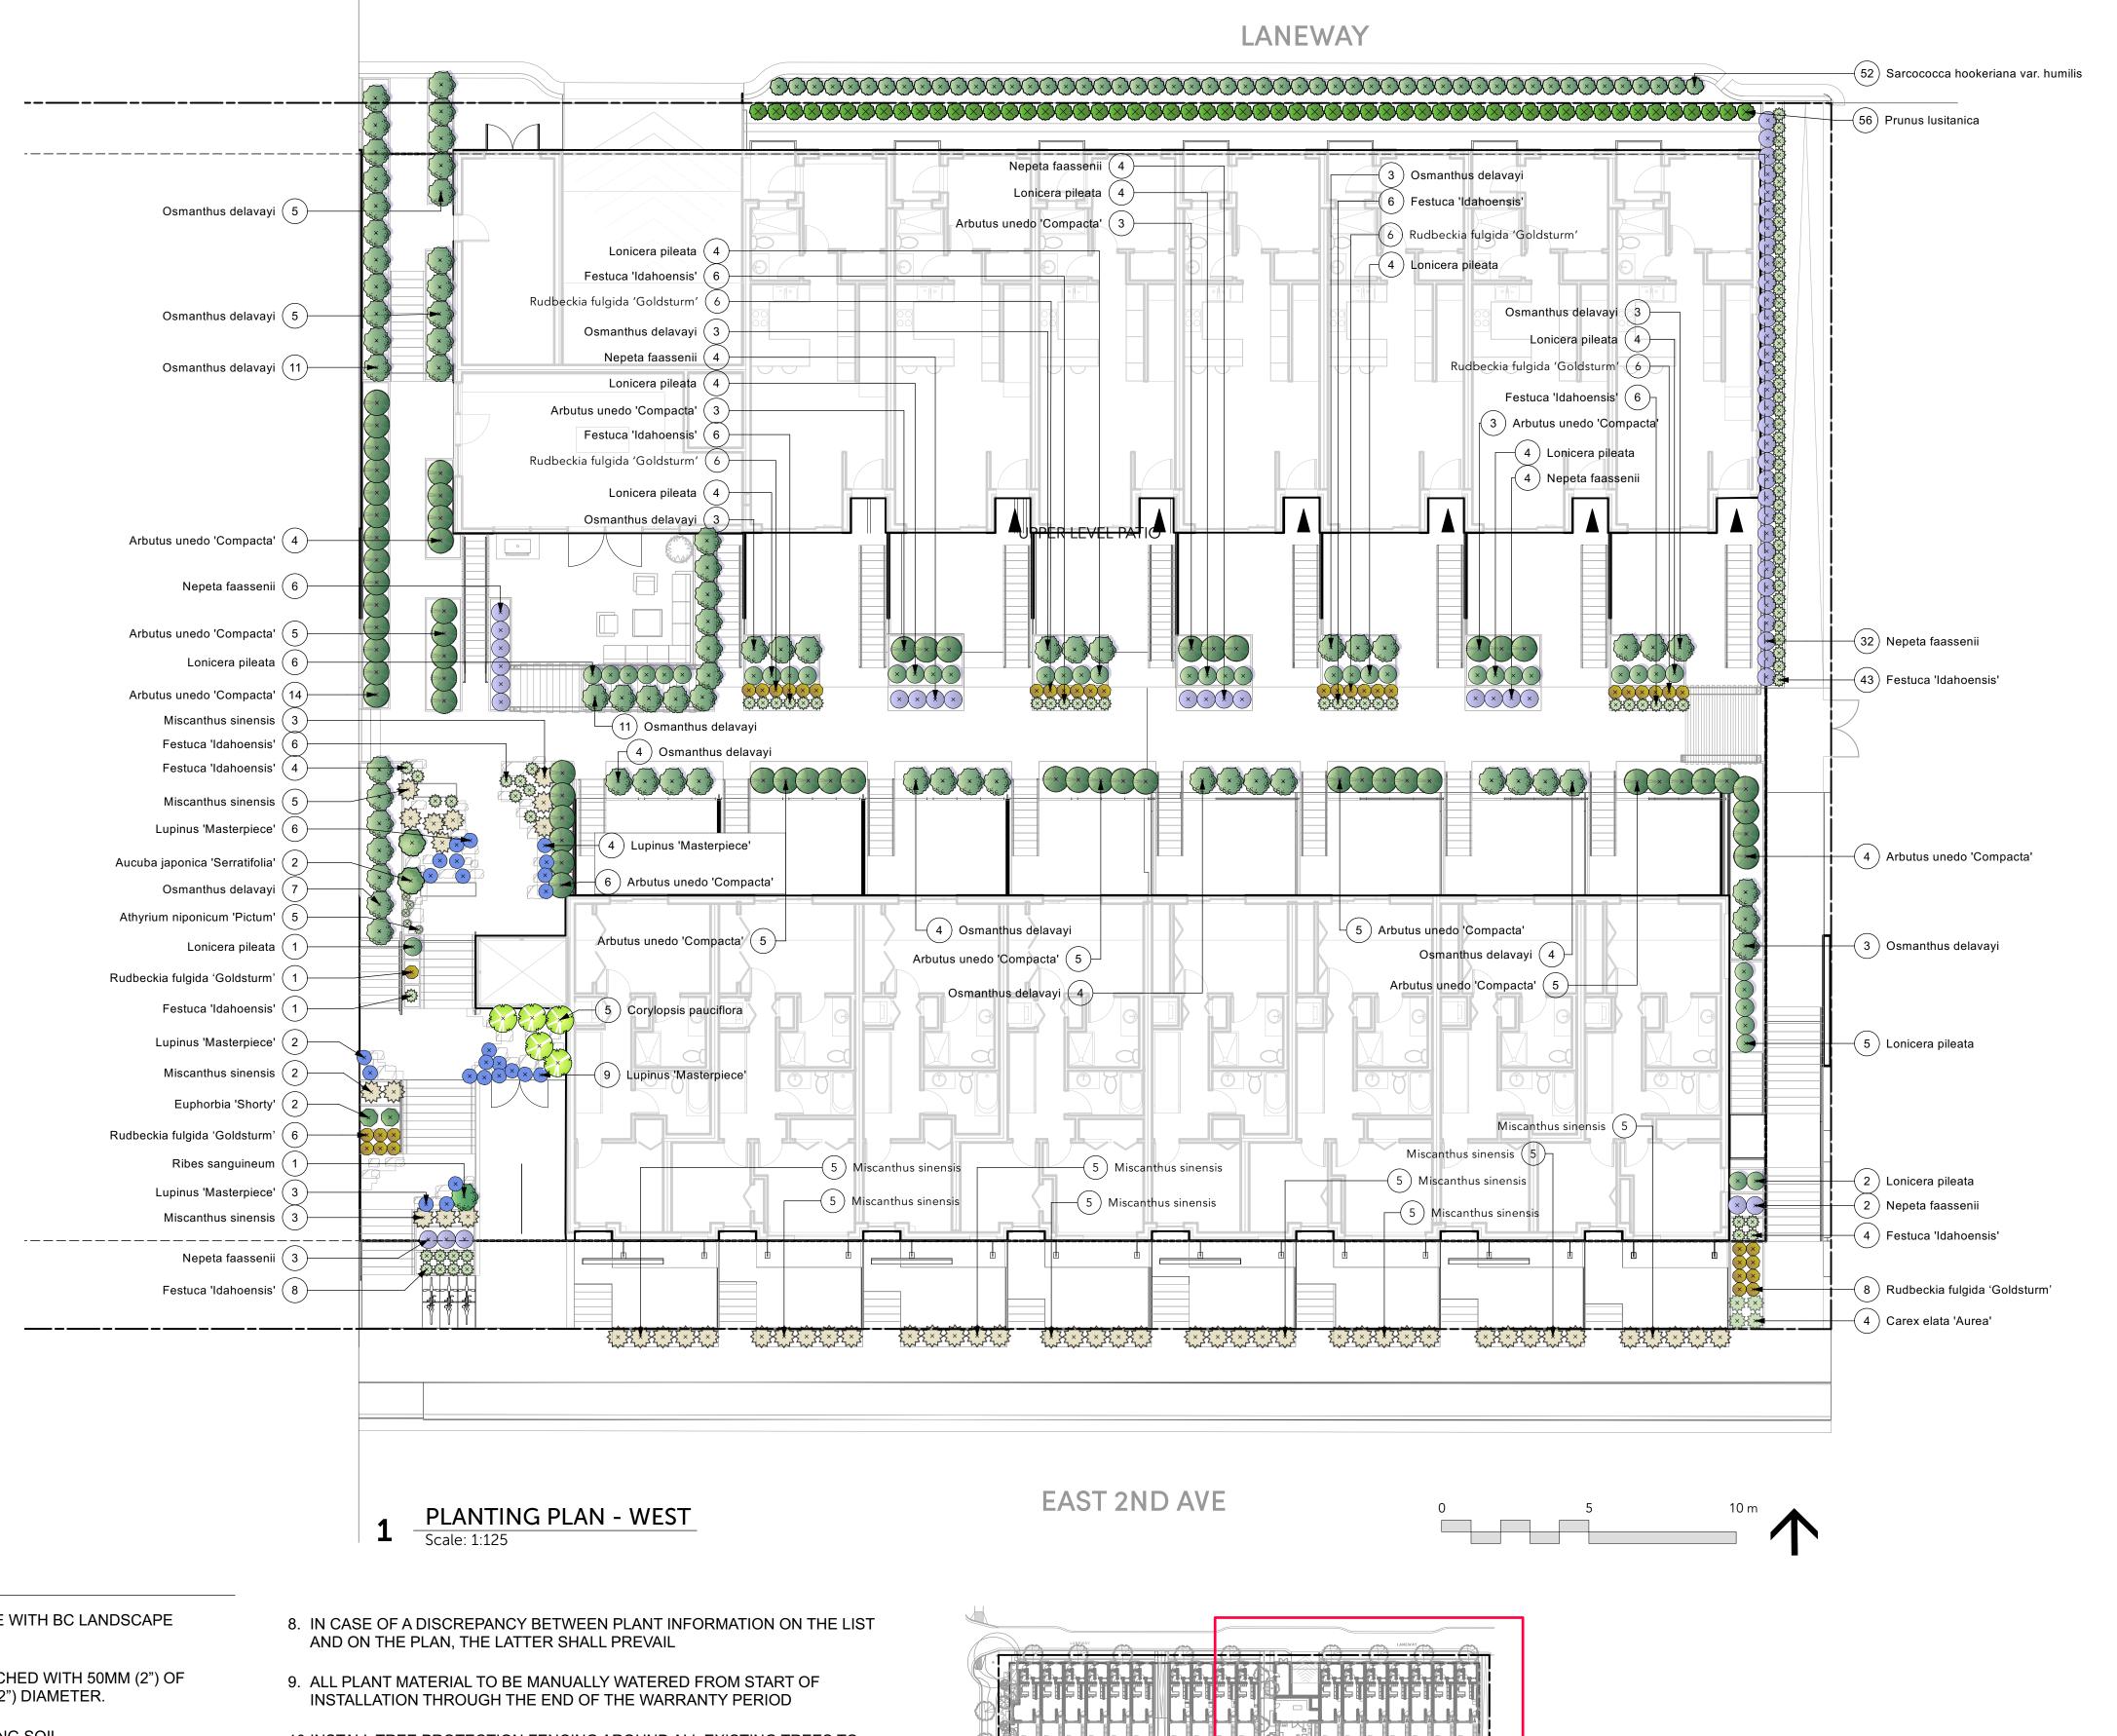
Landscape Architect
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Checked By

Checked


GRADING + SOIL DEPTH PLAN

L2.0



GENERAL PLANTING NOTES:

- 1. ALL PLANTING SHALL BE IN ACCORDANCE WITH BC LANDSCAPE STANDARD, LATEST EDITION
- 2. ALL TREE AND SHRUB AREAS TO BE MULCHED WITH 50MM (2") OF MEDIUM FINE MULCH, LESS THAN 50MM (2") DIAMETER.
- 3. ROOTZONE TO REST ON TAMPED PLANTING SOIL
- 4. SHRUBS: PREPARE PLANTING HOLES AS SPECIFIED. PLANT AT THE SAME GRADE AS NURSERY. WATER AND FERTILIZE AS SPECIFIED. ENSURE POSITIVE DRAINAGE THROUGHOUT PLANTING BED
- 5. TREE SIZE AND SPACING TO BE AS PER CITY OF VANCOUVER ARBORIST
- TREE: PREPARE PLANTING HOLES AS SPECIFIED INSTALL TOP OF ROOTZONE 6" ABOVE FINISHED GRADE OF GROWING MEDIUM. WATER AND FERTILIZE AS SPECIFIED BY NURSERY.
- 7. FINAL SOFTSCAPE AND GRADING LAYOUTS AS WELL AS LOCATION SPACING TO BE APPROVED BY LANDSCAPE ARCHITECTS IN THE FIELD PRIOR TO INSTALLATION
- 10.INSTALL TREE PROTECTION FENCING AROUND ALL EXISTING TREES TO CITY OF VANCOUVER STANDARDS. INSTALL TREE PROTECTION FENCING ON NEW PLANTING IF PHASED INSTALLATION IS REQUIRED.
- 11. FINAL PLANT SPACING, QUANTITY AND TREE PLACEMENT TO BE REVIEWED TO THE SATISFACTION OF GENERAL MANAGER OF ENGINEERING SERVICES
- 12.ALL PLANTING BEDS TO RECEIVE AUTOMATIC DRIP IRRIGATION

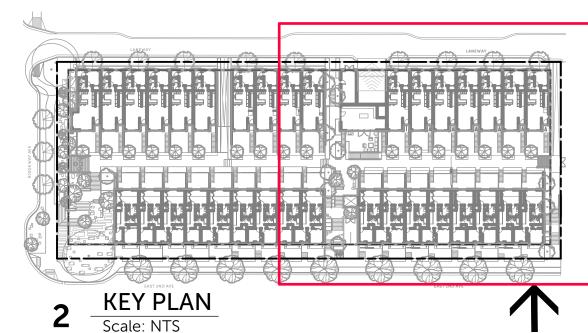



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Issue

No.	Description	Date
Α	ISSUED FOR SCHEMATIC DESIGN	22-01-24
В	ISSUED FOR DEVELOPMENT PERMIT	22-02-25
С	DEVELOPMENT PERMIT	22-10-25

Project Info

RESUBMISSION

22052

M3 Townhomes

North Vancouver

Project Team

Client
Creo Developments

Architect
Shape Architecture


Landscape Architect


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PLANTING PLAN - WEST

L3.0



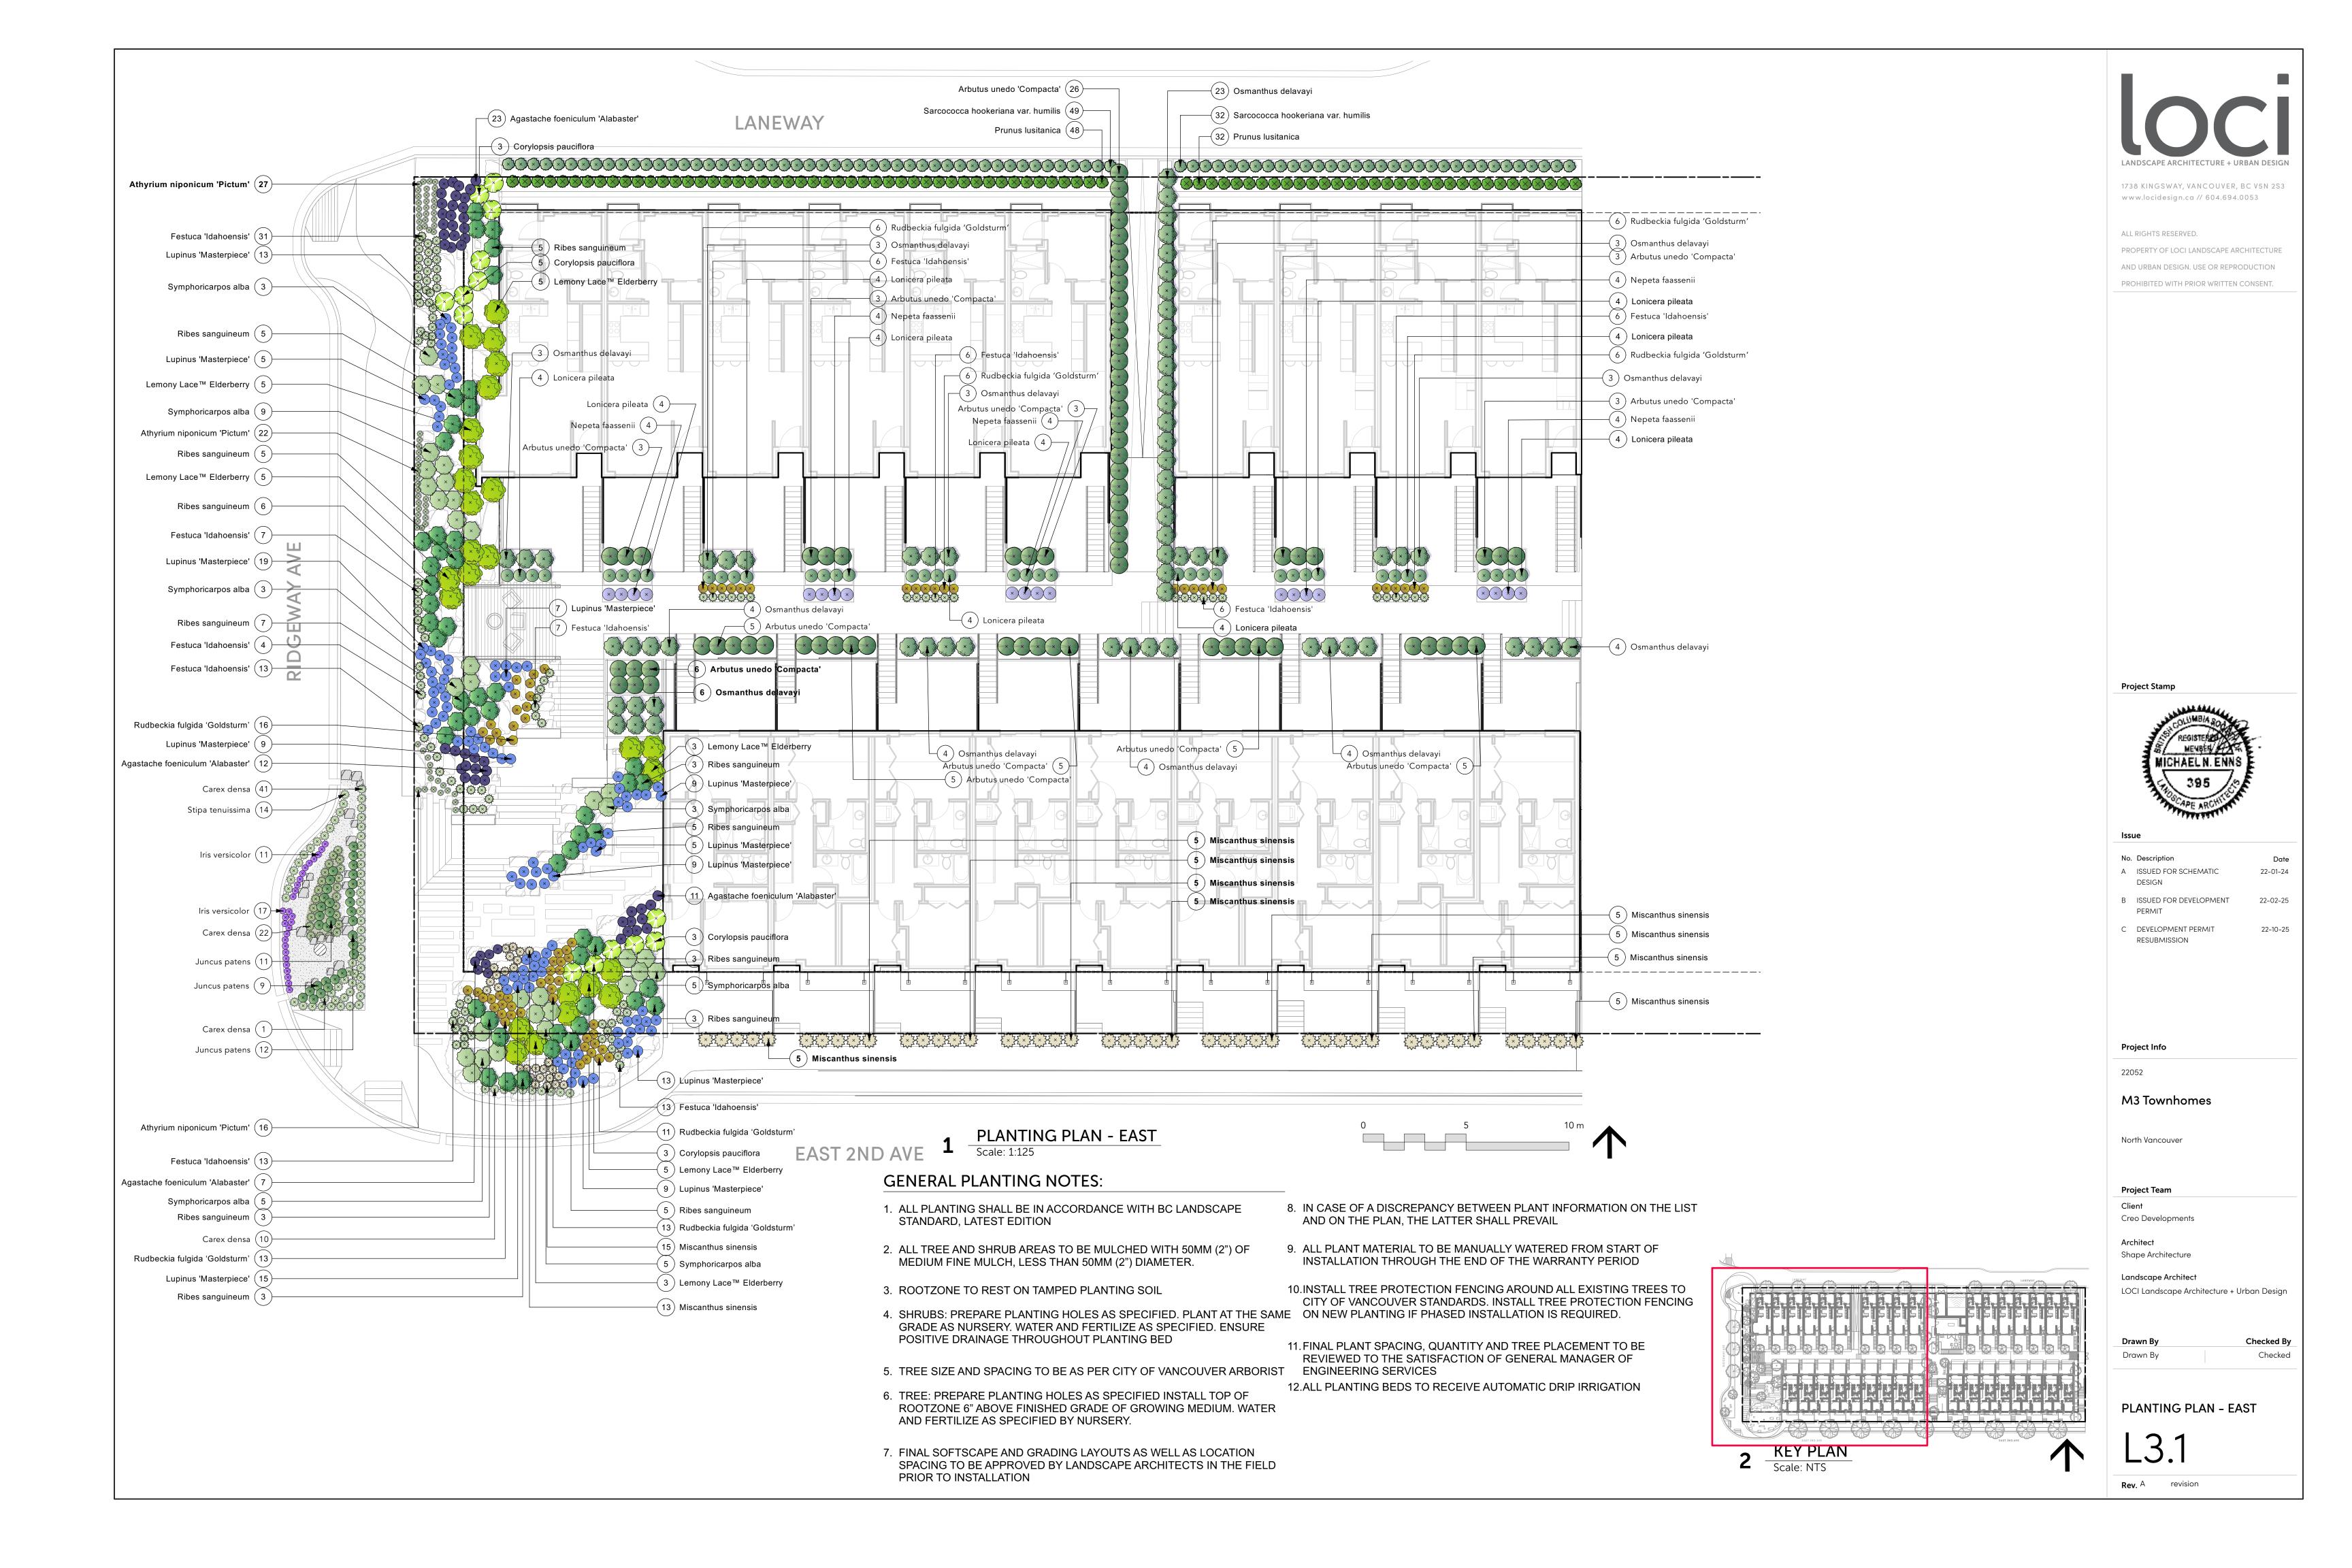

GENERAL PLANTING NOTES:

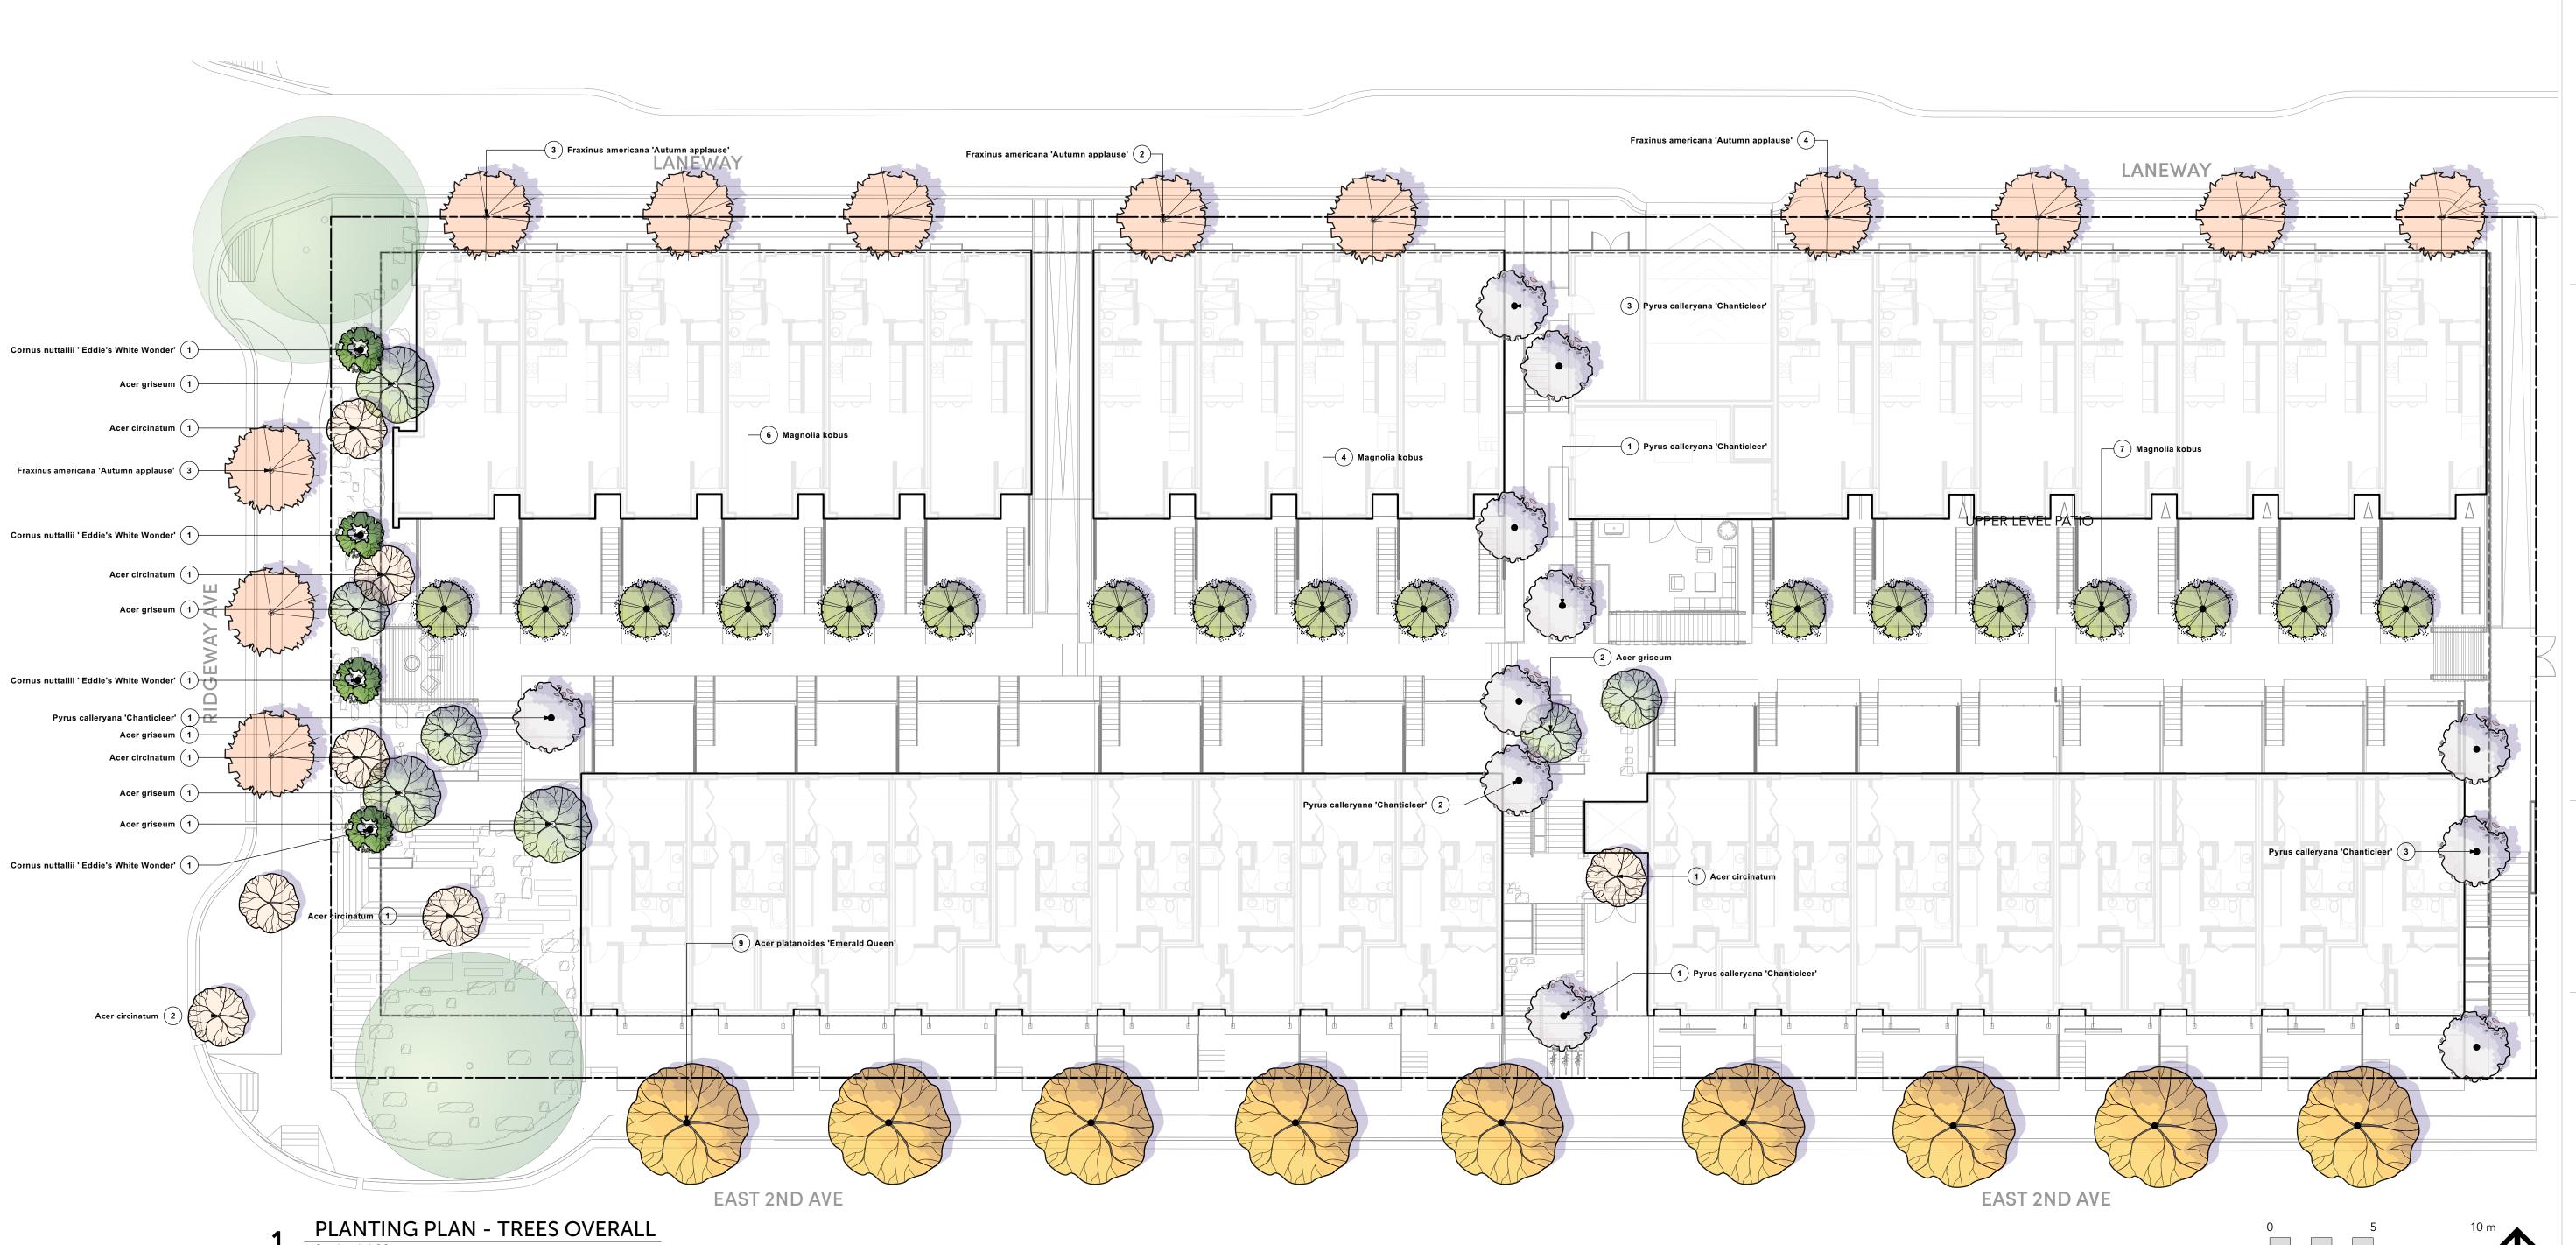- ALL PLANTING SHALL BE IN ACCORDANCE WITH BC LANDSCAPE STANDARD, LATEST EDITION
- ALL TREE AND SHRUB AREAS TO BE MULCHED WITH 50MM (2") OF MEDIUM FINE MULCH, LESS THAN 50MM (2") DIAMETER.
- 3. ROOTZONE TO REST ON TAMPED PLANTING SOIL
- 4. SHRUBS: PREPARE PLANTING HOLES AS SPECIFIED. PLANT AT THE SAME GRADE AS NURSERY. WATER AND FERTILIZE AS SPECIFIED. ENSURE POSITIVE DRAINAGE THROUGHOUT PLANTING BED
- 5. TREE SIZE AND SPACING TO BE AS PER CITY OF VANCOUVER ARBORIST
- 6. TREE: PREPARE PLANTING HOLES AS SPECIFIED INSTALL TOP OF ROOTZONE 6" ABOVE FINISHED GRADE OF GROWING MEDIUM. WATER AND FERTILIZE AS SPECIFIED BY NURSERY.
- 7. FINAL SOFTSCAPE AND GRADING LAYOUTS AS WELL AS LOCATION SPACING TO BE APPROVED BY LANDSCAPE ARCHITECTS IN THE FIELD PRIOR TO INSTALLATION

- 8. IN CASE OF A DISCREPANCY BETWEEN PLANT INFORMATION ON THE LIST AND ON THE PLAN, THE LATTER SHALL PREVAIL
- 9. ALL PLANT MATERIAL TO BE MANUALLY WATERED FROM START OF INSTALLATION THROUGH THE END OF THE WARRANTY PERIOD
- 10.INSTALL TREE PROTECTION FENCING AROUND ALL EXISTING TREES TO CITY OF VANCOUVER STANDARDS. INSTALL TREE PROTECTION FENCING ON NEW PLANTING IF PHASED INSTALLATION IS REQUIRED.
- 11. FINAL PLANT SPACING, QUANTITY AND TREE PLACEMENT TO BE REVIEWED TO THE SATISFACTION OF GENERAL MANAGER OF
- ENGINEERING SERVICES

 12.ALL PLANTING BEDS TO RECEIVE AUTOMATIC DRIP IRRIGATION



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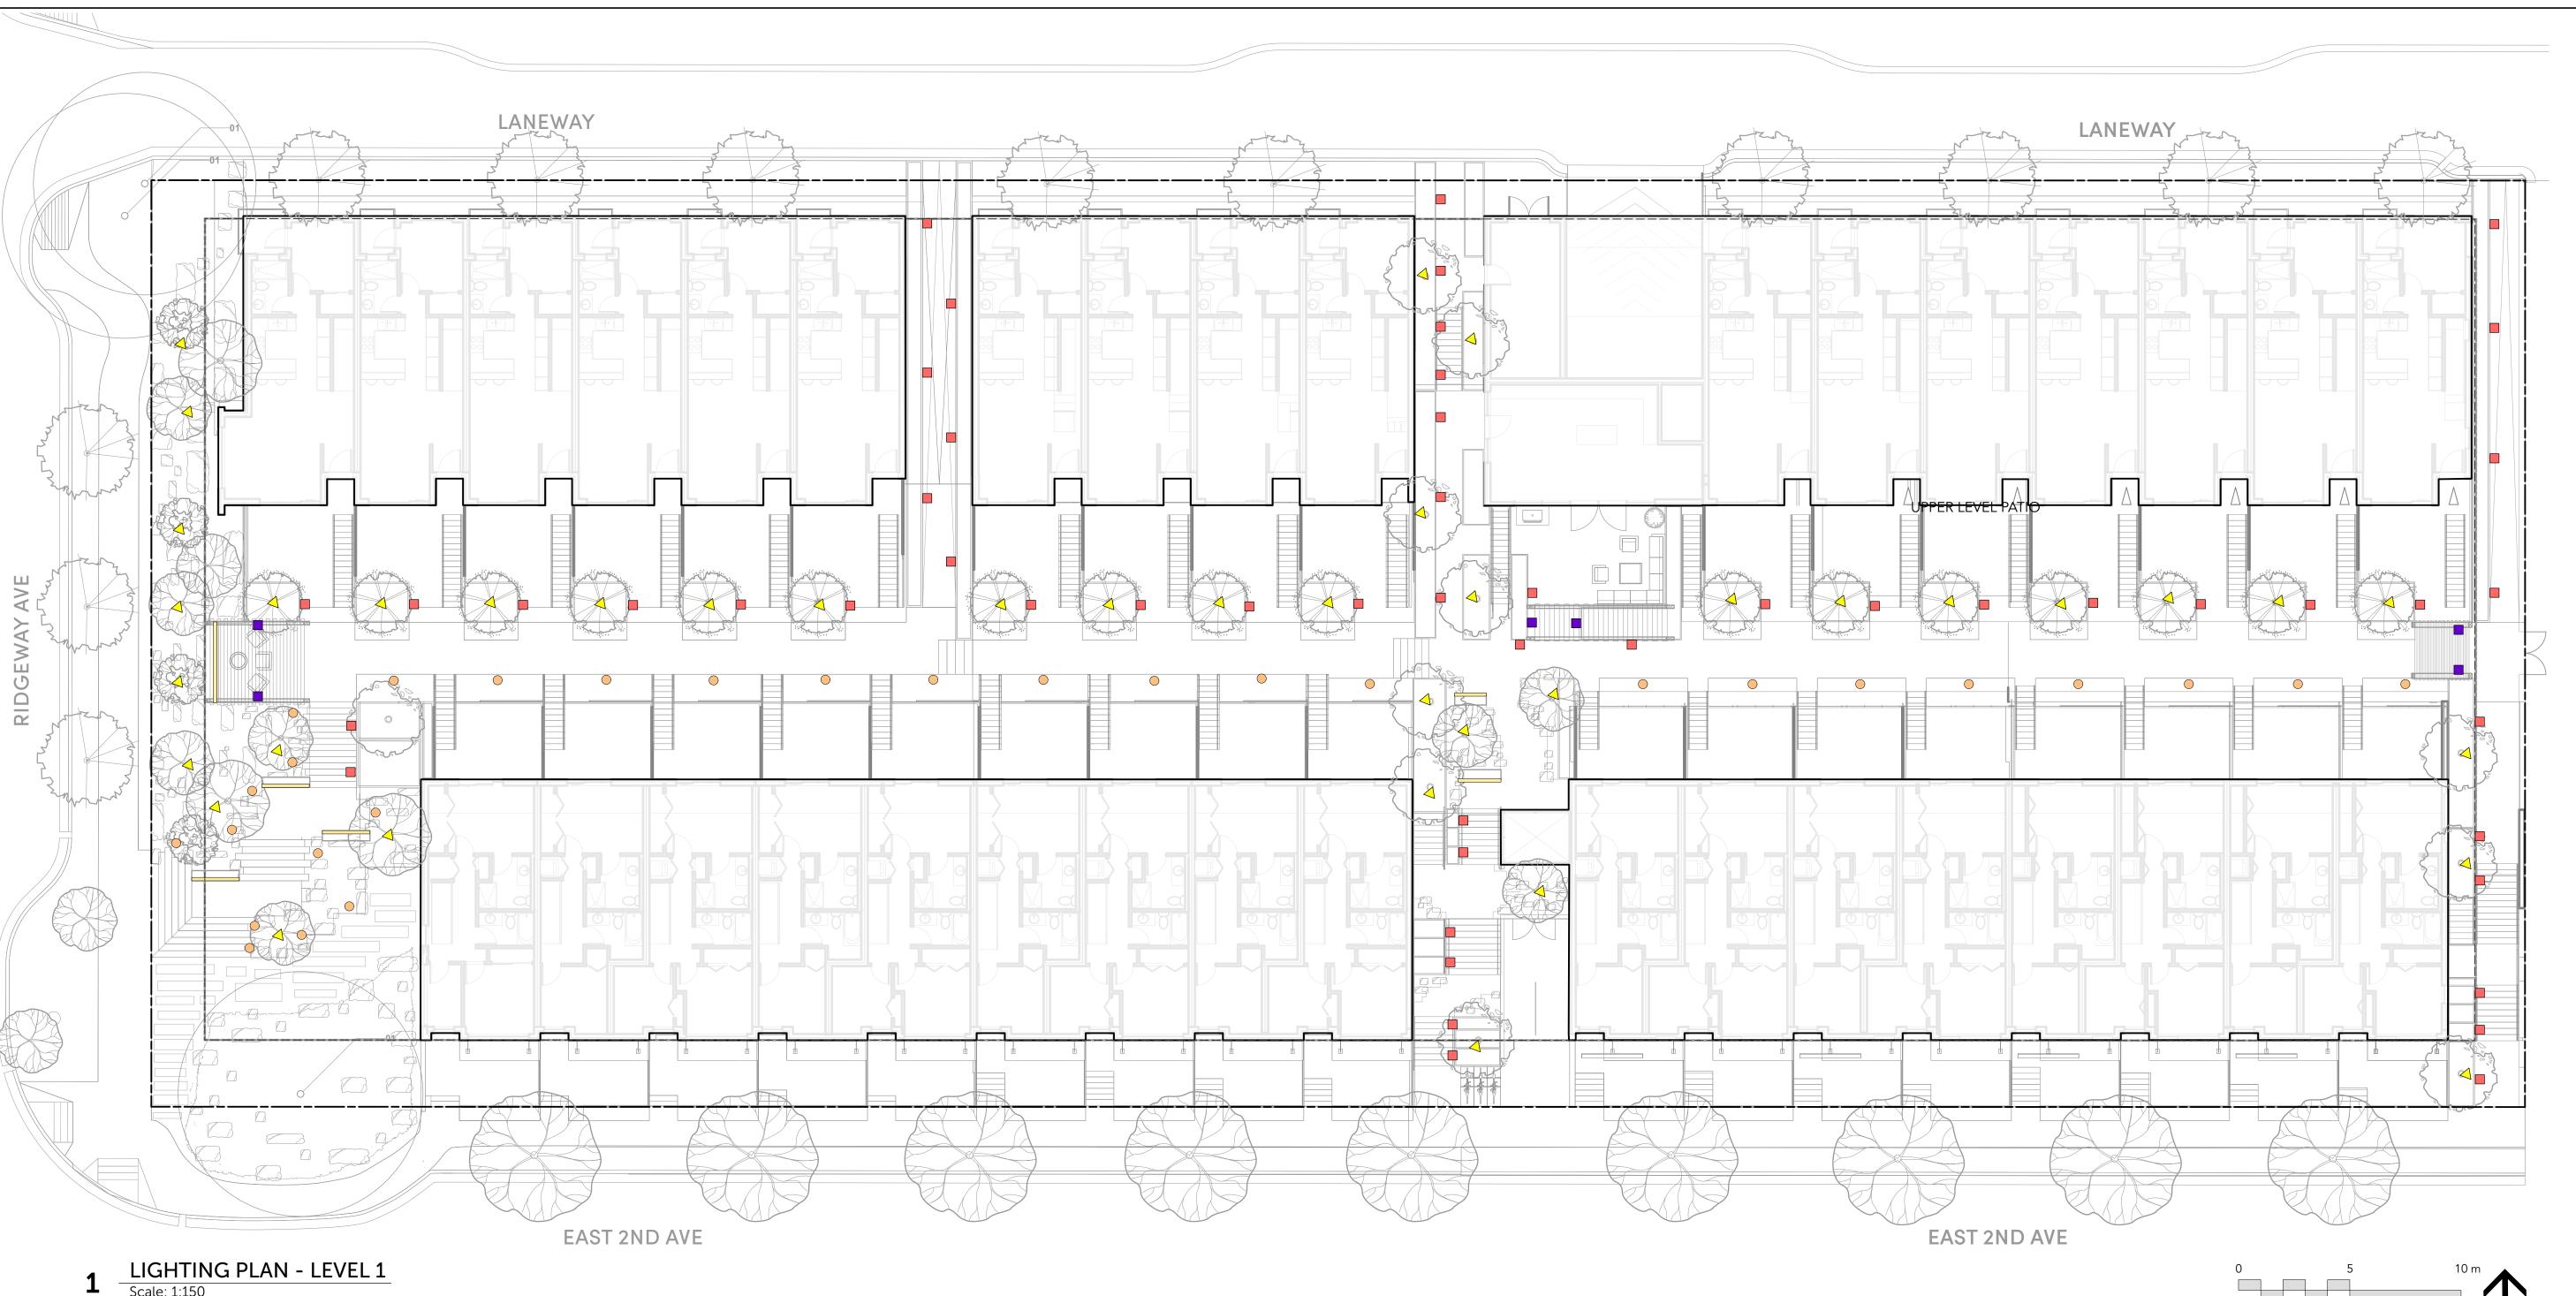
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PLANTING PLAN - TREES

127

Rev. A revision

OVERALL



GENERAL LIGHTING NOTES:

- 1. THE ELECTRICAL CONTRACTOR SHALL PROVIDE SHOP DRAWINGS FOR ALL ELECTRICAL WORK FOR THE LANDSCAPE ARCHITECTS APPROVAL. SHOP DRAWINGS SHALL BE SIGNED AND SEALED BY LICENSED ELECTRICAL ENGINEER, OR MASTER ELECTRICIAN. PRIOR TO WORK COMMENCING/INSTALLATION.
- 2. ALL FIXTURE TYPES, SPACING, AND QUANTITIES TO BE CONFIRMED.
- 3. PRICE BASED ON LED LIGHT SOURCE FOR APPLICABLE LUMINAIRES
- 4. REFER TO ELECTRICAL ENGINEER FOR SERVICING REQUIREMENTS
- 5. THE LIGHTING CONTRACTOR IS OBLIGATED TO REFER TO THE LANDSCAPE PLANS AND DETAILS FOR LOCATIONS OF FIXTURES RELATIVE TO THE PROPOSED HARDSCAPE AND PLANTING PLANS. NOTED DIMENSIONS ARE APPROXIMATE. REFER TO NOTE OR ENLARGEMENT, FOR FINAL PLACEMENT. CONTACT LANDSCAPE ARCHITECT FOR CLARIFICATION, IF NEEDED.
- 6. THE LANDSCAPE ARCHITECT OR CLIENT'S REPRESENTATIVE SHALL APPROVE THE FLAGGED LAYOUT OF THE FIXTURES AND ELECTRICAL SYSTEM PRIOR TO TRENCHING AND/OR FOUNDATION PREPARATION.
- 7. THE ELECTRICAL/LIGHTING CONTRACTOR IS RESPONSIBLE TO COORDINATE THE PLACEMENT OF SLEEVES PRIOR TO PAVING, SLEEVE MATERIAL SHALL BE SCHEDULE 40 AND AT A MINIMUM DEPTH TO MEET ALL ELECTRICAL CODES.

- 8. THE ELECTRICAL/LIGHTING CONTRACTOR IS RESPONSIBLE FOR ALL PERMITS, LICENSES, AND ASSOCIATED FEES REQUIRED TO INSTALL THE SYSTEM(S) INCLUDING ALL ELECTRICAL CONDUIT, LIGHT FIXTURES, WIRE, PANELS, JUNCTION BOXES AND NECESSARY EQUIPMENT FOR THE COMPLETION OF THE WORK.
- 9. THE ELECTRICAL/LIGHTING CONTRACTOR IS RESPONSIBLE FOR CONTACTING UTILITY COMPANIES, COMMUNICATIONS PROVIDERS AND OTHERS TO IDENTIFY AND MARK LOCATIONS OF ALL UNDERGROUND UTILITIES WITHIN THE SCOPE OF WORK. KNOWN UTILITIES WHICH MAY BE ENCOUNTERED INCLUDE: ELECTRICAL, STORM SEWER, WATER, AND SANITARY SEWER.
- 10. VERIFY IN FIELD, ALL LOCATIONS OF FIXTURES, ELECTRICAL LINES OR OTHER LIGHTING SYSTEM ELEMENTS WITHIN THE DRIP LINE OF ANY EXISTING TREES. NOTIFY LANDSCAPE ARCHITECT OF SUCH OCCURRENCES PRIOR TO COMMENCEMENT OF WORK. HAND EXCAVATE WITHIN THE DRIPLINE OF ANY TREE, REFER TO SPECIFICATIONS.
- 11. ELECTRICAL CONDUIT LAYOUT IS DIAGRAMMATIC ON DOCUMENTS. ADJUST LOCATIONS ON SITE TO ACCOMMODATE EXISTING JOB CONDITIONS AND TO ACHIEVE MINIMAL IMPACT TO IN PLACE AND FUTURE ELEMENTS. AVOID INSTALLATIONS UNDER TREES.

- 12. THE CONTRACTOR SHALL VERIFY THE LOCATION OF EXISTING ELECTRIC POWER, AND PROPOSED CONNECTIONS AND METERS IN THE FIELD FOR APPROVAL OF THE LANDSCAPE ARCHITECT OR OWNER'S REPRESENTATIVE PRIOR TO INSTALLATION.
- 13. THE CONTRACTOR SHALL PROVIDE CIRCUIT BREAKERS, AND PHOTO CELL CONTACTORS FOR ACTIVATION OF LIGHTING CIRCUITS.
- 14. THE CONTRACTOR SHALL PROVIDE CIRCUIT BREAKERS AND ASTRONOMIC TIME CLOCK FOR DE-ACTIVATION ON LIGHTING CIRCUITS.
- 15. THE LIGHTING SYSTEM SHALL BE PHOTOCELL ON, TIMER OFF.









LIGHTING LEGEND - GROUND LEVEL

	QTY	TYPE	MANUFACTURER	DESCRIPTION
TYPE A		Spot Flood	KICHLER	120V-277V LED Small Accent, 5W & 10W
TYPE B		LED Strip	Bruck	Orion Belt Narrow Beam Spread LED, Mounted Underneath Seat Wall Overhang
TYPE C		Bollard	VISTA	PR-4202-B-W-LB2ND
TYPE D		Wall Insert – Metal Planter	KUZCO	Sonic ER3005 Step Lights
TYPE E		Wall Sconce Integro	ated Into Trellis – See A	ırch



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22-10-25

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Project Info

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M3 Townhomes

North Vancouver

Project Team

Client
Creo Developments

Architect
Shape Architecture

Landscape Architect

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LIGHTING PLAN

4

L4.0

OVERALL PLANT LIST

Symbol DECIDUOUS	,	Botanical Name	Common Name	Scheduled Size	Spacing	Not
	7	Acer circinatum	Vine Maple	7cm cal.	As Shown	B&E
	7	Acer griseum	Paperbark Maple	7cm cal.	As Shown	B&E
	9	Acer platanoides 'Emerald Queen'	Emerald Queen Norway Maple	8cm cal.	As Shown	B&E
	4	Cornus nuttallii ' Eddie's White Wonder'	Eddie's Pacific Dogwood	6cm cal.	As Shown	B&E
and the second	12	Fraxinus americana 'Autumn applause'	Autumn Applause White Ash	7cm cal.	As Shown	B&E
	17	Magnolia kobus	Kobus magnolia	6cm cal.	As Shown	B&E
	11	Pyrus calleryana 'Chanticleer'	Flowering Pear	7cm cal.	As Shown	B&E
HRUBS:						
	62	Arbutus unedo 'Compacta'	Compact Strawberry Bush	#2 Pot	0.76 o.c.	
	2	Aucuba japonica 'Serratifolia'	Sawtoothed Japanese Aucuba	#3 Pot	0.91 o.c.	
	5	Corylopsis pauciflora	Buttercup Winter Hazel	#2 pot	1 o.c.	
	42	Lonicera pileata	Box-leaf Honeysuckle	#2 Pot	0.61 o.c.	
	70	Osmanthus delavayi	Sweet Olive	#2 Pot	0.91 o.c.	
	56	Prunus Iusitanica	Portugal Laurel	#3 pot	0.61 o.c.	
	1	Ribes sanguineum	Red Flowering Currant	#5 Pot	0.91 o.c.	
	52	Sarcococca hookeriana var. humilis	Himalayan Sweet Box	#2 Pot	0.61 o.c.	
PERENNIALS,	GRASSES, G	ROUNDCOVER:				
	5	Athyrium niponicum 'Pictum'	Japanese Painted Fern	#1 pot	0.3 o.c.	
	4	Carex elata 'Aurea'	Bowles Golden Sedge	#2 pot	0.61 o.c.	
	2	Euphorbia 'Shorty'	Shorty Spurge	#2 Pot	0.61 o.c.	
	90	Festuca 'Idahoensis'	Idaho fescue	#1 pot	0.46 o.c.	
	24	Lupinus 'Masterpiece'	Masterpiece Lupine	#2 pot	0.5 o.c.	
£	53	Miscanthus sinensis	Maiden Grass	#2 Pot	0.76 o.c.	
	55	Nepeta faassenii	'Cat's Meow' Catmint	#1 Pot	0.61 o.c.	
	39	Rudbeckia fulgida 'Goldsturm'	Black-Eyed Susan	#2 Pot	0.46 o.c.	

PLANT IMAGES

TREES









Emerald Queen Norway Maple



Eddie's Pacific Dogwood





Magnolia kobus Kobus Magmnolia

Fraxinus americana 'Autumn Applause'
Autumn Applause White Ash



Pyrus calleryana 'Chanticleer' Flowering Pear

SHRUBS













Prunus lusitanica
Portugal Laurel

Apple sadded				
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Landscape Architect LOCI Landscape Architecture + Urban Design

Checked By

PLANT LIST + IMAGES

L5.0 Rev. A revision

ORNAMENTAL GRASSES, PERENNIALS, FERNS, AND GROUNDCOVERS



Ribes sanguineum
Red Flowering Currant



Sarcococca hookeriana var. humilis

Himalayan Sweet Box










Masterpiece Lupine






Rudeckia fulgida 'Goldstrum' Black-Eyed Susan

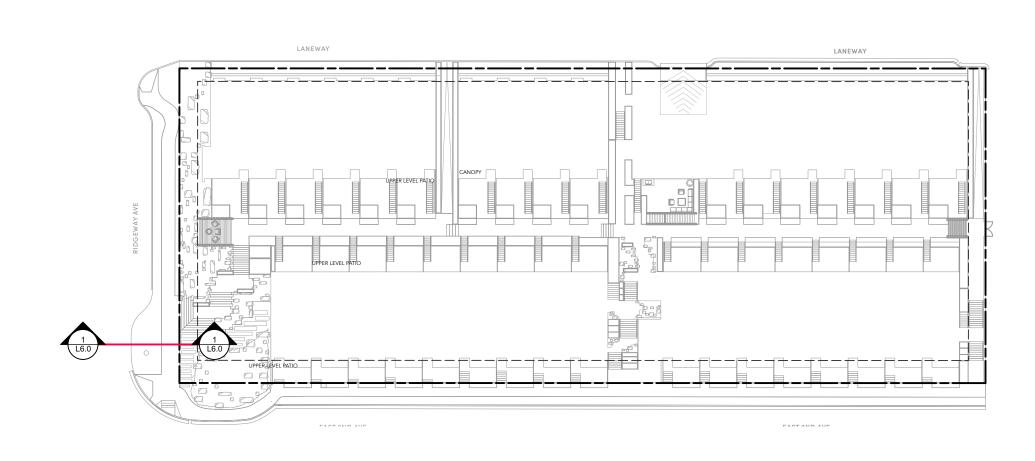

2 KEY PLAN
Scale: 1:500

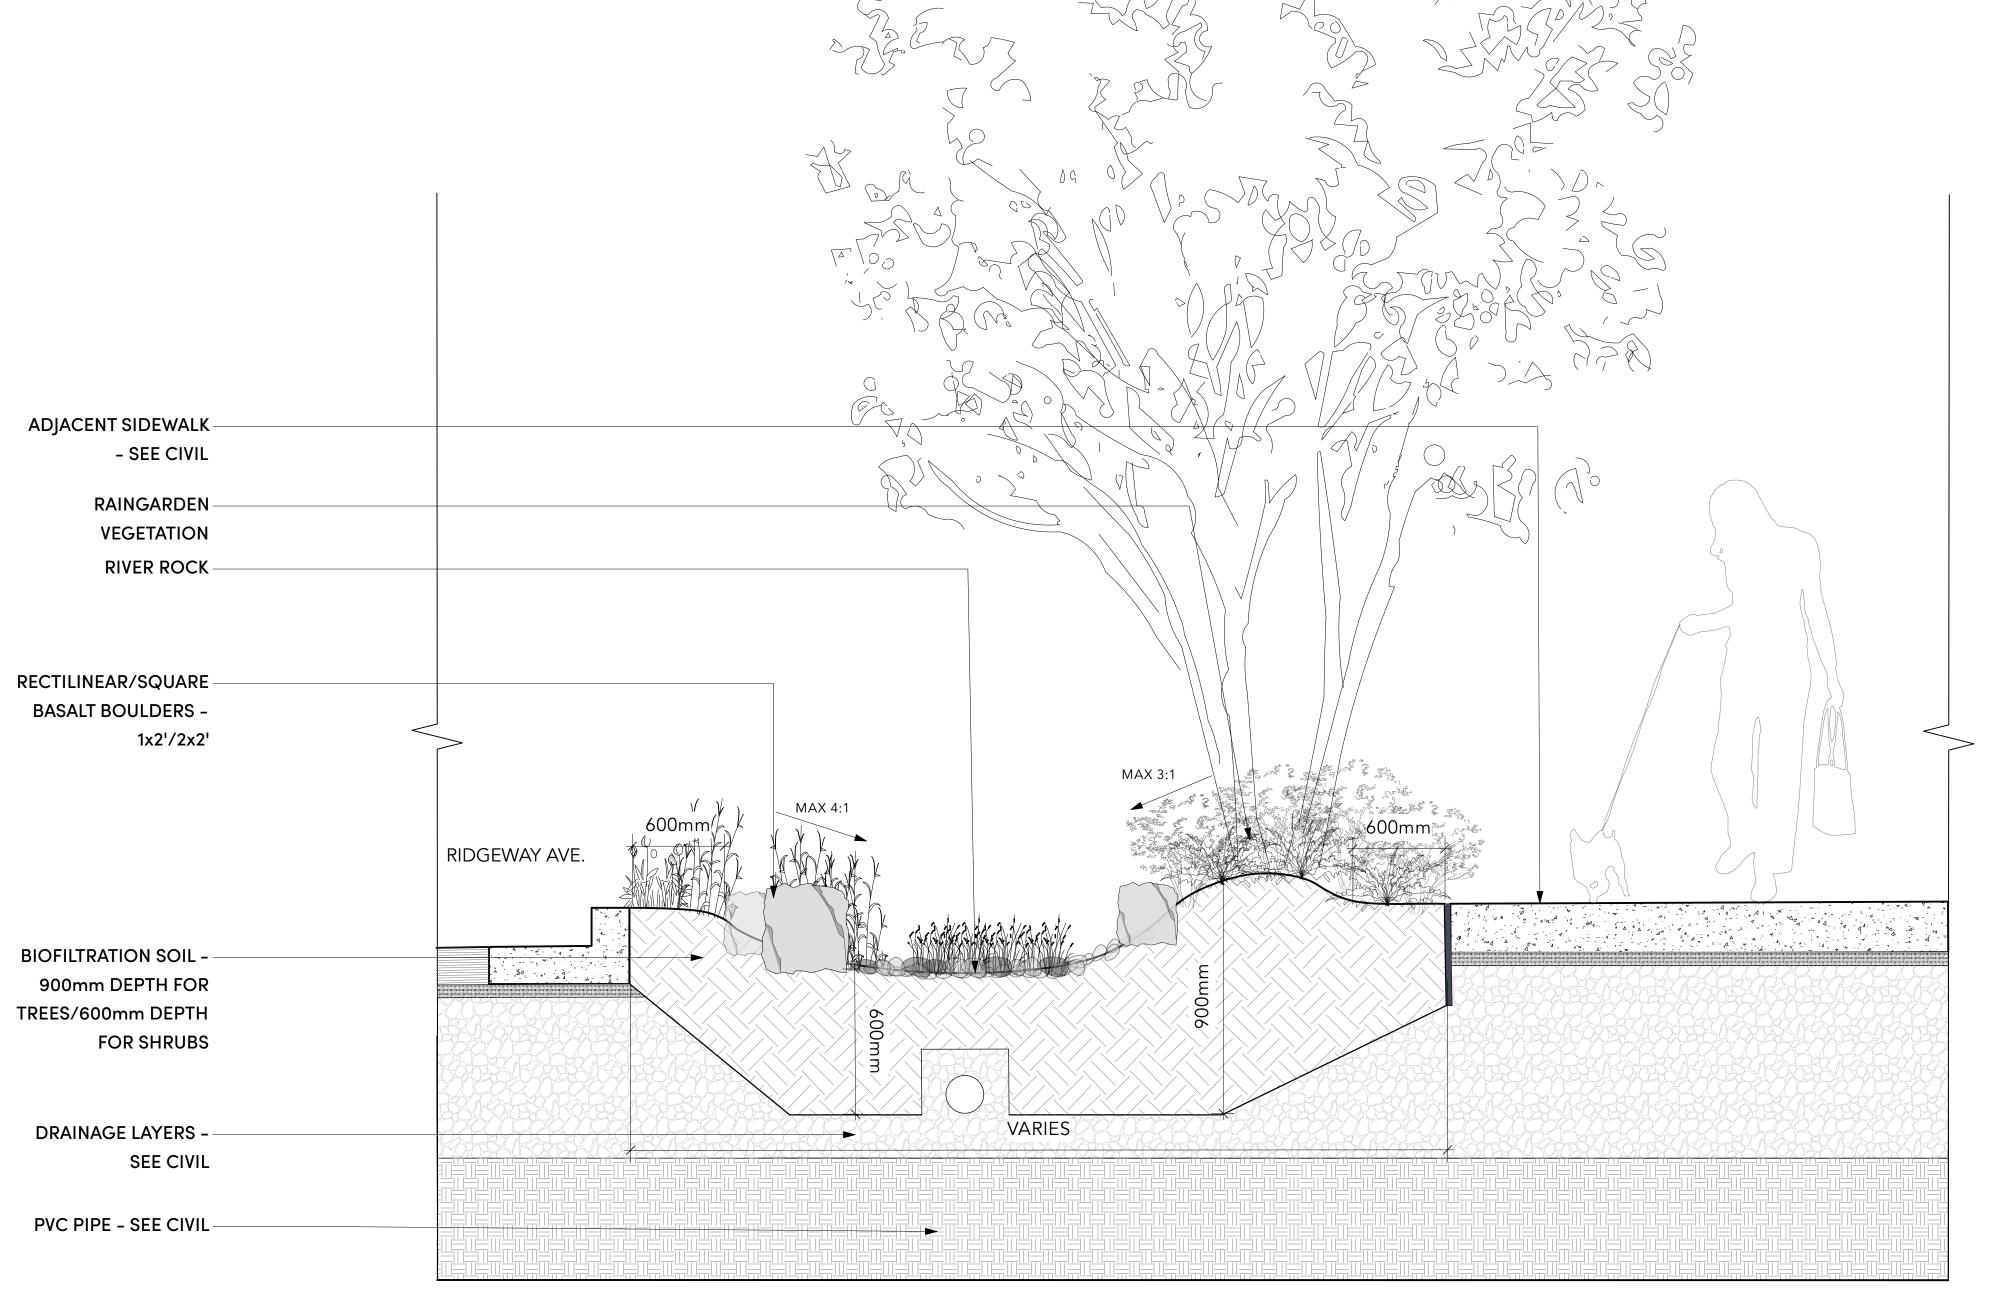

SECTION 1- RIDGEWAY AVE. RAIN GARDEN -TYP.

Scale: 1:15



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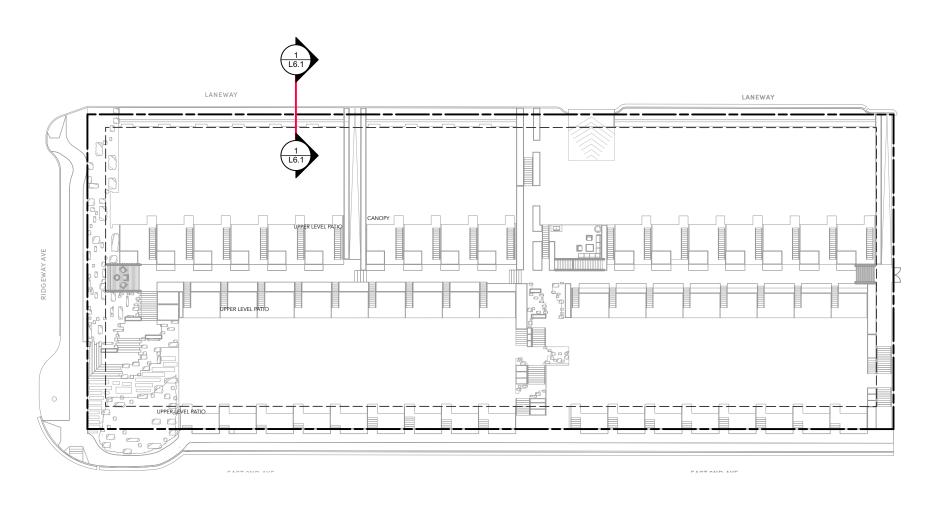
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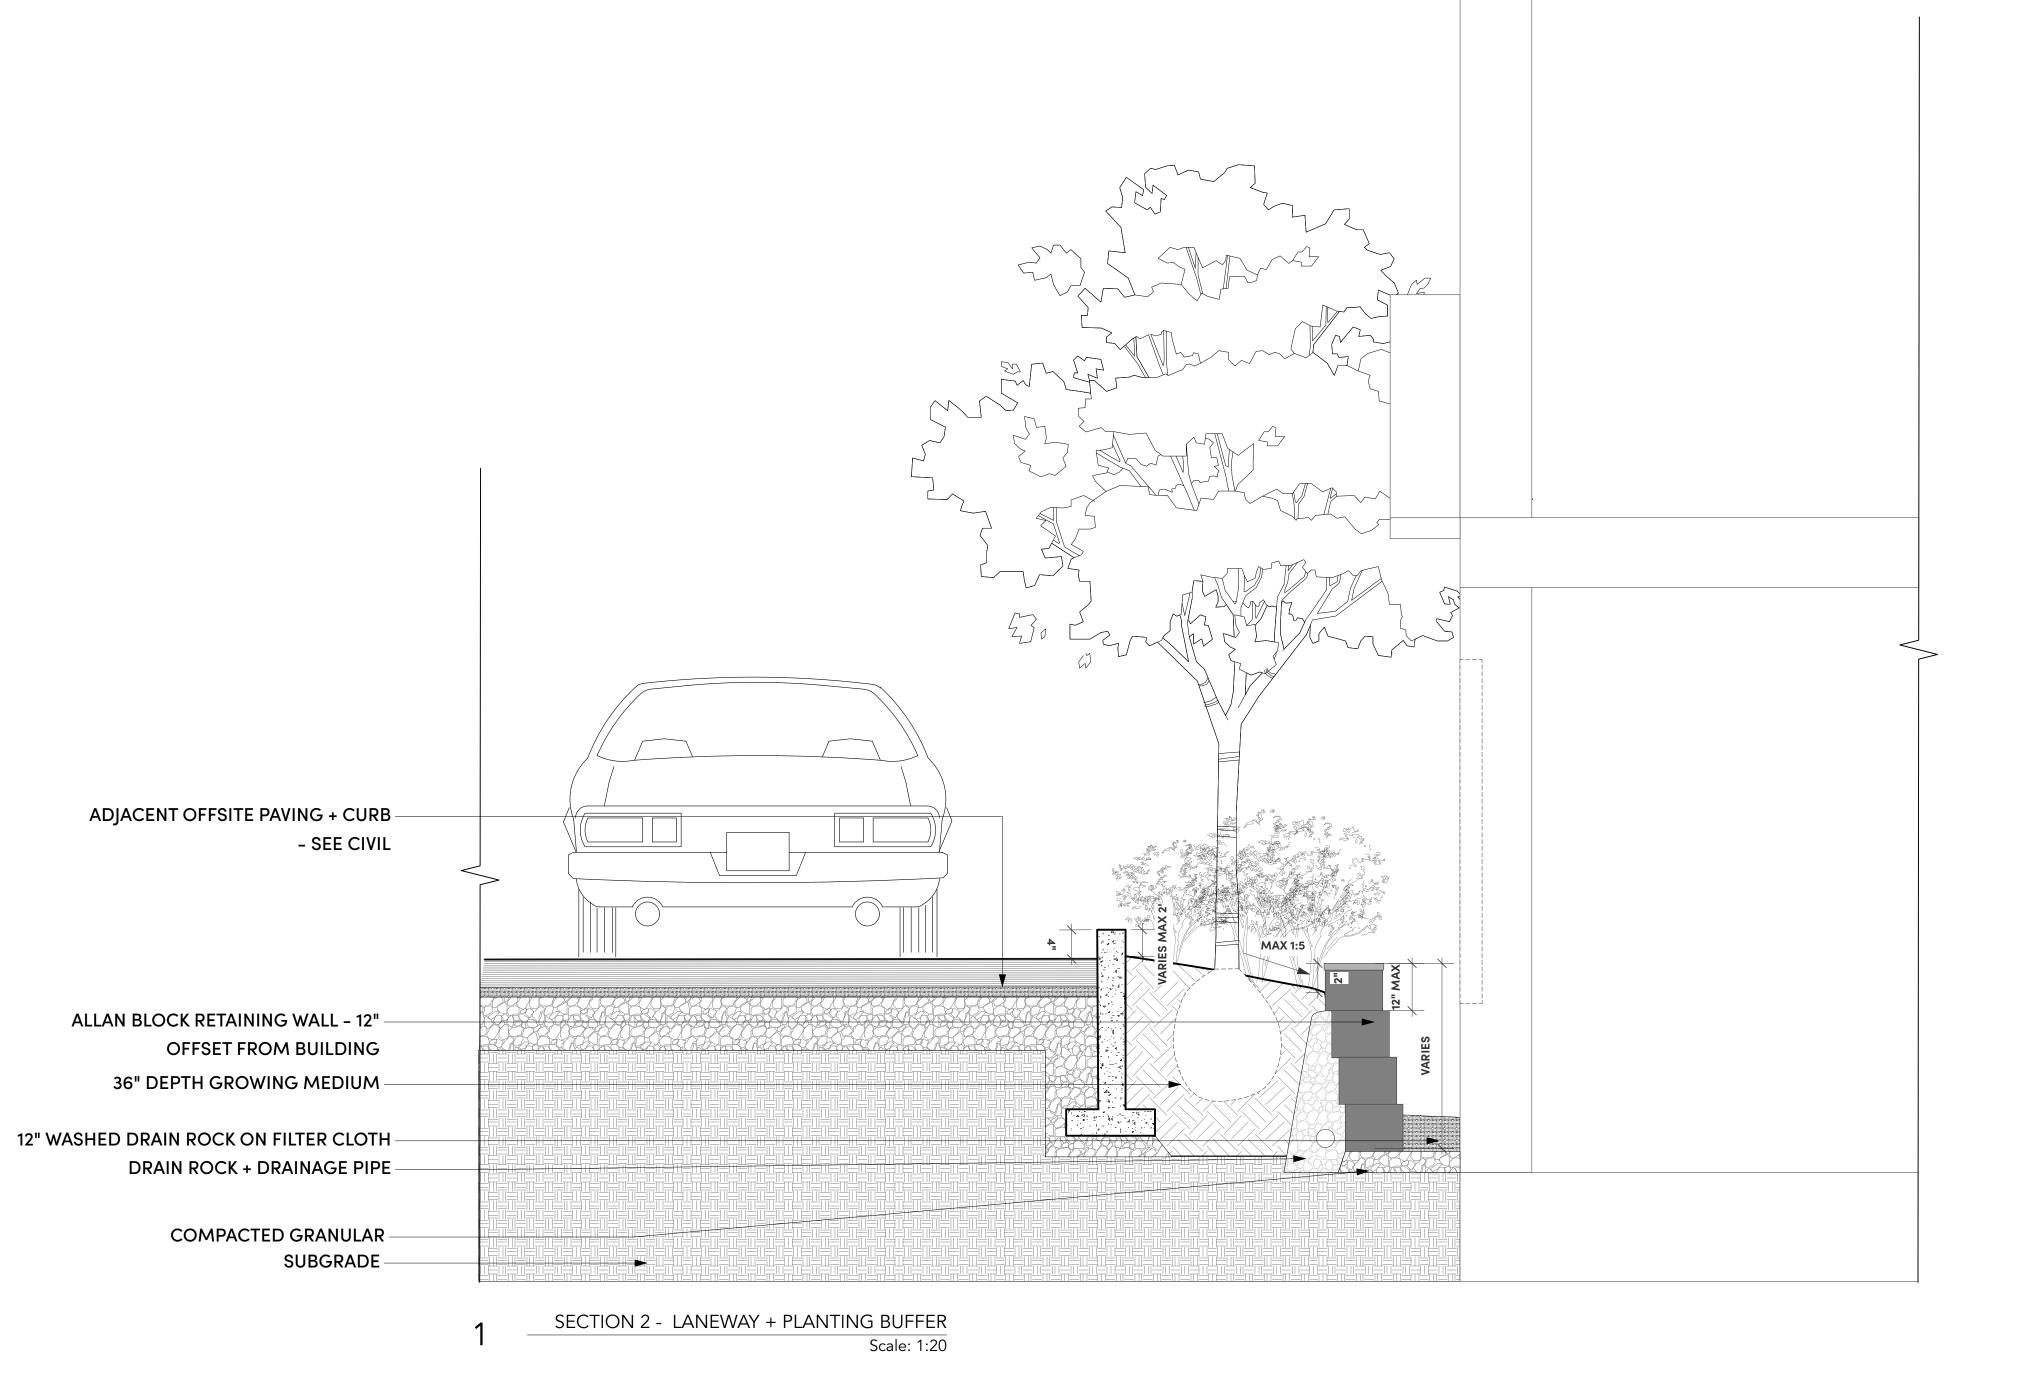
LANDSCAPE SECTIONS

L6.0



2 KEY PLAN
Scale: 1:500

lack



LANDSCAPE ARCHITECTURE + URBAN DESIGN

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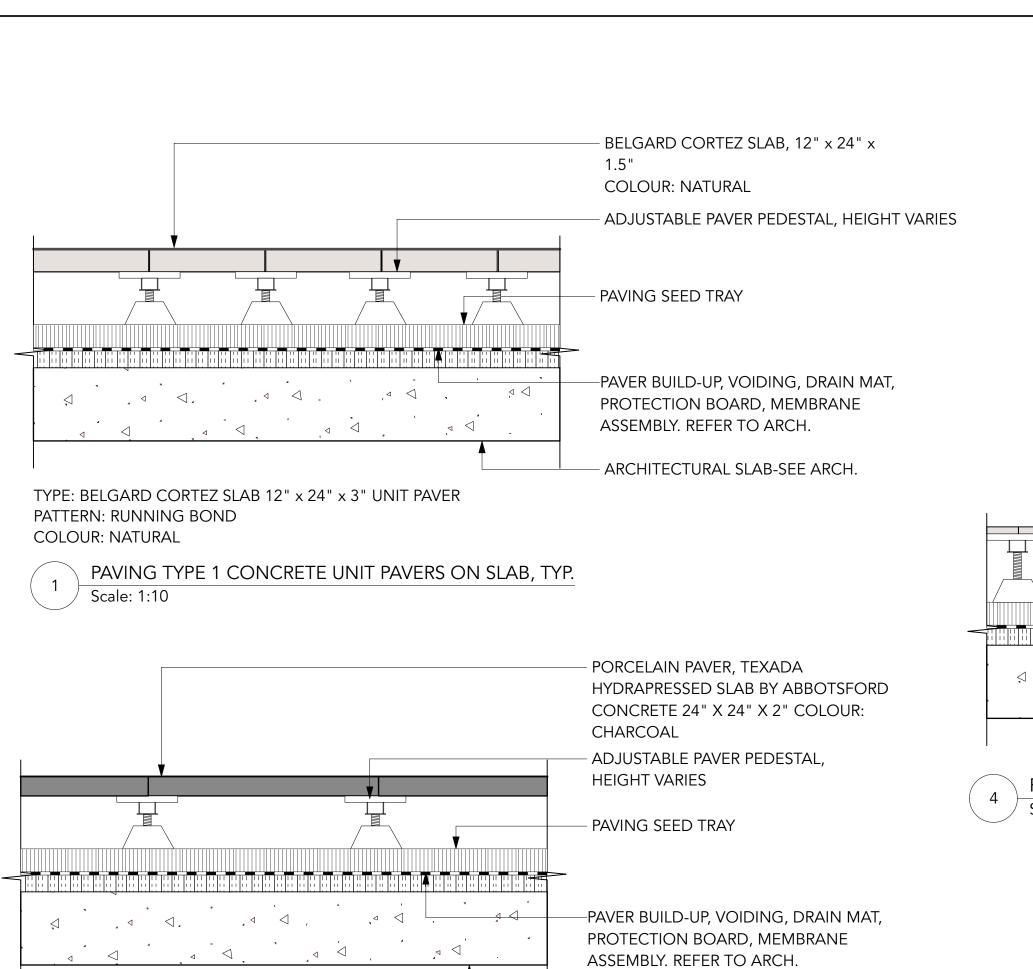
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LANDSCAPE SECTIONS

16



ARCHITECTURAL SLAB-SEE ARCH.

PLAN


SECTION

Scale: 1:10

COLOUR: CHARCOAL PAVING TYPE 2: PORCELAIN PAVERS ON SLAB, TYP / Scale: 1:10

TYPE: TEXADA SLAB 24" x 24" x 2" UNIT PAVER


PATTERN: STACKED BOND

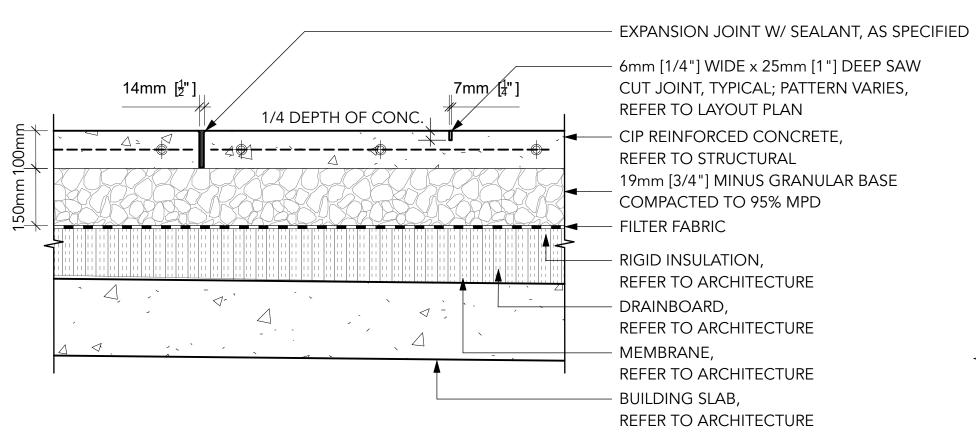

NOTES:

- 1. TROWEL WITH LIGHT SANDBLAST
- 2. SEE TYPICAL LAYOUT PLAN FOR JOINT PATTERN AND BAND WIDTH
- 3. EXP. JOINTS 6096mm [20'0"] O.C. MAX (@ CURB, BUILDING EDGE CUT LINES, CHANGES IN MATERIALS. SPACING TO COINCIDE W/ PATTERN)
- 4. CONTROL JOINTS @ 1524mm [5'0"] O.C. MAX
- 5. FINAL LOCATIONS TO BE CONFIRMED ON SITE
- 6. STRUCTURAL ENGINEER TO CONFIRM DEPTH AND REINFORCEMENT

PAVING TYPE 3: CNV CIP CONCRETE PAVING, TYP Scale: 1:10

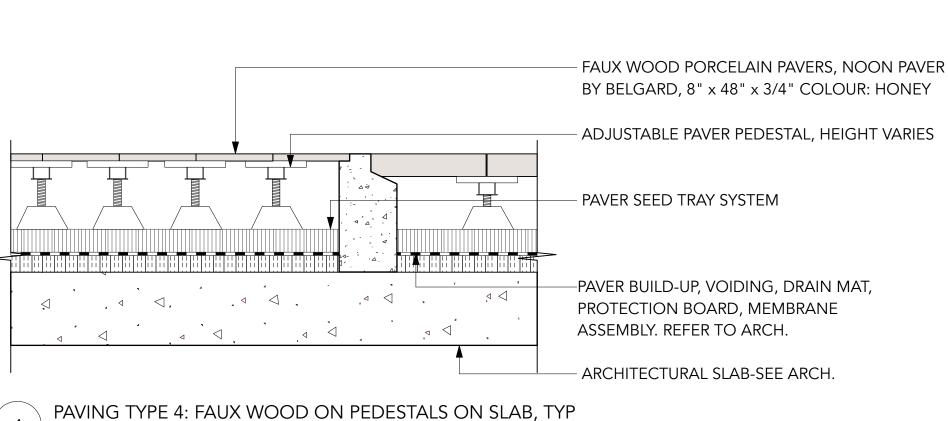

CONCRETE UNIT PAVERS

- CONCRETE UNIT PAVER ON GRAVEL BASE

1" DIA. POLISHED GRAVEL

3/4" CLEAR CRUSH COMPACTED

- COMPACTED SUBGRADE, REFER TO

BASE COURSE, MIN 4" DEPTH,

COMPACTED TO 95% MPD


NON-WOVEN FILTER FABRIC

CIVIL.

- 1" POLISHED GRAVEL


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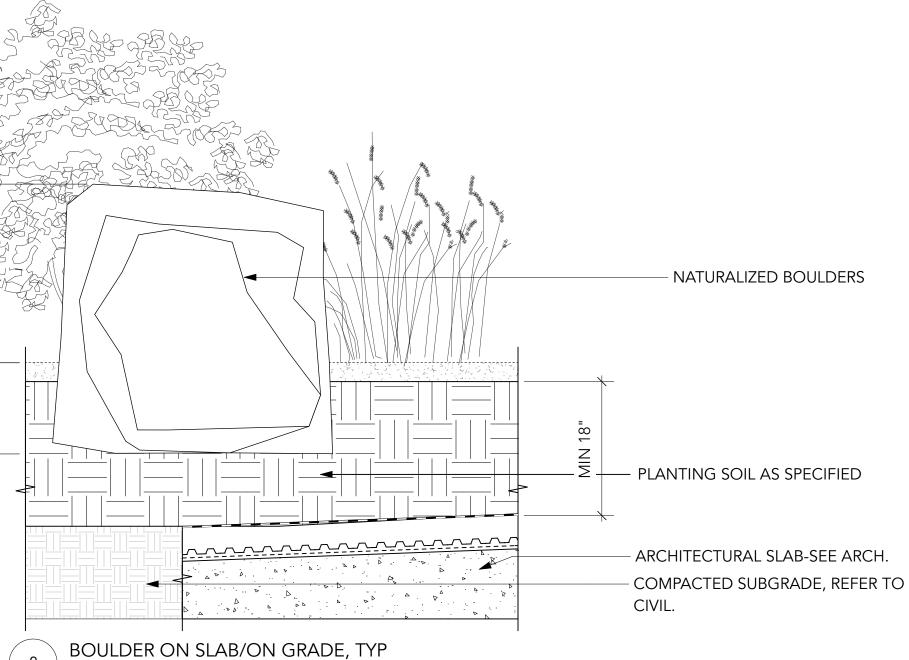
PAVING TYPE 5: PAVING SLABS ON BIRDS EYE GRAVEL, TYP

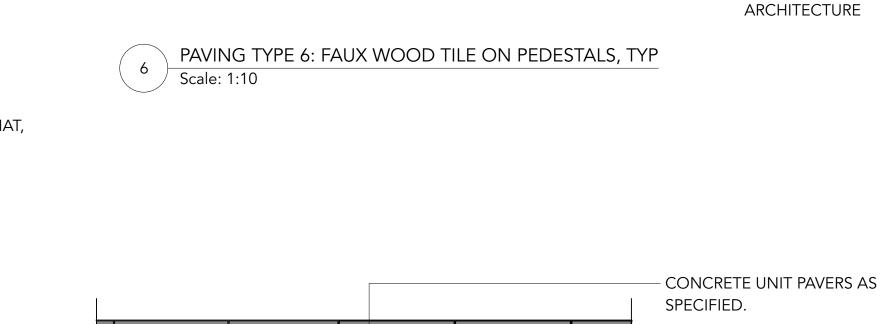

PAVING TYPE 7: CONCRETE UNIT PAVERS ON PEDESTALS, TYP

Scale: 1:10



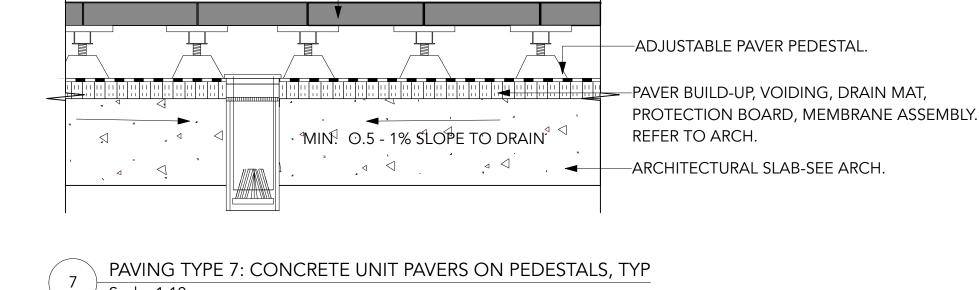

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-8" x 48" x 3/4" PORCELAIN

-DRAINBOARD, MEMBRANE AND

RIGID INSULATION, REFER TO

PAVERS, NOON PAVERS BY BELGARD, COLOUR: HONEY

-PAVER PEDESTALS

-FILTER FABRIC

ARCHITECTURAL

-BUILDING SLAB, SEE

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No. Description Date A ISSUED FOR SCHEMATIC 22-01-24 DESIGN B ISSUED FOR DEVELOPMENT 22-02-25 PERMIT C DEVELOPMENT PERMIT 22-10-25

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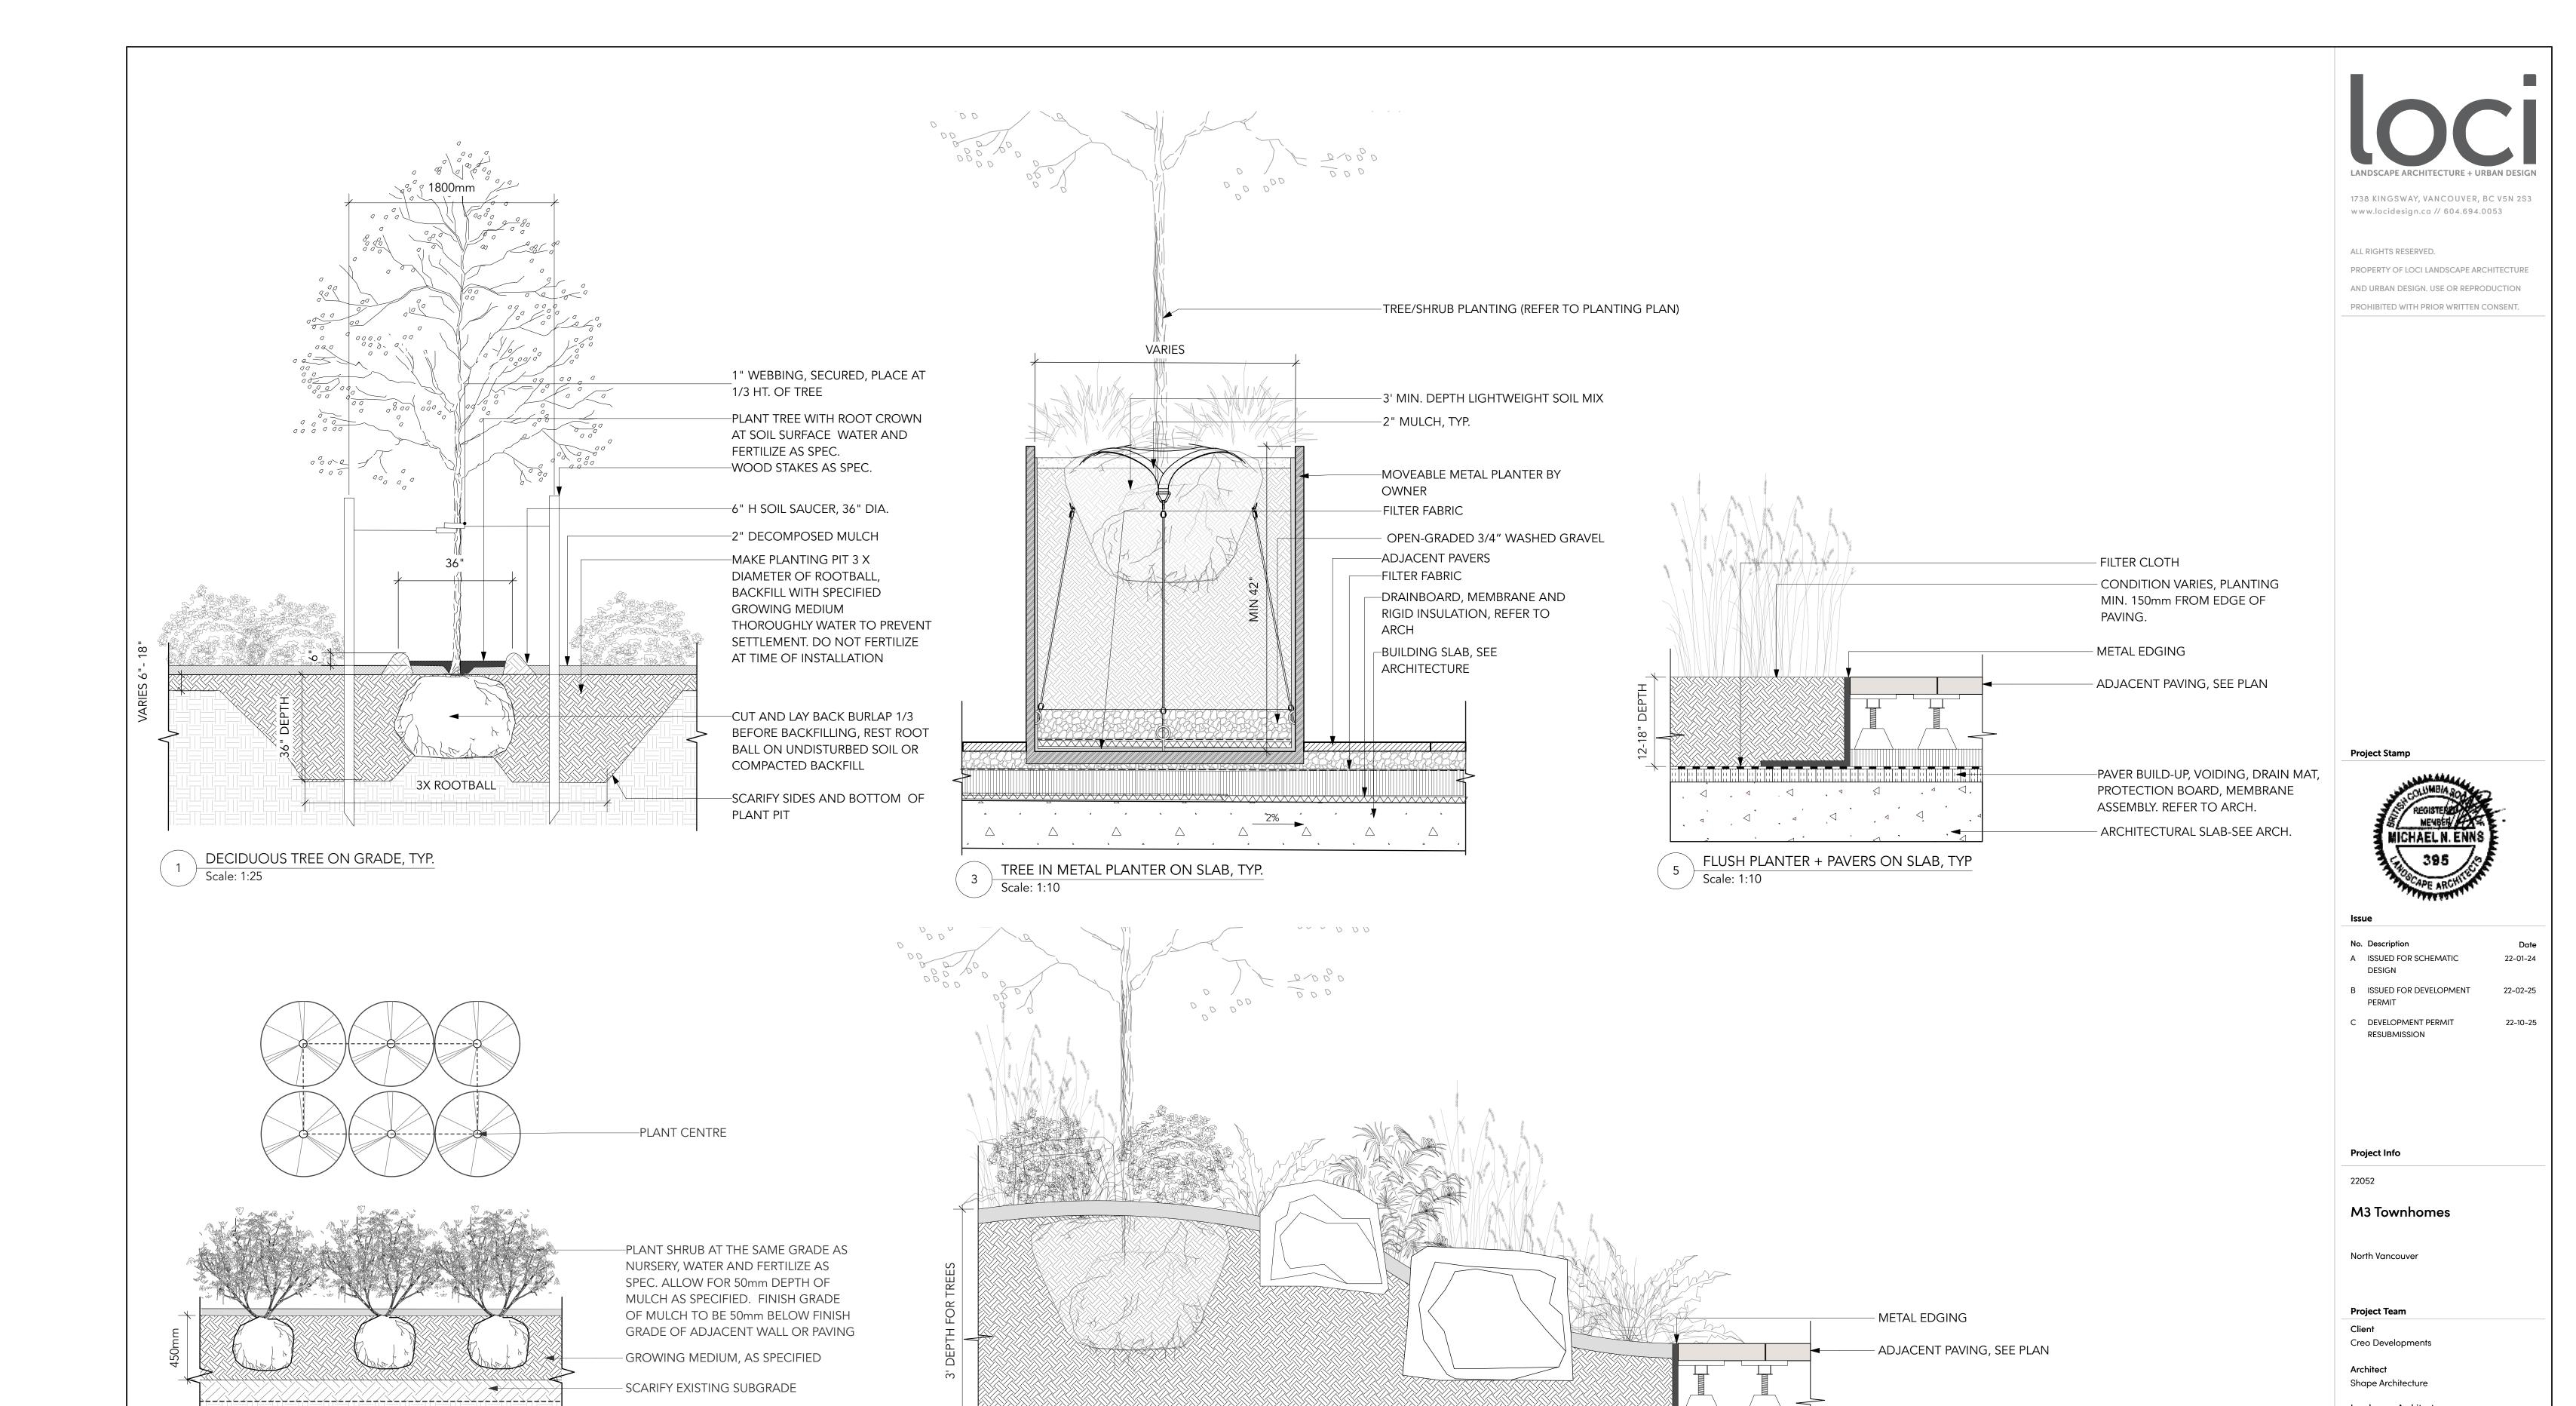
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DETAILS



FLUSH MOUNDED PLANTER ON GRADE

- EXISTING SUBGRADE

1. TRIANGULAR SPACING FOR IRREGULAR SHAPED

PLANTERS. AS SPECIFIED O.C. DISTANCE; ENSURE

2. REFER TO PLANT SCHEDULE AND PLANTING

SHRUB ON GRADE TYP. DETAIL

PLANTERS; GRID SPACING FOR RECTINEAR

PERIMETER ROW

Scale: 1:20

DETAILS

Drawn By

Landscape Architect

-PAVER BUILD-UP, VOIDING, DRAIN MAT,

PROTECTION BOARD, MEMBRANE

- ARCHITECTURAL SLAB-SEE ARCH.

ASSEMBLY. REFER TO ARCH.


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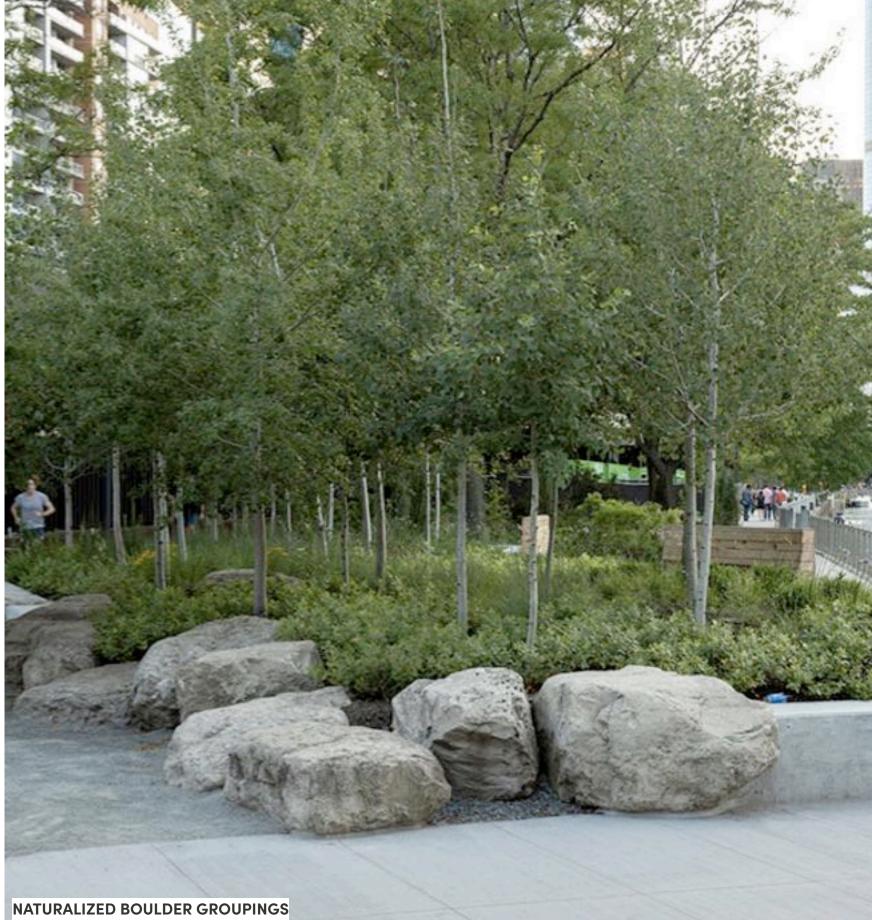
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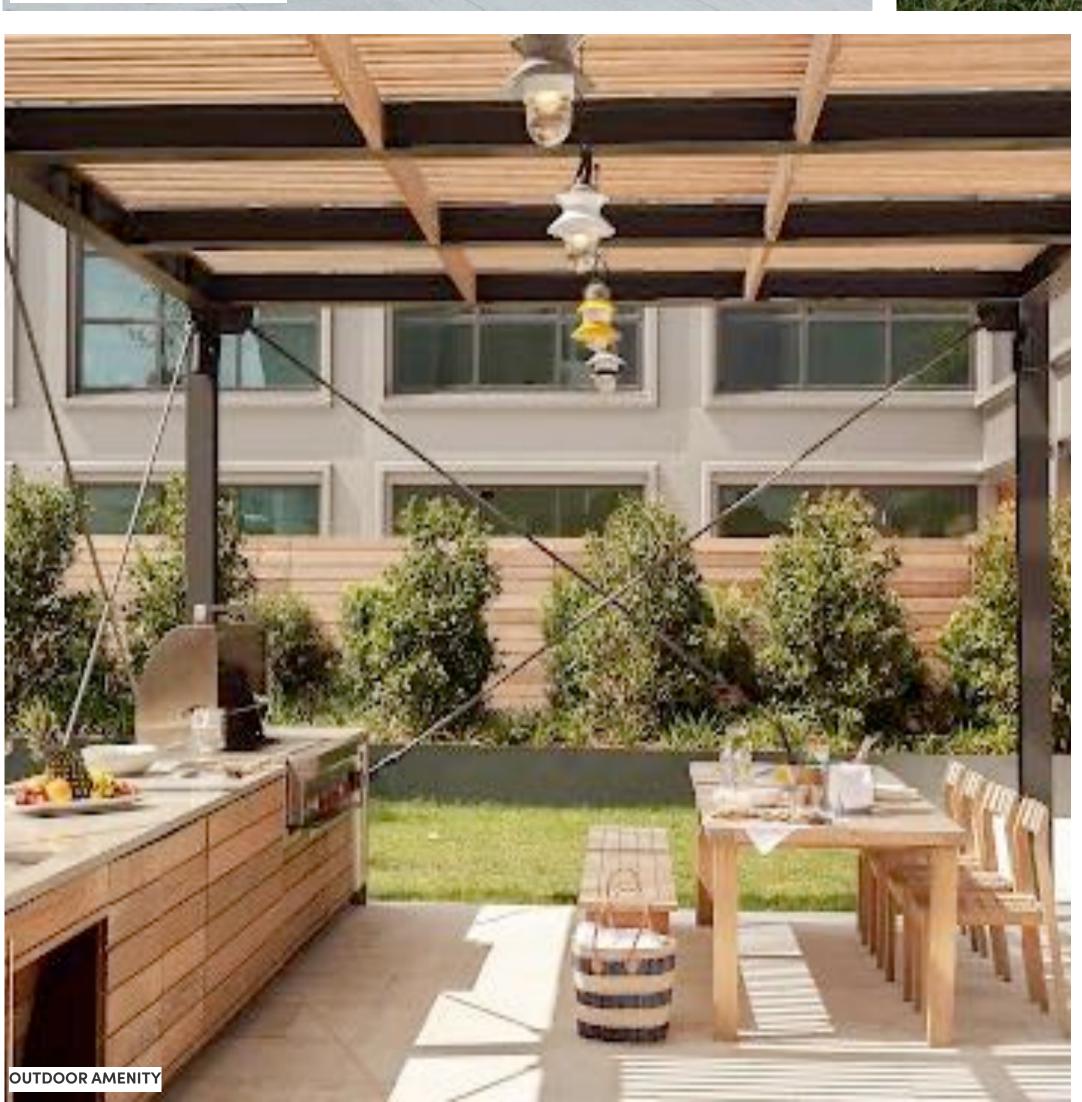
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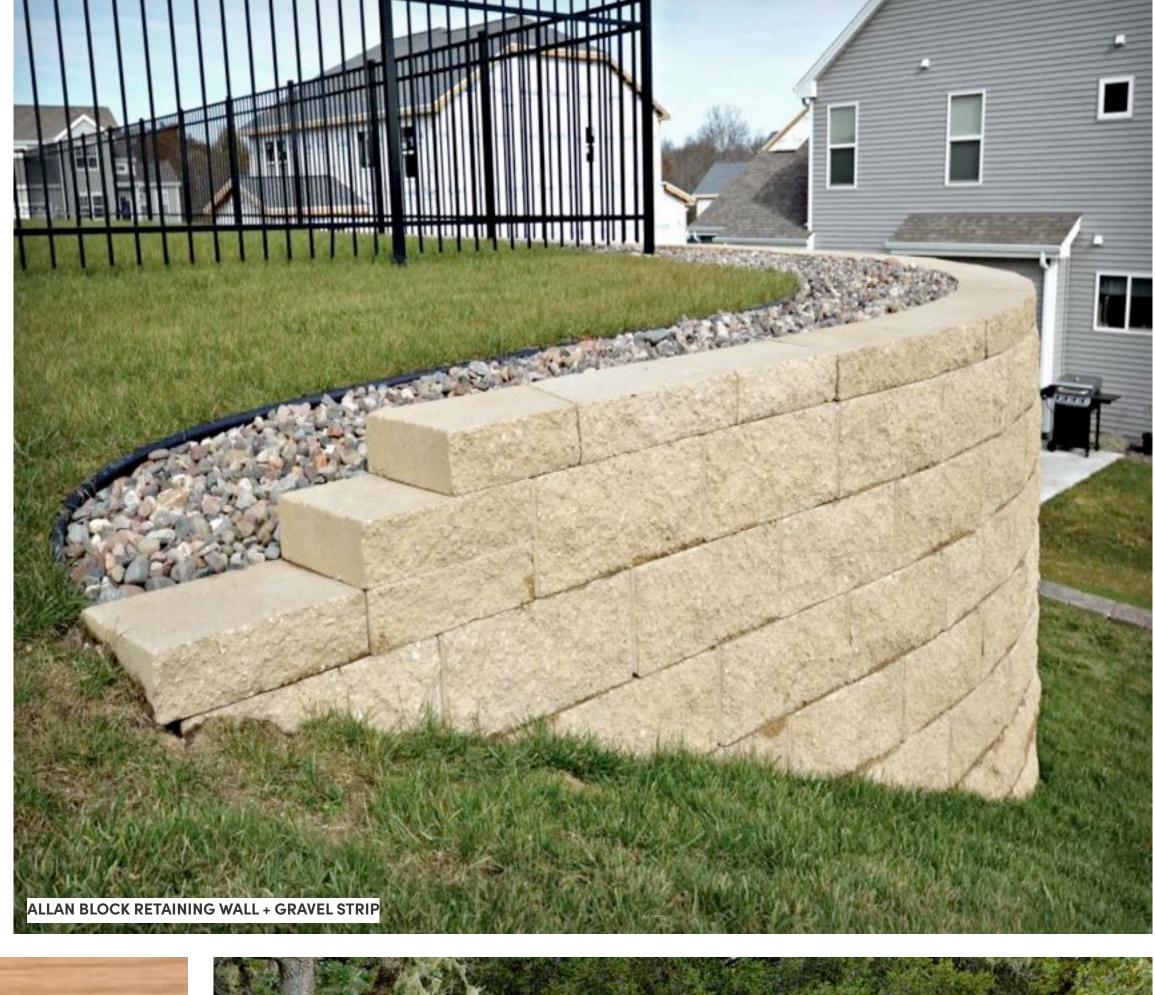











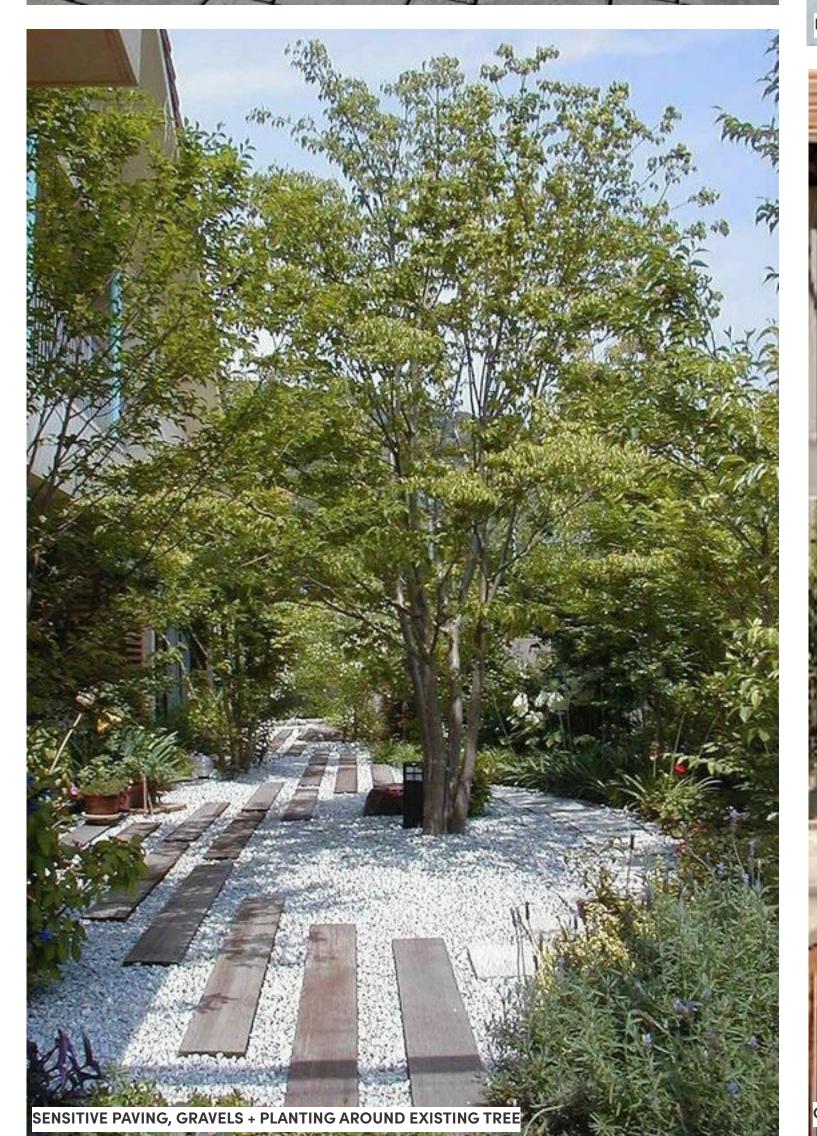

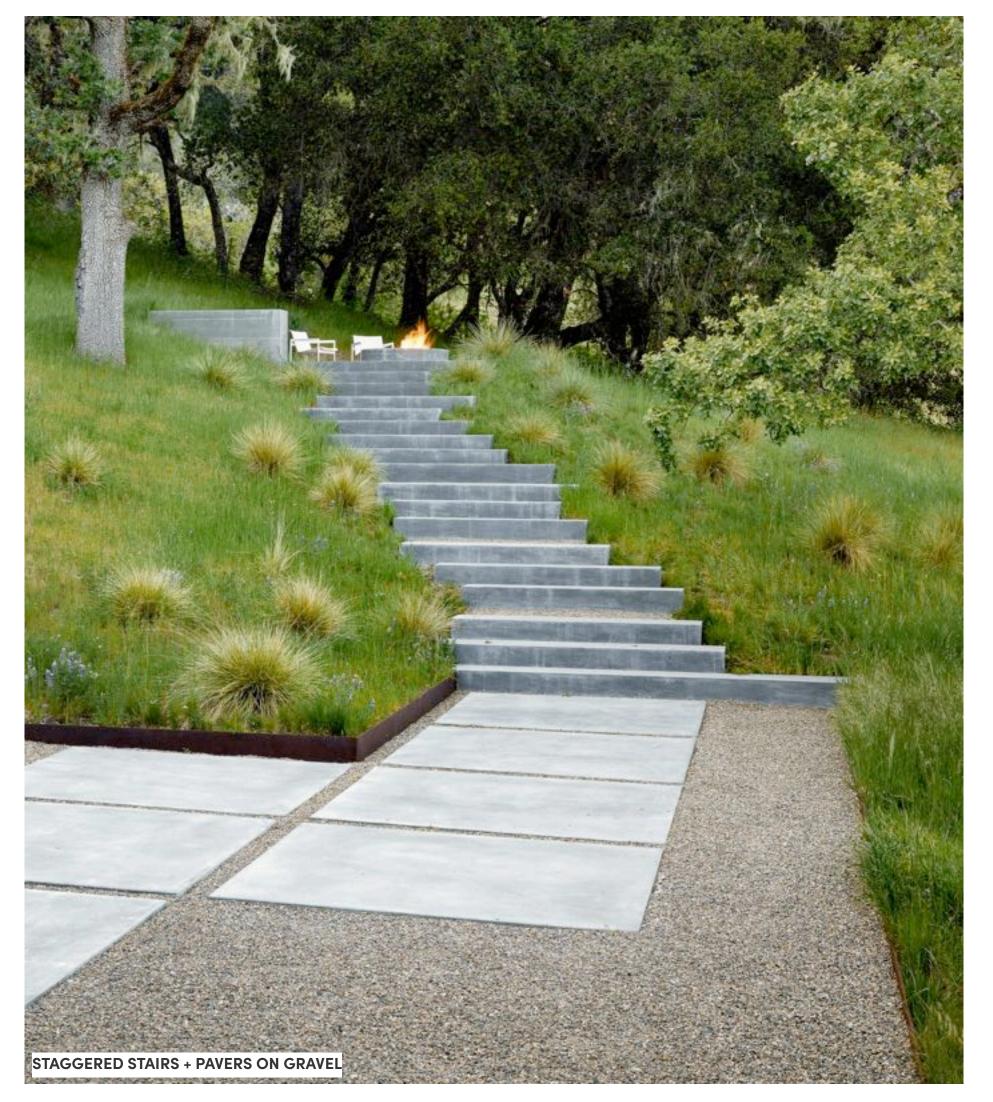



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PRECEDENT IMAGES

L8.0