LANDSCAPE CONTRACT DOCUMENTS

PROJECT: LANDSCAPE FOR MULTIFAMILY DEVELOPMENT

LOCATION: 2645 MAHON AVENUE, NORTH VANCOUVER **CLIENT:** KS MECHANICAL LTD. **ARCHITECT/ DESIGNER: HEARTH ARCHITECTURAL** LANDSCAPE ARCHITECT CONSULTANT: SW LANDSCAPE ARCHITECT ATTN: STEVE WONG 778 834-8959 stevewong234@gmail.com www.swlandscapearchitect.com

SUMMARY OF LANDSCAPE SCOPE OF WORK

SUMMARY: THE LANDSCAPE PORTION OF THE PROJECT INCLUDES ALL LANDSCAPE WORKS ASSOCIATED WITH A NEW RESIDENTIAL DEVELOPMENT PROJECT. THIS INCLUDES BUT NOT LIMITED TO, SITE DEMOLITION, SITE PREPARATION, GRADING AND DRAINAGE, SUPPLY AND INSTALLATION OF GROWING MEDIUM, LANDSCAPE PLANTS, MULCH, IRRIGATION SYSTEM, LANDSCAPE PAVERS, CIP CONCRETE WALK/WALLS/STAIRS, FENCING, GATES, LANDSCAPE LIGHTING, ONE YEAR WARRANTY AND ONE YEAR LANDSCAPE MAINTENANCE. CONTRACTOR IS RESPONSIBLE FOR PROVIDING ELECTRICAL AND WATER FEED TO ALLOW FOR THE INSTALLATION OF A COMPLETE, FUNCTIONING LANDSCAPE LIGHTING AND IRRIGATION SYSTEM. LANDSCAPE DESIGN/WORKS IS TO BE COORDINATED WITH THE ARCHITECT AND OTHER CONSULTANTS.

LANDSCAPE LIST OF DRAWINGS

- L0 COVER SHEET
- L1 LAYOUT
- L2 PLANTING PLAN
- L3 LIGHTING PLAN L4 TREE MANAGEMENT PLAN
- L5 DETAILS

GENERAL CONDITIONS OF THE CONTRACT

-REFER TO GENERAL CONDITIONS OF CONTRACT, BY PRIME CONSULTANT -REFER TO, AND COORDINATE THESE CONTRACT DOCUMENTS WITH THE CONTRACT DOCUMENTS OF THE OTHER CONSULTANTS AND THE MAIN CONTRACT

LANDSCAPE SPECIFICATIONS

CANADIAN LANDSCAPE STANDARD (CLS), SECOND EDITION COPYRIGHT, 2020, ISBN: 978-0-9950714-1-4 -PUBLISHED JOINTLY BY CANADIAN SOCIETY OF LANDSCAPE ARCHITECTS 12 FORILLON CRESCENT, OTTAWA ON K2M 2W5 1-613-668-4775 csla-aapc.ca CANADIAN NURSERY LANDSCAPE ASSOCIATION 7856 FIFTH LINE SOUTH MILTON ON L9T 2X8 1-888-446-3499 cnla-acpp.ca

SUPPLEMENTARY SPECIFICATIONS- PROJECT SPECIFIC:

9. LANDSCAPE MAINTENANCE: ADD: PER SECTION 9.1.5, ESTABLISHMENT AND WARRANTY MAINTENANCE, THE MAINTENANCE PERIOD WILL BE FOR 1 CALENDAR YEAR FROM DATE OF ACCEPTANCE. PER SECTION 9.1.7. MAINTENANCE LEVEL FOR THIS PROJECT WILL BE AT LEVEL 3 "MODERATE"

CLS SPECIFICATIONS

- SCOPE OF THE STANDARD
- CONTRACT ADMINISTRATION SITE PREPARATION AND PROTECTION
- **GRADING AND DRAINAGE**
- **GROWING MEDIUM**
- PLANTS AND PLANTING
- MULCHING
- SEEDING AND SODDING
- LANDSCAPE MAINTENANCE IRRIGATION SYSTEMS 10.
- INTEGRATED PEST AND VEGETATION MANAGEMENT 11.
- 12. HARDSCAPE
- LANDSCAPE OVER STRUCTURES 13. 14. INTERIOR PLANTSCAPE N/A

APPENDIX A: LIST OF TABLES AND FIGURES APPENDIX B: BASIC CONTENTS OF A LANDSCAPE COMMISSIONING PLAN **APPENDIX C: CANADIAN NURSERY STOCK STANDARD, NINTH EDITION** APPENDIX D: NATIONAL VOLUNTARY CODE OF CONDUCT FOR THE ORNAMENTAL HORTICULTURE INDUSTRY **GLOSSARY OF TERMS AND DEFINITIONS**

2. MMCD (LATEST EDITION) SPECIFICATIONS AND DRAWINGS, WITH MUNICIPAL

SUPPLEMENTARY SPECIFICATIONS AND ALL APPLICABLE MUNICIPAL BY-LAWS.

3. FOR ALL CHILDREN'S PLAY SPACES AND EQUIPMENT, THE FOLLOWING STANDARDS ARE APPLICABLE: CAN/CSA-Z614-14 AND IPEMA (INTERNATIONAL PLAY EQUIPMENT MANUFACTURERS ASSOCIATION) STANDARD. SPECIFICATIONS FOR PLAY SURFACES TO INCLUDE ASTM F1292/1951/2075/2223/F355

NOTES:

IN CASE OF CONFLICTING SPECIFICATIONS THE MOST STRINGENT SPECIFICATION PREVAILS CONTRACTOR TO PROVIDE DIGITAL PHOTOS TO THE LANDSCAPE ARCHITECT FOR ALL WORK THAT WILL BE BURIED OR CONCEALED IN ORDER TO CONFIRM THAT THE WORK MEETS SPECIFICATIONS AND APPLICABLE STANDARDS

CONTRACTOR TO PROVIDE DIGITAL PHOTOS OF ALL TREES AT THE NURSERY FOR LANDSCAPE ARCHITECT APPROVAL PRIOR TO SHIPPING. PHOTOS ARE TO BE REPRESENTATIVE OF THE PLANTS TO BE SHIPPED AND CLEARLY SHOW THE QUALITY AND SIZE OF THE PLANTS. A MEASURING STICK MUST BE USED TO SHOW THE HEIGHT OF A PLANT AS WELL AS A TAPE MEASURE TO SHOW CALIPER SIZE.

PLANT SEARCH IS TO INCLUDE ALL NURSERIES WITHIN THE REGION OF METRO VANCOUVER. 4. CONTRACTOR TO PROVIDE DOCUMENTATION (EG INVOICES, SHIPPING RECEIPTS) THAT 4 CONFIRM GENUS, SPECIES, CULTIVAR AND SIZE FOR ALL PLANT MATERIAL INCLUDING SOD THAT IS SHIPPED TO SITE

ALL PLANT MATERIAL TO BE INSTALLED BY 0CTOBER 15 AT THE LATEST, OTHERWISE PLANTING WILL BE REQUIRED TO BE POSTPONED UNTIL THE SPRING OF THE FOLLOWING YEAR.

GENERAL PROJECT AND CONTRACTOR NOTES

- Architect, Engineer)
- vicinity.
- codes and standards.
- more stringent
- specification to that originally specified.
- the contractor's expense.

GENERAL LANDSCAPE NOTES

- 4. No slopes to be steeper than 2.5 horizontal: 1 vertical.
- over scarified subgrade.
- past the end of top/bottom treads.
- Building code.

GENERAL TREE NOTES

- critical root zone.
- Contact your project arborist for any TPZ barrier issues.
- 6. Refer to arborist report and drawing where applicable.

1. Contractor shall review these plans thoroughly, make a detailed site visit, and shall immediately bring any inconsistency, site layout problem, or any other request for clarification to the Landscape Architect for resolution prior to the delivery of any bid. Failure to do so shall cause the

Contractor to be ineligible for extras relating to such matters. 2. Contractor shall submit reproducible shop drawings to Landscape Architect for Owner's approval.

3. Contractor shall co-ordinate with all trades to provide complete working systems.

4. Drawings of existing facilities are, in general, diagrammatic. Exact locations shall be determined by the Contractor from field measurements taken by Contractor's personnel. Actual arrangement of the work shall follow locations shown on the drawings within the constraints of existing equipment and construction. Dimensions shall govern these drawings and they are not to be

scaled. Any scales on drawings are only for the Contractor's convenience. Drawing and notes to drawings are correlative and have equal authority and priority. Should there be discrepancies in themselves or between them, Contractor shall base bid pricing on the most expensive

combination of quality and/or quantity of the work indicated. In the event of discrepancies, the appropriate method of performing the work and/or items to be incorporated into the scope of the work shall be determined by the appropriate design professional (eg Landscape Architect,

5. Contractor is responsible for the safety, actions and conduct of his employees and his subcontractors' employees while in the project area, adjacent areas and in the building and its

6. All work described by these documents shall be performed in full accordance with all applicable

7. 7 All materials, finishes, manufactured items, and equipment shall be installed in full accordance with the supplier's or manufacturer's written recommendations or these documents, whichever is

8. Requests to substitute any product, technique, or material shall be submitted in writing to Landscape Architect for approval. Samples, product information, and drawings shall be required prior to substitution approval. Proposed substitution shall be of equal quality and performance

9. All workmanship, material, and equipment shall be guaranteed for one year from date of Owner acceptance. Any failure or deterioration within this period shall be corrected by the contractor at

10.Coordinate landscape drawings with architect/engineer and all other consultant drawings.

1. All landscape works are to meet the specifications and standards of the latest edition of the CANADIAN LANDSCAPE STANDARD, published by the Canadian Society of Landscape Architects and the Canadian Nursery landscape Association.

2. All landscape works to be carried out by a contractor with minimum 5 years' experience doing work similar in scope and size, and on at least 3 comparable projects. The contractor needs to be a member in good standing with the appropriate trade organization: eg, B.C. Landscape and Nursery Association (BCLNA), Irrigation industry Association of B.C. (IIABC). Execution of work to be under the direct supervision of qualified industry certified technicians.

3. All grades to meet adjacent grades at property line. All stormwater is to be contained on site and away from adjacent properties. All hard surfaces to be sloped a minimum of 1.5%, and all lawn areas to be sloped a minimum of 2% to avoid standing water. Contractor is ultimately responsible for ensuring there is no standing water on site over an extended period.

5. All plant material and growing medium to meet Canadian Landscape Standard #1 specifications Plant search area is to be any plant nursery within the Lower Mainland. Plant substitutions are only allowed if approved by Landscape Architect. Suggested plant substitutions shall be of similar species and of at least equal size to those originally specified.

6. All shrub beds to contain minimum 18" (450) mm depth of approved growing medium over scarified subgrade. All lawn areas to contain minimum 6" (150) mm of approved growing medium

7. All guardrails are required wherevever the fall height is over 2 ft. Guardrails to be a minimum 42" high from any climbable surface surface. Maximum openings between pickets to be under 4". 8. Stairs to have consistent rise/run for risers and treads. Stair treads to slope 2% to front edge of tread for drainage and constructed with materials or finishes to prevent slip falls. All stairs over 2 risers to have handrails between 32" to 38" high from the front of stair treads, and to extend 12"

9. Exterior ramps to adhere to BC Building code if greater than 5% slope. Ramps to be maximum of 8.3% and minimum 5' width. Handrails required on both sides. Construction to adhere to BC

10.All retaining walls and structures over 4 ft. in height or if there are issues with soil stability require signoff from the approriate engineer (eg structural, geotechnical). Contractor to provide engineer stamped shop drawings for Landscape Architect.

11.Landscape installation to be reviewed by registered Landscape Architect.

Any permitted tree removal(s) must be performed by a qualified professional.

2. No grade changes are to occur within the critical root zones of any retained trees. Any exposed roots from lines of excavation must be covered with burlap and then poly plastic in an effort to prevent dessication of exposed roots; this root curtain must be removed prior to backfilling. Trees must be adquately watered during the entire construction process.

3. The removal of existing organics within the critical root zones of retained trees must be performed manually, when installing new plant material within the critical root zones of retained trees, if large roots (1.5' diameter and larger) are encountered, then new plantings must be shifted to accommodate. No more than 3" of additional soil for new landscaping may be added within any

4. Any excavation work or work within the protection zone of retained trees requires the supervision of a certified arborist. This includes, but is not limited to; demolition, the installation of any permeable or impermeable surfaces (concrete, asphalt, pavers, etc.), installation of permanent or temporary services (gas, sewer, storm, sanitary, communication, electrical, irrigation, etc.), during the installation of patios, driveways, or any hardscape, during the installation of footings for fences, walls, decorative walls, retaining walls, decks, and deck footings.

5. Construction materials must not be stored within the tree protection zone (TPZ) of trees to be retained, and TPZ fencing to remain intact for the entire construction process. Signage must be clearly posted on each side of the barrier indicating 'Tree protection zone-Do not enter of modify'

MATERIALS LIST-COORDINATE WITH SPECIFICATIONS

- 1. CONCRETE FLATWORK: Per applicable industry standards. Concrete to be reinforced with rebar and/or WWM as shown on drawings. For concrete flatwork, provide medium broom finish with 2% cross slope, over min. 4" compacted granular base with expansion joints as required, and control joints @ 5'OC and where there is potential for cracking. Provide shop drawings for consultant review prior to placing showing expansion and control joints
- 2. FENCE- POST SADDLE BRACKET: By Simpson Strong-Tie, WUB44RHDG for full dimension 4" post, galvinized with 15M rebar
- 3. FENCE-WOOD: Full dimension #2 and better cedar boards, finished with 2 coats of Sikkens semi-transparent cedar stain. Posts and kick board to be full dimension wood, incised and rated for ground contact approved per CCA/MCA PT
- 4. GRANULAR BASE: To be minimum 4" depth of 3/4" minus road base compacted to 95% MPD and free of impurities per MMCD specifications.
- 5. GRAVEL LAYER: 3/4" diameter crush drain rock at depth of 4" min
- 6. GROWING MEDIUM: In accordance with CLS standards, latest edition. For Turf Areas: Level 1H (High Traffic Lawn Areas), containing by weight: 70-90% sand, maximum 25% fines (max 20% clay), 3-5% organic matter, with pH between 6-7; For Planting Areas: Level 1P (Planting Areas), containing by weight: 50-70% sand, maximum 25% fines (max 20% clay), 10-20% organic matter, with pH between 4.5-6.5. Minimum 6" depth for lawn areas on grade, 18" min for planted areas on grade, over scarified base, or as otherwise specified. A current representative soil analysis is to be done by Pacific Soil Analysis, Richmond to confirm soil sample meets specifications prior to shipping. If after shipping the quality of the soil is in question, further sampling and testing by Pacifc Soil Analysis will be required at contractor's expense. It is the contractor's responsibility to ensure all growing medium used meets specifications. If it is determined that the soil does not meet CLS Specifications, the soil is to be removed at contractor's expense. Contact information for Pacific Soil Analysis is: #5-11720 Voyageur Way, Richmond, BC V6X 3G9: Phone (604) 273-8226. For growing medium on roof or suspended slab, see section under Green Roof.
- 7. HANDRAILS FOR STAIRS: 36 " high measured from front edge of tread, powder coated medium gloss charcoal aluminum, installed to BC Building code. Exact style to be determined by Owner.
- 8. IRRIGATION: Supply and installation required for a complete automatic, inground irrigation system to provide supplemental water efficiently and uniformly. All components to be new, and includes all pipes, sleeves, valves, in-ground irrigation boxes, sprinkler heads, solenoid wires, controller and rain sensor. Quick couplers to be on their separate zone. Controller to have 2 extra zones for future expansion and if installed outside, to have controller and wiring secured in a lockable, weatherproof box. Irrigation components to be Rainbird, Toro or Hunter. Irrigation design and installation per Canadian Landscape Standards, latest edition. Design to be completed by a qualified designer/contractor with IIABC. Shop drawings for the irrigation design are to be provided by contractor and to be approved by the landscape architect prior to installation. Contractor is responsible for providing a water service line and connecting irrigation system to water service line complete with backflow preventor, pressure reducing valve, blowout and isolation valves. Contractor to adjust irrigation controller, sprinkler heads, drip lines and commission system in addition to providing as-built drawings and a one year warranty
- 9. LIGHTING-BY KICHLER: Lighting fixtures and accessories to be Kichler 12 V, LED, as required from the following: STEP LIGHT: KIC-5782BKT27 .86W/ PATH LIGHT: KIC-15805BKT27 4W/ ACCENT LIGHT:KIC-16155BKT27 3.5W/ HARDSCAPE: KIC-16103GRY27 2.7W/ WALL WASH: KIC-16070BKT27R 4.3W/ BOLLARD: KIC-16070BKT27R 3.8W/ DECK LIGHT: KIC-15764CBR .86W/ Transformer sized to allow for an additional 50 watt capacity; Photocell controller to be Kichler 15565BK or equivalent, with a 24 hour digital timer. Lighting to be installed as a complete working system with wires, connectors, mounting hardware, transformer, photocell and timer. Contractor is responsible for providing a power source and to have transformer and timer secured in a lockable and weatherproof cabinet if accessible to the public. All wires to be hidden and
- buried min 8" in soil. Refer to architectural drawings for specifications for exterior building lights. 10. LIGHTING-GENERAL: Contractor is responsible for providing a complete operating system with power source, wiring, photocell sensor and timer. If timer is outside, it will need to be secured in a lockable and weatherproof cabinet. All work to conform to applicable codes.
- 11. MULCH: To be composted fir bark, having dark brown, fine texture and ½" minus, applied evenly at a 2" depth over plant beds. Available from Augustine Soil and Mulch (604 465-5193) or equivalent.
- 12. PLANT MATERIAL: All plant material are to meet current Canadian Landscape Standard (CLS) #1 and installed according to current CLS standards by qualified contractor. Plant search is throughout the Metro Vancouver area except if indicated otherwise. Any plant substitutions must be approved by Landscape Architect. See Notes on left column of Cover Page.
- 13. RAILINGS: Height per drawings. Finish to be powder coated medium gloss black charcoal. Railings to be installed where there is a fall height of 2' or more, minimum 42: high and installed per BC Building code. Maximum gap between pickets to be 4". Posts to be min 2" d. and maximum 6' oc. Coordinate with architect/engineering drawings. Exact style to be determined by Owner. Contractor to supply shop drawings for approval by landscape archiect.
- 14. RETAINING WALL-CONCRETE: Per applicable industry standards. Concrete to be reinforced with rebar as shown on drawings. Drawings are to be confirmed with structural engineer. For retaining walls over 4' high, or where there may be issues with glaobal stability, stamped engineered drawings are required. Provide shop drawings for consultant review prior to placing showing expansion and control joints.
- 15. SOD: All sod to be sand based sod (Perennial rye/Kentucky bluegrass) with no netting. No clay or silt soil to be allowed with sod. 16. STEPS-CONCRETE: Medium broom finish, sloped 2% to front of tread per BC Building code. Coordinate with
- architect/engineering drawings.
- 17. WOOD: Per industry standards. All exterior wood to be rot resistant, either western red cedar, yellow cedar, robinia, ipe or pressure treated (PT). Minimum standard to be #2 and better. Wood to be finished with minimum 2 coats of an approved exterior grade finish. All wood in contact with ground to be incised, ground contact approved per CCA/MCA PT. All cuts to be sealed prior to installation.

NOTE: ALL MATERIALS SHOWN ON DRAWINGS ARE NOT NECESSARILY INCLUDED IN THIS MATERIALS LIST. CONTRACTOR IS RESPONSIBLE FOR DETERMINING ALL MATERIALS REQUIRED TO COMPLETE LANDSCAPE WORKS PER CONTRACT DOCUMENTS.



AERIAL VIEW OF PROJECT SITE- UP IS NORTH




STREET VIEW OF PROJECT SITE

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	stevewong23	4@gmail.com 778 834-8959				
	www.swlandscapearchitect.com					
Client	KSI	MECHANICAL LTD				
Project	Project Title					
	MULTI	FAMILY DWELLING				
	2645 MAHON AVENUE, NV					
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GENERAL PROJECT AND CONTRACTOR NOTES

- 1. Contractor shall review these plans thoroughly, make a detailed site visit, and shall immediately bring any inconsistency, site layout problem, or any other request for clarification to the Landscape Architect for resolution prior to the delivery of any bid. Failure to do so shall cause the Contractor to be ineligible for extras relating to such matters.
- 2. Contractor shall submit reproducible shop drawings to Landscape Architect for Owner's approval. 3. Contractor shall co-ordinate with all trades to provide complete working systems.
- 4. Drawings of existing facilities are, in general, diagrammatic. Exact locations shall be determined by the Contractor from field measurements taken by Contractor's personnel. Actual arrangement of the work shall follow locations shown on the drawings within the constraints of existing equipment and construction. Dimensions shall govern these drawings and they are not to be scaled. Any scales on drawings are only for the Contractor's convenience. Drawing and notes to drawings are correlative and have equal authority and priority. Should there be discrepancies in themselves or between them, Contractor shall base bid pricing on the most expensive combination of quality and/or quantity of the work indicated. In the event of discrepancies, the appropriate method of performing the work and/or items to be incorporated into the scope of the work shall be determined by the appropriate design professional (eg Landscape Architect, Architect, Engineer)
- 5. Contractor is responsible for the safety, actions and conduct of his employees and his subcontractors' employees while in the project area, adjacent areas and in the building and its vicinity.
- 6. All work described by these documents shall be performed in full accordance with all applicable codes and standards.
- 7. 7 All materials, finishes, manufactured items, and equipment shall be installed in full accordance with the supplier's or manufacturer's written recommendations or these documents, whichever is more stringent.
- 8. Requests to substitute any product, technique, or material shall be submitted in writing to Landscape Architect for approval. Samples, product information, and drawings shall be required prior to substitution approval. Proposed substitution shall be of equal quality and performance specification to that originally specified.
- 9. All workmanship, material, and equipment shall be guaranteed for one year from date of Owner acceptance. Any failure or deterioration within this period shall be corrected by the contractor at the contractor's expense.
- 10.Coordinate landscape drawings with architect/engineer and all other consultant drawings.

No.	Date	Issue/Revision Notes		
A	10/7/2023	FOR COORDINATION		
	10/1/2023			
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www.swlandscapearchitect.com				
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Project Title				
MULTIFAMILY DWELLING				
2645 MAHON AVENUE, NV				
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LEGEND

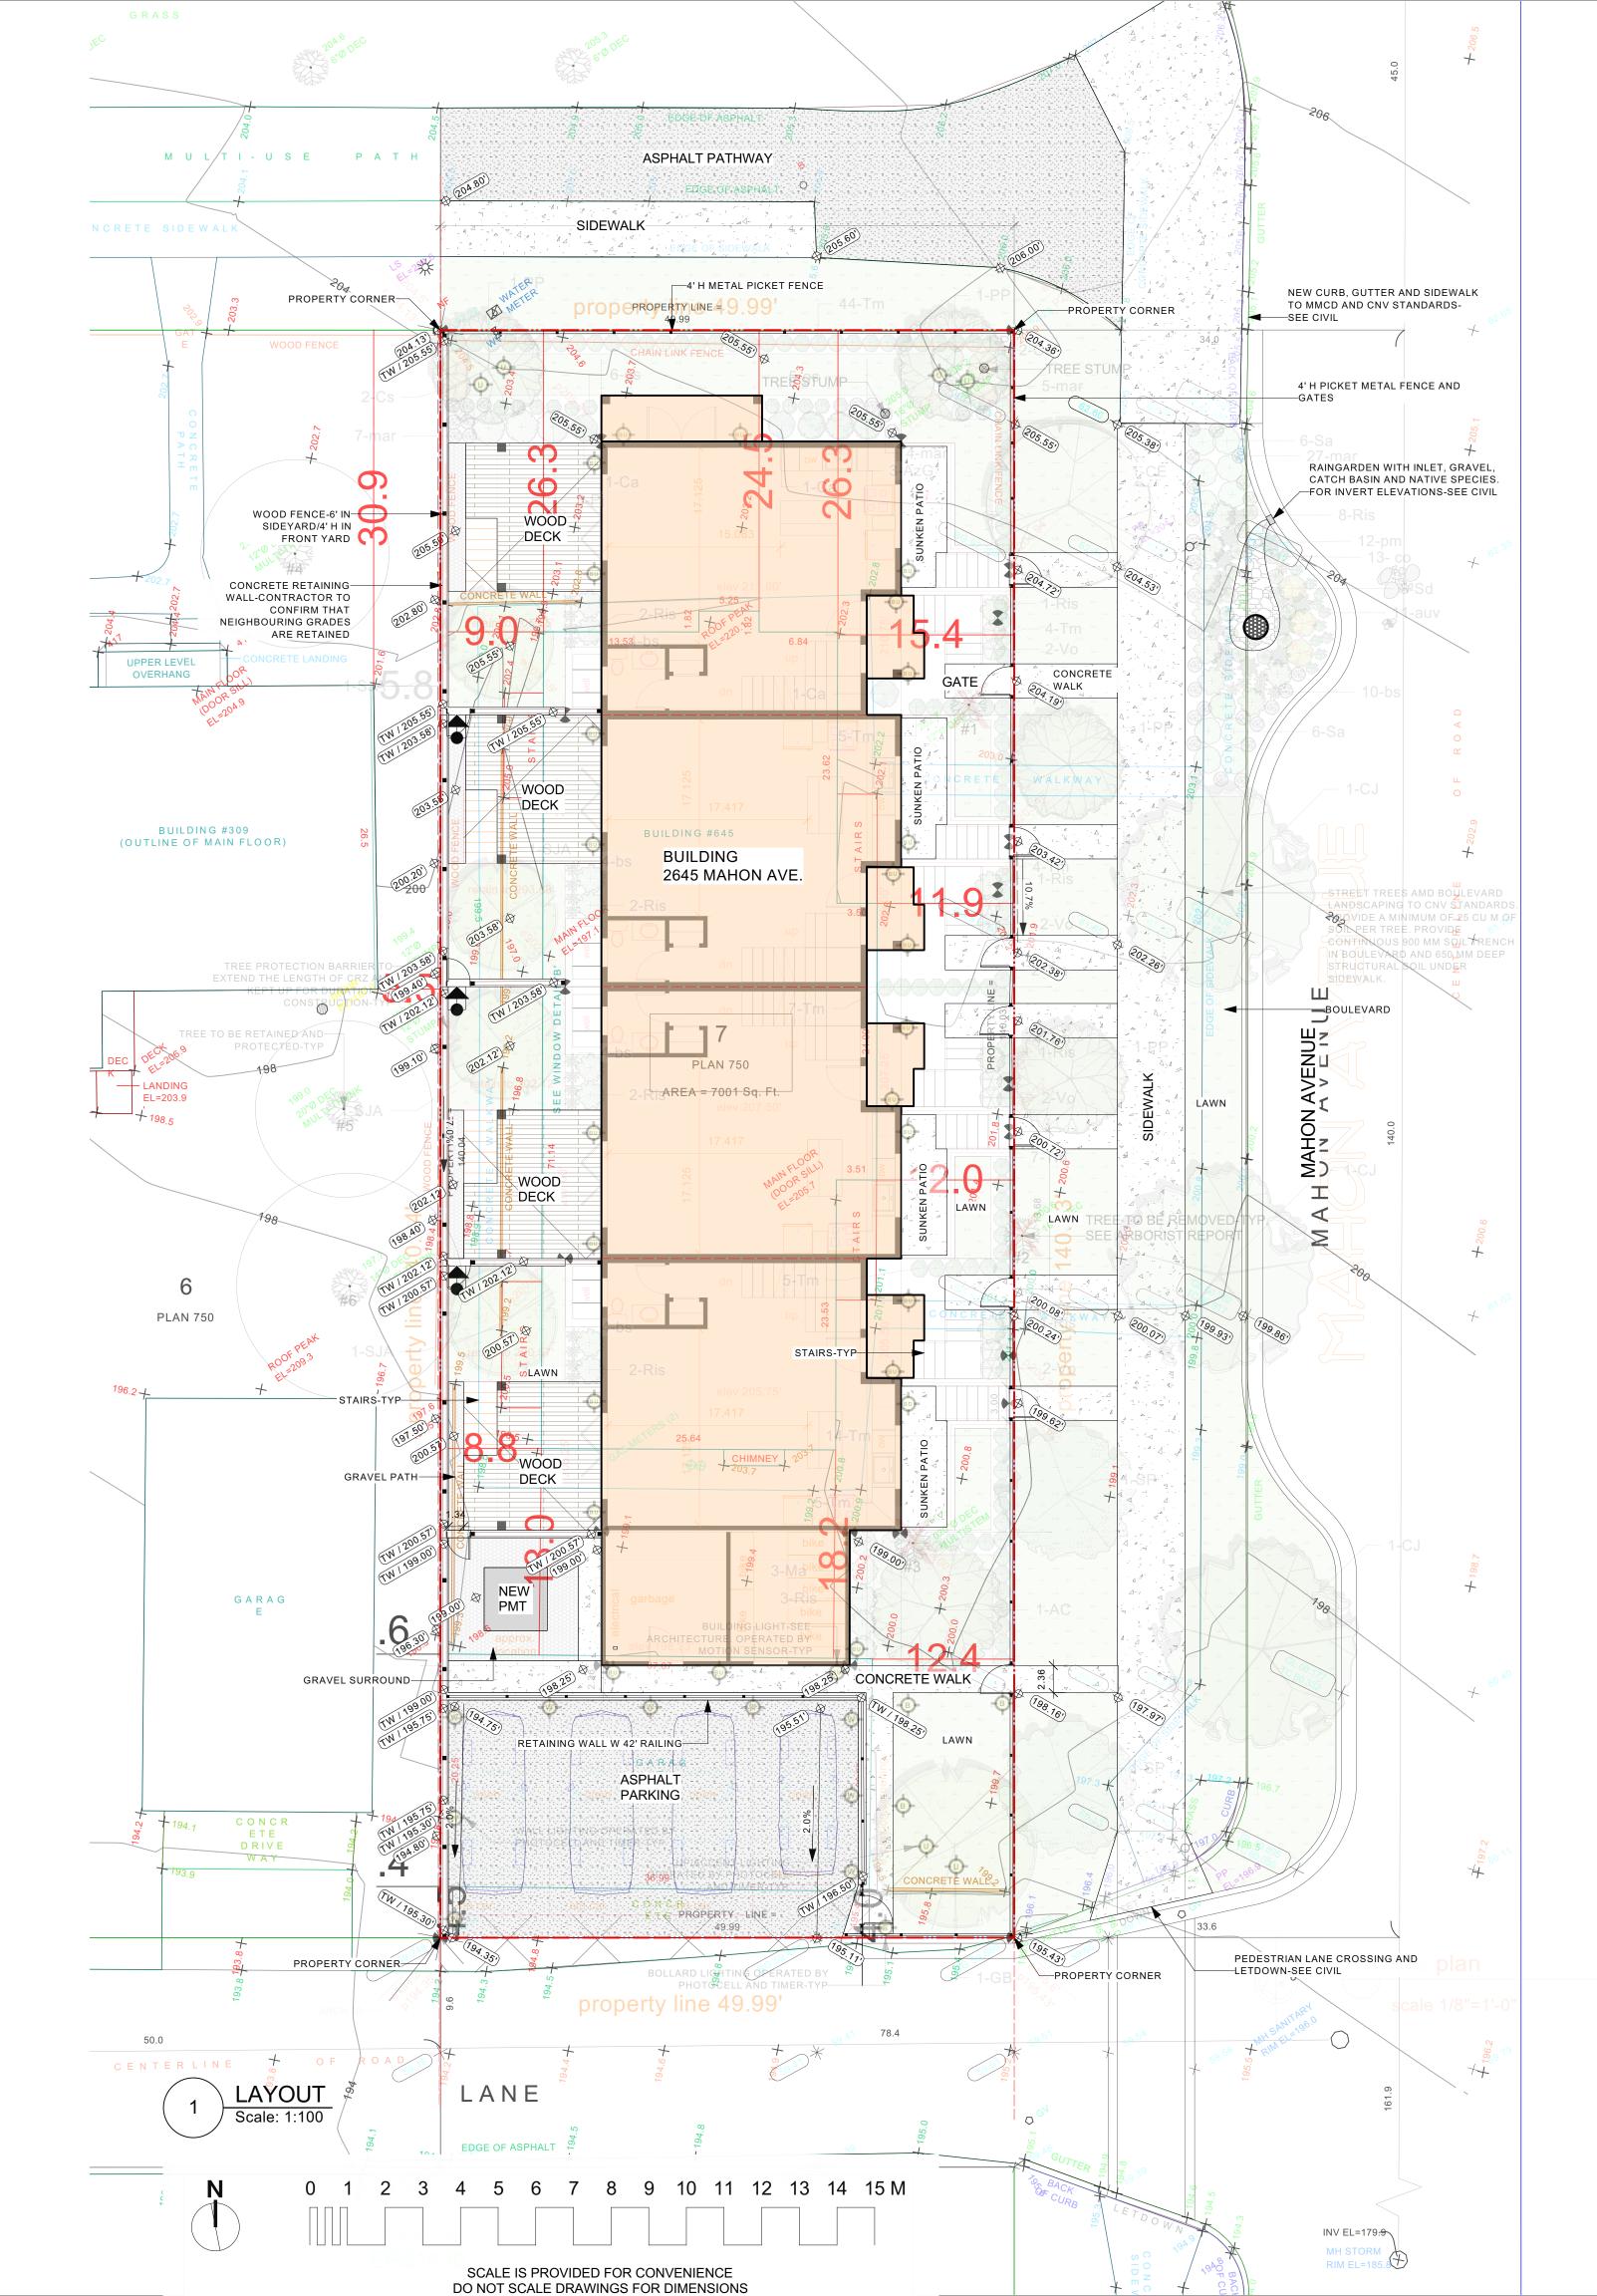
⊕ (219.33')

EXISTING ELEVATION

PROPOSED ELEVATION


⊕ (TW / 222.25') 🕀 (BW / 223.81')

PROPERTY LINE

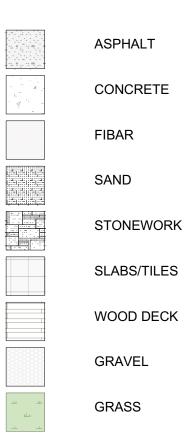


PROPOSED TOP OF WALL ELEVATION PROPOSED BOTTOM OF WALL ELEVATION

AREA DRAIN

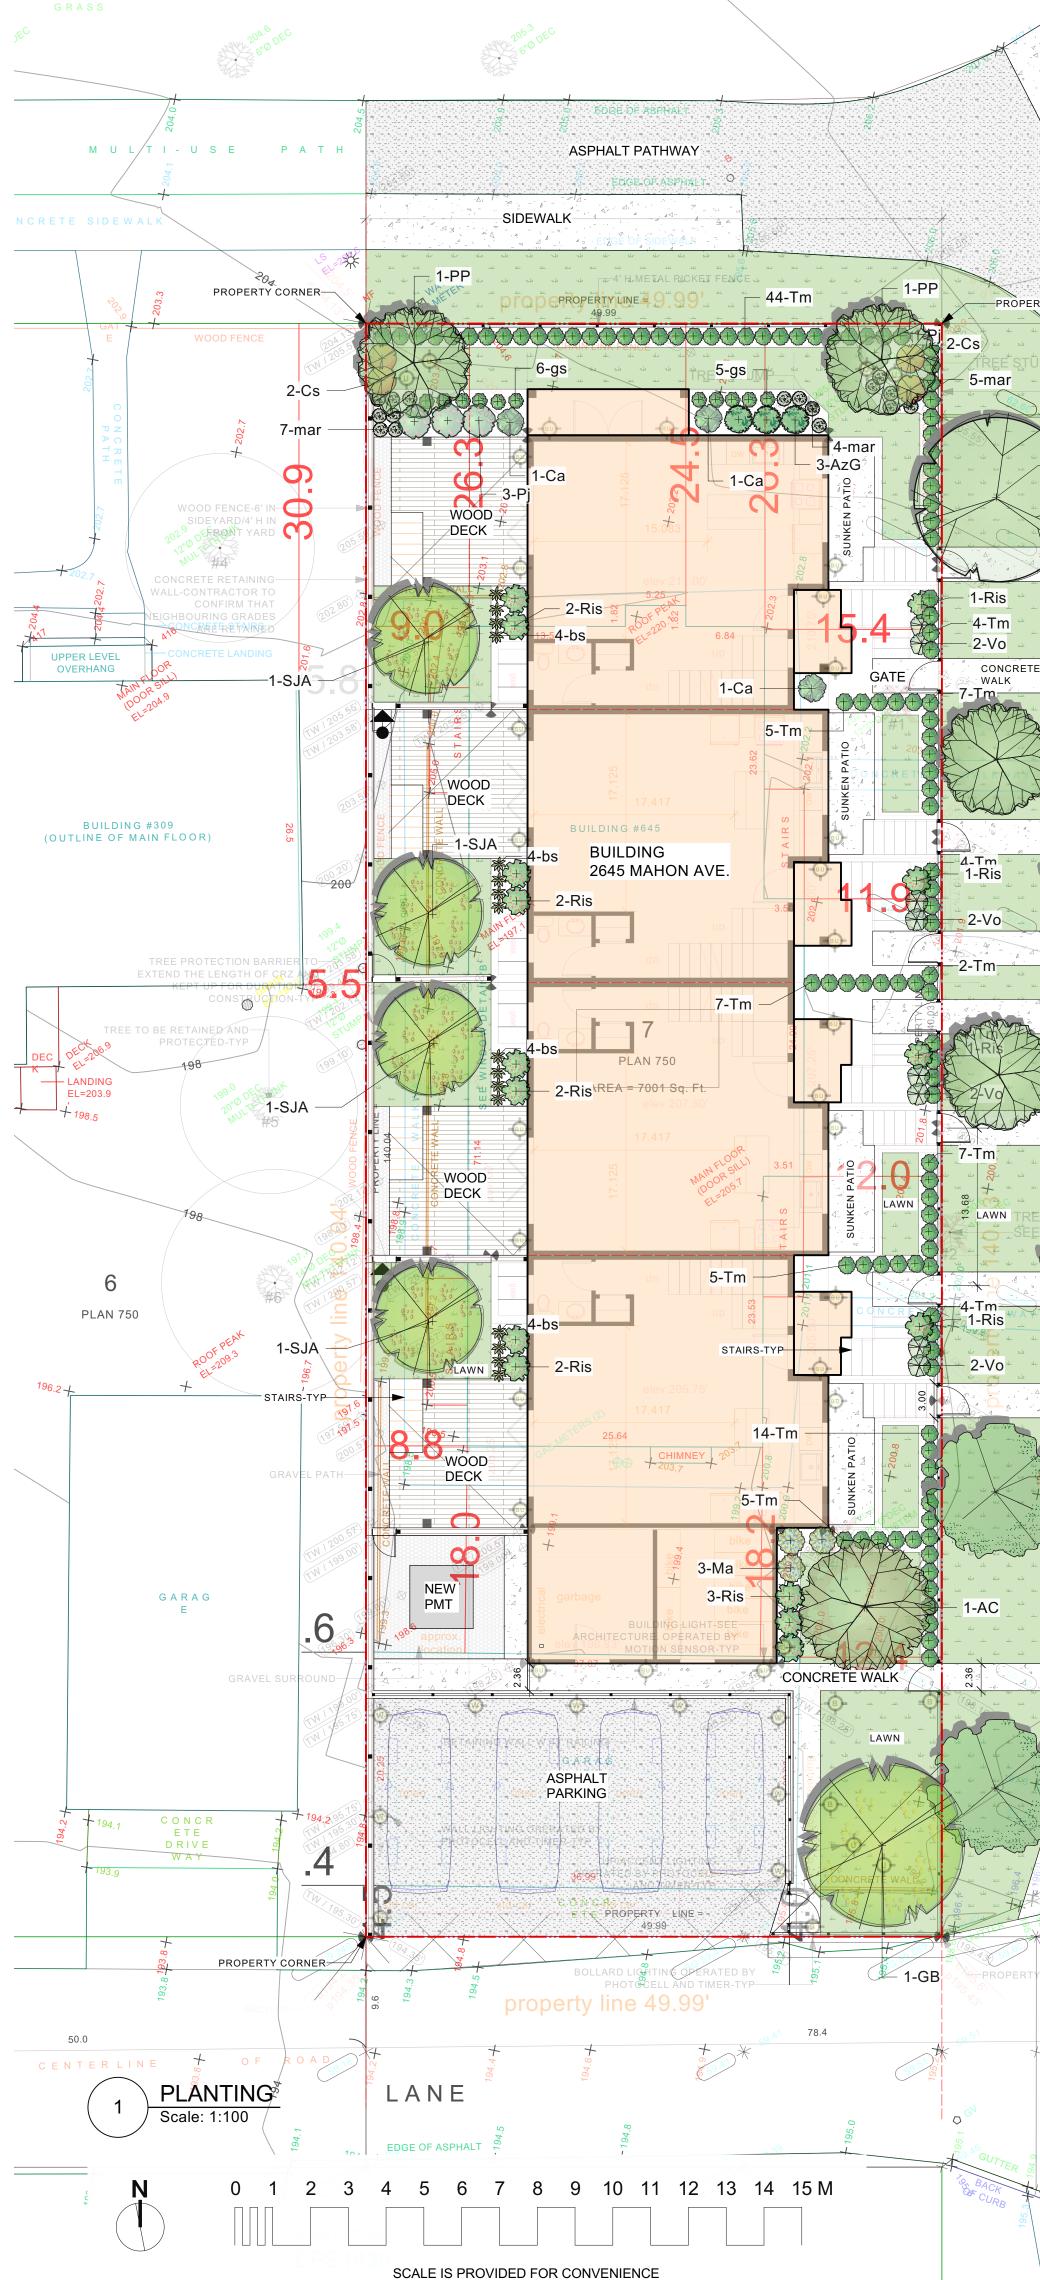

SCALE IS PROVIDED FOR CONVENIENCE DO NOT SCALE DRAWINGS FOR DIMENSIONS

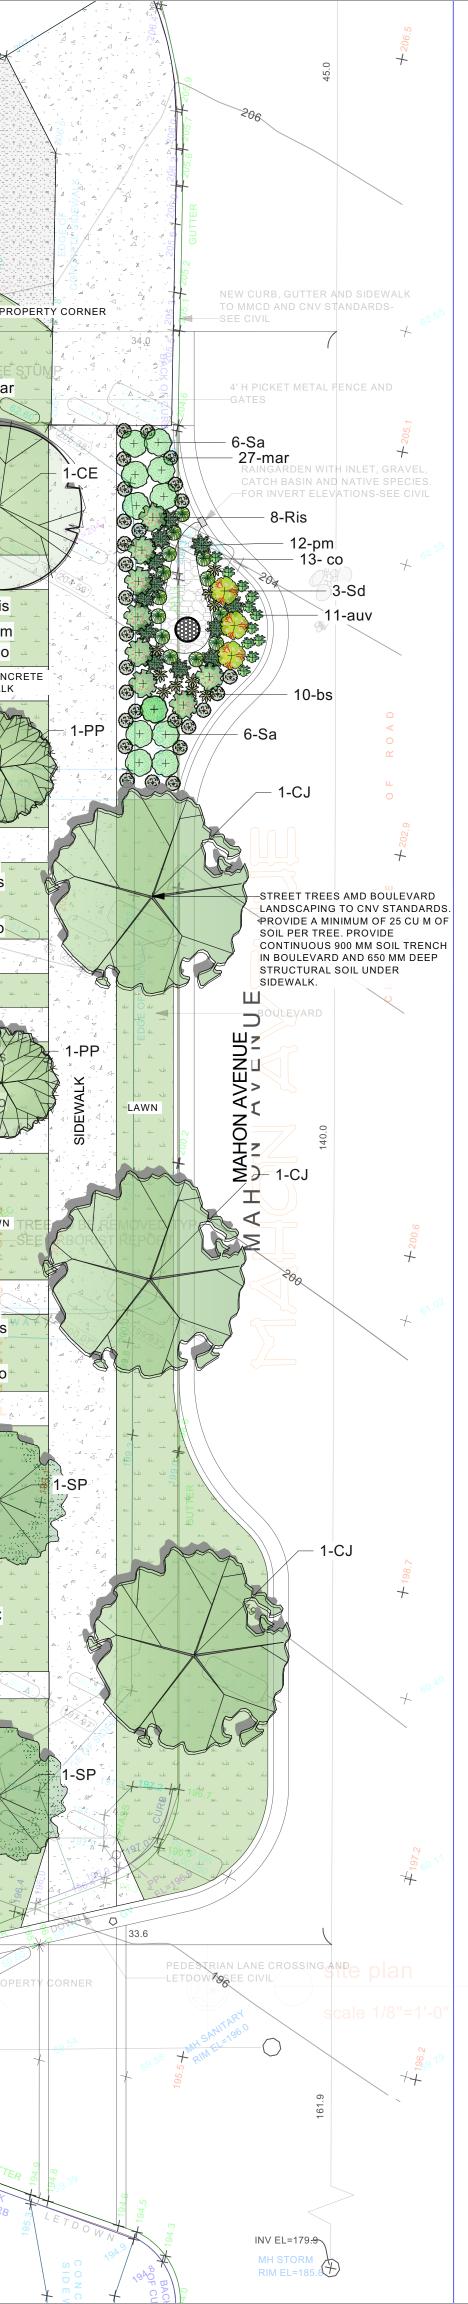

PLANT LIST 645 MAHON CNV

Botanical Name	Common Name	No.	Size	Spacing	Sym
TREES				+	
Acer circinatum	Vine maple	1	2.4 m	as shown	AC
Cercidiphyllum japonicum	Katsura tree	3	7 cm	as shown	CJ
Cornus 'Eddie's White Wonder'	Flowering dogwood	1	7 cm	as shown	CE
Ginkgo biloba 'Autumn Gold'	Ginkgo	1	7 cm	as shown	GB
Parrotia persica 'Spire'	Parrotia	4	7 cm	as shown	PP
Stewartia pseudocamellia	Stewartia	2	7 cm	as shown	SP
Styrax japonicus 'Snowcone'	Japanese snowbell	4	7 cm	as shown	SJ
SHRUBS		_	+		
		1	1	1	
Azalea 'Girard Fuchsia'	Azalea	3	#2 pot	as shown	AzG
Cornus alba 'Elegantissima'	Variegated dogwood	3	#2 pot	as shown	Ca
Cornus stolonifera	Redtwig dogwood	4	#2 pot	as shown	Cs
Mahonia aquiufolium	Oregon grape	3	#2 pot	as shown	Ma
Pieris japonica 'Mountain Fire'	Lily-of-the-valley shrub	4	#2 pot	as shown	Рj
Ribes sanguinium	Red flowering currant	23	#2 pot	as shown	Ris
Spiraea douglasii	Hardhack	3	#2 pot	as shown	
Symphoricarpus alba	Snowberry	12	#2 pot	as shown	
Taxus media 'Rising Star'	Yew	112	1.2 m	as shown	Tm
VINES, GROUND COVERS AND HERBAC	EOUS PERENNIALS				╂───
			1	<u>† </u>	
Arctostaphylos uva-ursi	Kinnickinnick	11	#1 pot	as shown	auv
Blechnum spicant	Deer fern	26	#1 pot	as shown	bs
Carex obnupta	Slough sedge	13	#1 pot	as shown	со
Gaultheria shallon	Salal	11	#1 pot	as shown	gs
Mahonia repens	Creeping oregon grape	43	#1 pot	as shown	mar
Polystichum munitum	Western sword fern	12	#1 pot	as shown	pm
Contractor to be certified by BCLNA					

All plants and installation to meet or exceed latest Canadian Landscape standard (CLS) #1 standards Contractor to verify numbers and placement of plants prior to installation

GENERAL LANDSCAPE NOTES

- 1. All landscape works are to meet the specifications and standards of the latest edition of the CANADIAN LANDSCAPE STANDARD, published by the Canadian Society of Landscape Architects and the Canadian Nursery landscape Association.
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- 4. No slopes to be steeper than 2.5 horizontal: 1 vertical.
- 5. All plant material and growing medium to meet Canadian Landscape Standard #1 specifications. Plant search area is to be any plant nursery within the Lower Mainland. Plant substitutions are only allowed if approved by Landscape Architect. Suggested plant substitutions shall be of similar species and of at least equal size to those originally specified.
- 6. All shrub beds to contain minimum 18" (450) mm depth of approved growing medium over scarified subgrade. All lawn areas to contain minimum 6" (150) mm of approved growing medium over scarified subgrade.
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Date	SW	Scale AS NOTED Sheet No. L-2
	SW PTEMBER 2023	Scale AS NOTED Sheet No.

LEGEND

EXISTING ELEVATION

PROPOSED ELEVATION

PROPOSED TOP OF WALL ELEVATION

PROPOSED BOTTOM OF WALL ELEVATION

⊕ (219.33') ⊕ (TW / 222.25') ⊕ (BW / 223.81')


PROPERTY LINE


AREA DRAIN

TRENCH DRAIN

ASPHALT
CONCRETE
FIBAR
SAND
STONEWORK
SLABS/TILES
WOOD DECK
GRAVEL

GRASS

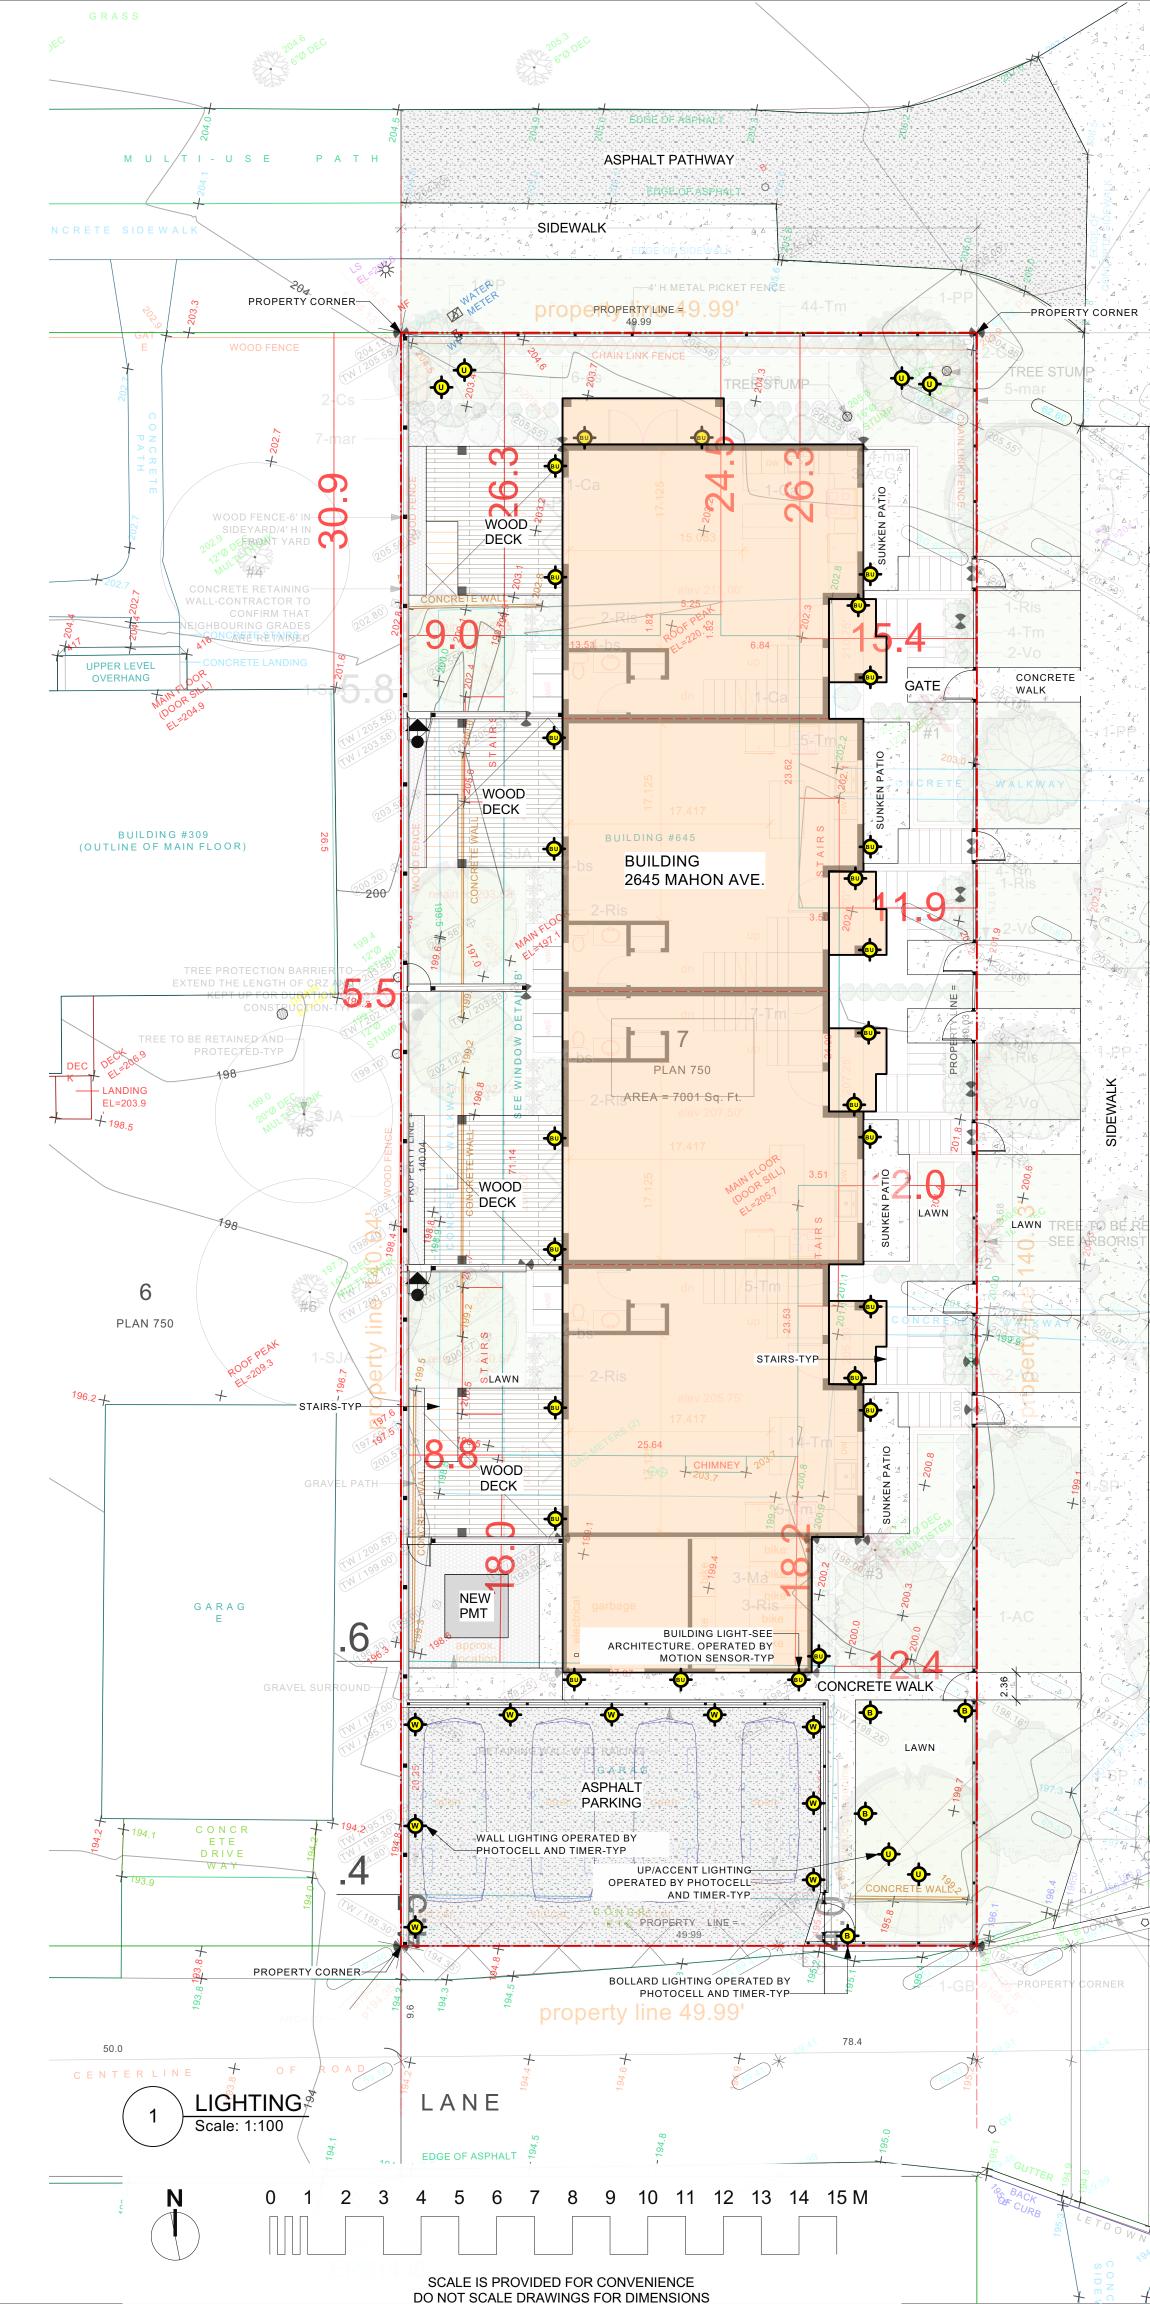

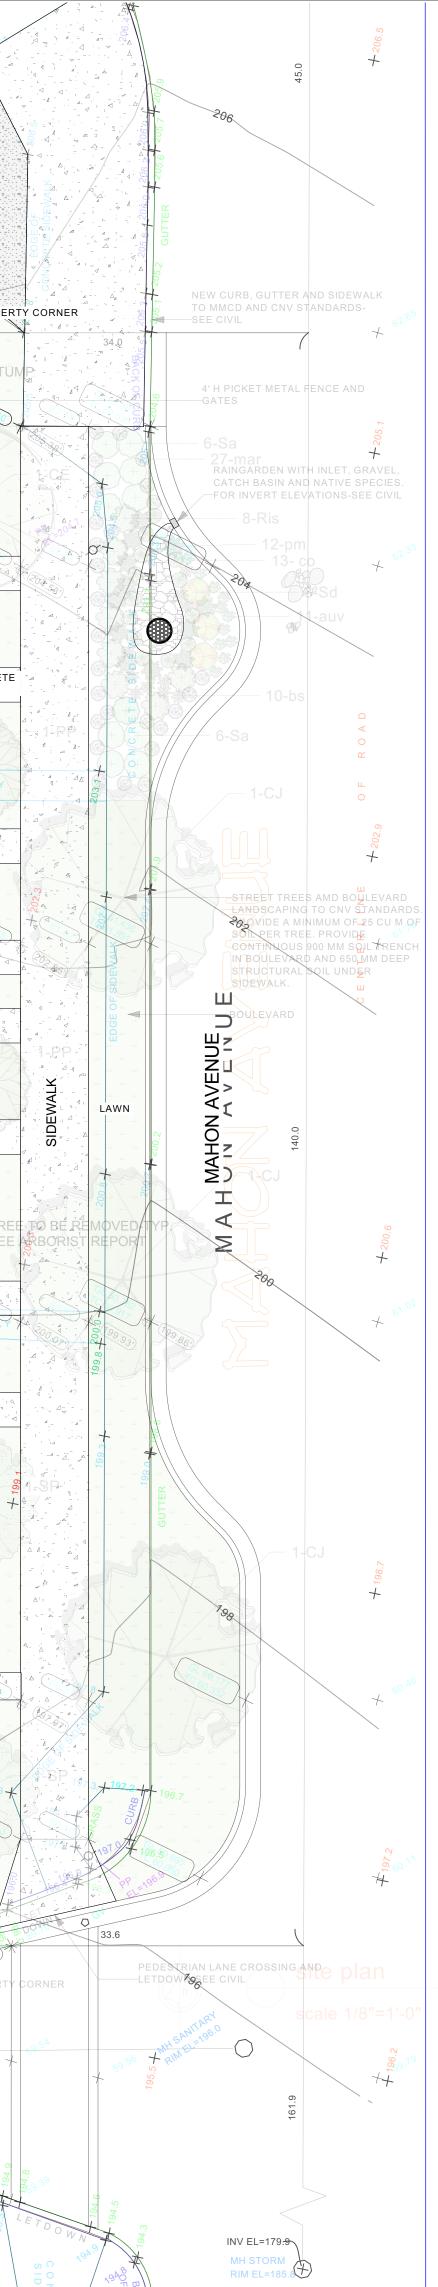











No.	Date	Issue/Revision Notes				
A	10/7/2023	FOR COORDINATION				
	10/1/2020					
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	sw landscape architect					
Design I	SW LANE	SCAPE ARCHITECT				
919		AVENUE, NORTH VANCOUVER				
	-	@gmail.com 778 834-8959				
OF	www.SWI	andscapearchitect.com				
Client	KSI	IECHANICAL LTD				
Project	Project Title					
	MULTIFAMILY DWELLING					
	2645 MAHON AVENUE, NV					
Sheet T	Sheet Title					
	Manager TEVE WONG	Project ID 2023-8				
Drawn E		Scale				
\vdash	311	AS NOTED Sheet No.				
Date		L-3				
SE	PTEMBER 2023	of				
CAD File 2645	e Name 5 MAHON NV.vwx	5				

LIGHTING LEGEND

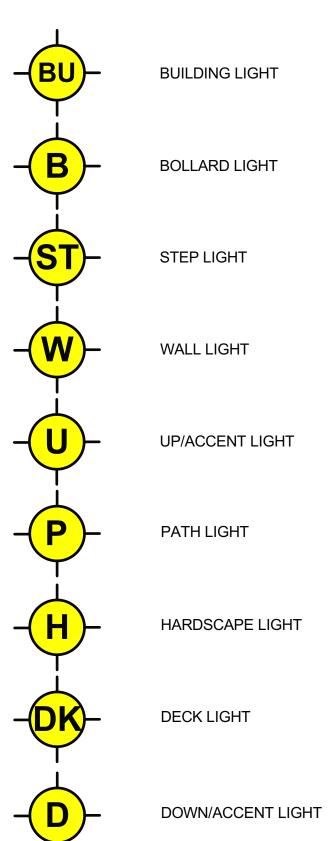

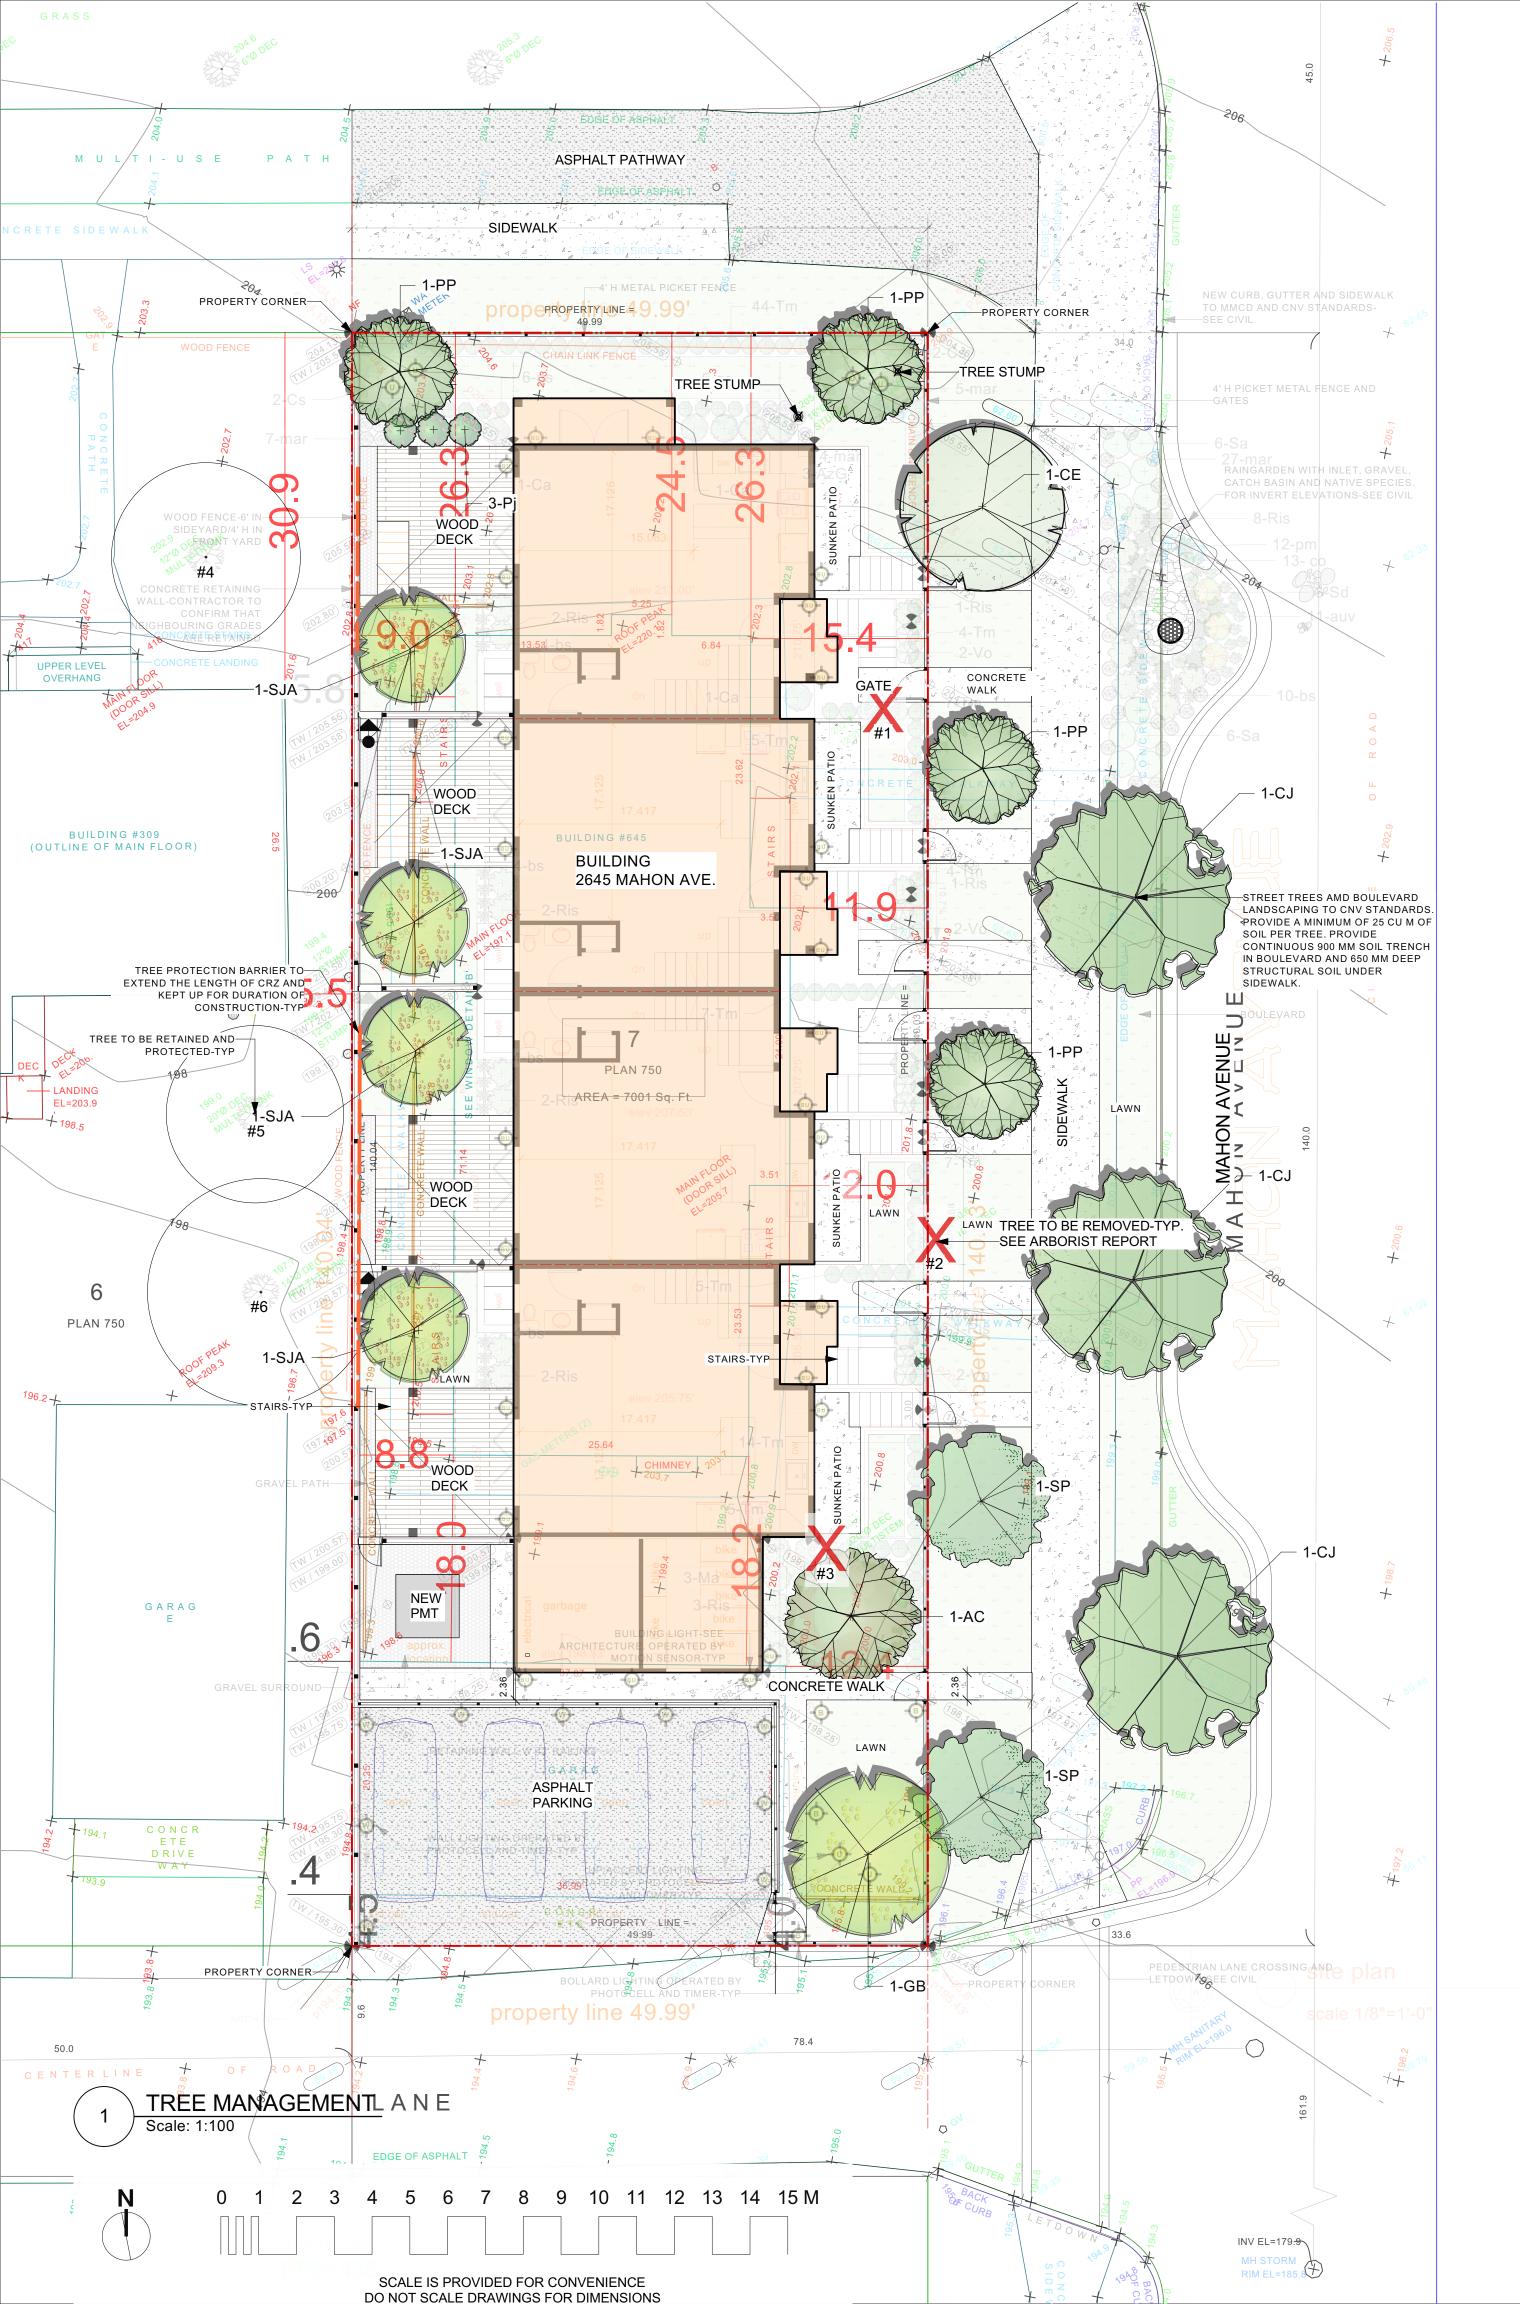

	6.0 TREE INVENTORY							
Tab	Table 1 - Tree Inventory							
-	Klimo & Associates Ltd.							
	rch 31, 2		Chievel Maria					
645	ivianon		f North Vancouve				(
#OI	Surveyed Y/N	On-site (ON) Off-site (OFF) City (C)	Common name	Botanical name	DBH (cm)	LCR (%)	Canopy (Dia. M)	Condition
T1	Yes	On-site	Dogwood	Cornus	25/22 /18	40	10	The overall growth of the subject tree was examined to have developed a multi stemmed structured base. The overall growth of the crown was observed to have a sweep towards the east. The main stems were observed to have been pruned in the past. Subject tree is in fair condition.
T2	Yes	Shared (<i>City</i>)	Hawthorn	Crataegus	25/28 /32	40	10	The overall growth of the subject tree was examined to have developed a multi stemmed structured base. The main stems were observed to have been pruned in the past. Sections of observable cavity was observed within its structure. Subject tree is in fair condition.
Т3	Yes	On-site	Common plum	Prunus domestica	20/23 /20	30	7	The overall growth of the subject tree was examined to have developed a multi stemmed structured base. The union was observed to be poorly structured with a deep union. The main stems were observed to have been pruned in the past Sections of deadwood was observed within its structure. Subject tree is in fair condition.
T4	Yes	Off-site	Common apple	Malus domestica	20	30	5	Mature fruiting tree. Subject tree was examined to have developed a multi stemmed structed overall growth form. The growth of the crown was observed to have a limited overall development. Observable deadwood and decay had been observed within its canopy. Subject tree is in fair condition.
Τ5	Yes	Off-site	Hawthorn	Crataegus	40/15	30	5	Subject tree was examined to have developed a multi stemmed structed overall growth form. The growth of the crown was observed to have a limited overall development. Observable deadwood and decay had been observed within its canopy. Subject tree is in fair condition.
Т6	Yes	Off-site	Magnolia	Magnolia	15/10 /5	30	6	Subject tree was examined to have developed a multi stemmed structed overall growth form. The growth of the crown was observed to be healthy and no major defects and or signs of stress were to be examined. Canopy was observed to have been maintained in the past. Subject tree is in fair to good condition.
	2 TREE TABLE FROM ARBORIST REPORT Scale: NTS							



Comments	Retention Suitability	Retain / Remove	TPZ (m)
Subject tree falls towards the edge of the proposed building footprint and will be within the zone of the heaviest construction & excavation related activities.	Marginal	Remove	3.9
Subject tree falls towards the edge of the proposed building footprint, boulevard & perimeter civil works, and will be within the zone of the heaviest construction & grading related activities. <i>The city's</i> <i>authorization will be required for its</i> <i>removal.</i>	Marginal	Remove	5.1
Subject tree falls towards the edge of the proposed building footprint and will be within the zone of the heaviest construction & excavation related activities.	Marginal	Remove	3.8
Place Tree Protection barriers to protect its trunk, roots, and structure. Arborist supervision will be required during the site clearing process, excavation process, placement of the perimeter pathway, and removal/replacement of the perimeter fence.	Marginal	Retain	1.2
Place Tree Protection barriers to protect its trunk, roots, and structure. Arborist supervision will be required during the site clearing process, excavation process, placement of the perimeter pathway, and removal/replacement of the perimeter fence.	Marginal	Retain	3.3
Place Tree Protection barriers to protect its trunk, roots, and structure. Arborist supervision will be required during the site clearing process, excavation process, placement of the perimeter pathway, and removal/replacement of the perimeter fence.	Suitable	Retain	1.8

ONSITE TREE SUMMARY

TREES REMOVED 3

TREES PL	ANTED	16
OFFSITE	(8)	
ONSITE	(8)	

REFER TO ARBORIST REPORT BY KLIMO AND ASSOCIATES, MARCH 31, 2023

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and Arc	at all times shall hitect, and canno	RVED: This drawing and design are, remain the property of SW Landscape of be used, reproduced or distributed onsent of SW Landscape Architect.	
	S		
	SW I	andscape architect	
Design F	Firm		
	SW LAN	DSCAPE ARCHITECT AVENUE, NORTH VANCOUVER	
stevewong234@gmail.com 778 834-8959 www.swlandscapearchitect.com			
Client KS MECHANICAL LTD			
Project Title MULTIFAMILY DWELLING 2645 MAHON AVENUE, NV			
Sheet Ti		E MANAGEMENT	
Project I	Manager TEVE WONG	Project ID 2023-8	
Drawn B		Scale AS NOTED	
		Sheet No.	
Date SEI	PTEMBER 2023	L-4	
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LEGEND

EXISTING ELEVATION

⊕ (TW / 222.25')

⊕ (219.33')

PROPOSED ELEVATION

🕀 (BW / 223.81')

PROPOSED TOP OF WALL ELEVATION PROPOSED BOTTOM OF WALL ELEVATION




PROPERTY LINE



AREA DRAIN

TRENCH DRAIN

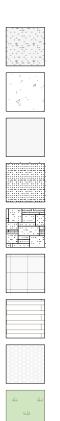

ASPHALT

CONCRETE

FIBAR

SAND


STONEWORK


SLABS/TILES


WOOD DECK

GRAVEL


GRASS

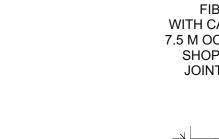

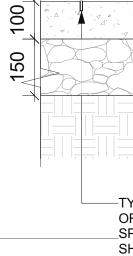


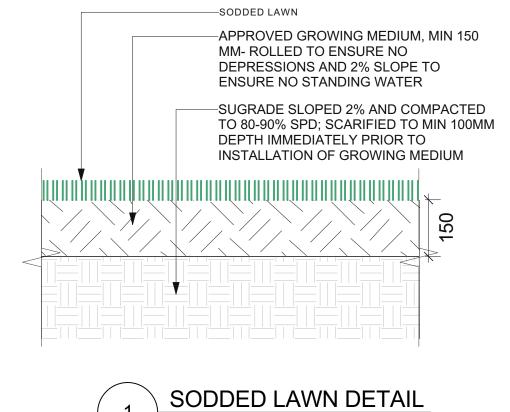


Scale: 1:10

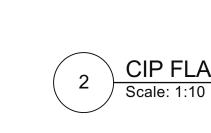

MINIMUM SETBACK FROM— ADJACENT WALKWAYS

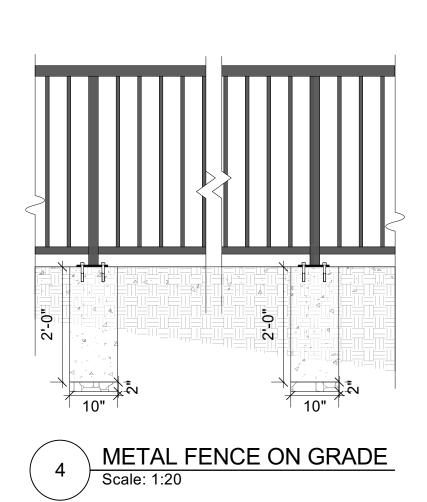


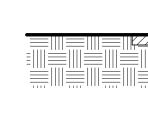

SCHEDULE A - TREE F
TREE PROTECTIO
TRUNK DIAMETER

CM	FT
20	0.6
25	0.8
35	1.0
40	1.2
45	1.3
50	1.5
55	1.7
60	2.0
75	2.5
90	3.0
100	3.3




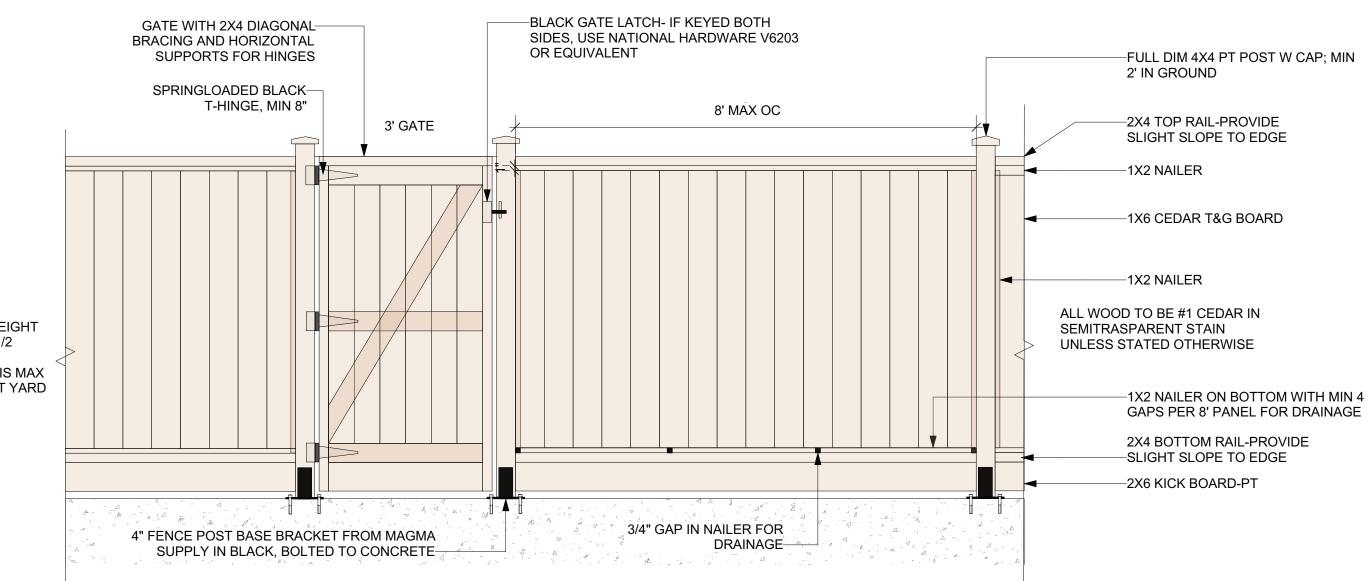

ADJUST FENCE HEIGHT SO FENCE PLUS 1/2 WALL HEIGHT IN SIDE/BACK YARD IS MAX 6' AND 4' IN FRONT YARD



WOOD FENCE ON WALL Scale: 1:20

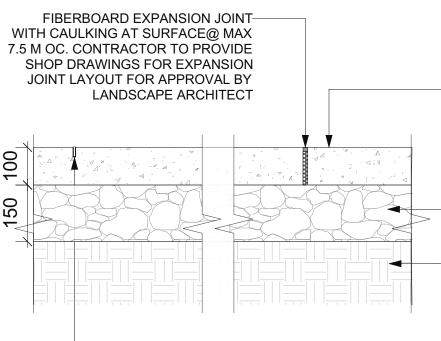

-CAST IN PLACE CONCRETE ON 150 MM OF 19MM MINUS BASE COMPACTED TO 95% MPD; MEDIUM BROOM FINISH


19MM MINUS BASE -COMPACTED TO 95% MPD

SUBGRADE COMPACTED TO —95% MPD

-TYPICAL CONTROL JOINT- 25 MM DEEP OR 1/4 CONCRETE DEPTH@ 1.5 M MIN _____SPACING; CONTRACTOR TO PROVIDE SHOP DRAWINGS FOR CONTROL JOINT

LAYOUT

CIP FLATWORK

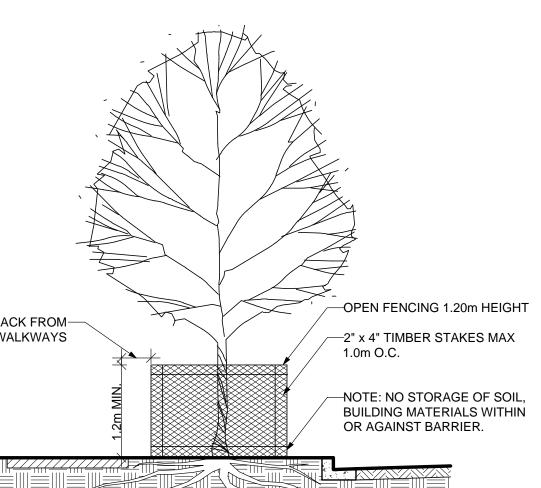


ROTECTION BARRIER				
I DISTANCE TABLE				
MINIMUM DISTANCE FROM TRUNK (METERS)				
1.2				
1.5				
2.1				
2.4				
2.7				
3.0				
3.3				
3.6				
4.5				
5.0				
6.0				

NOTE: TREE PROTECTION BARRIERS MUST BE AT LEAST 1.20m IN HEIGHT AND CONSTRUCTED OF EITHER SNOW FENCING SECURELY FASTENED TO 2x4 TIMBER STAKES, OR METAL STAKES SPACED NO FURTHER THAN 1.00m APART.

TREE PROTECTION BARRIER

NOTES:

1. SHRUB TO BE PLANTED WITH ELEVATION OF TOP OF ROOTBALL OR POT LEVEL WITH FINISH GRADE OF GROWING MEDIUM. 2. COMPOSTED BARK MULCH AT 50mm DEPTH TO BE KEPT AT LEAST 50mm AWAY FROM STEMS OF SHRUB. 3. PLANTING PIT MUST BE FREE DRAINING

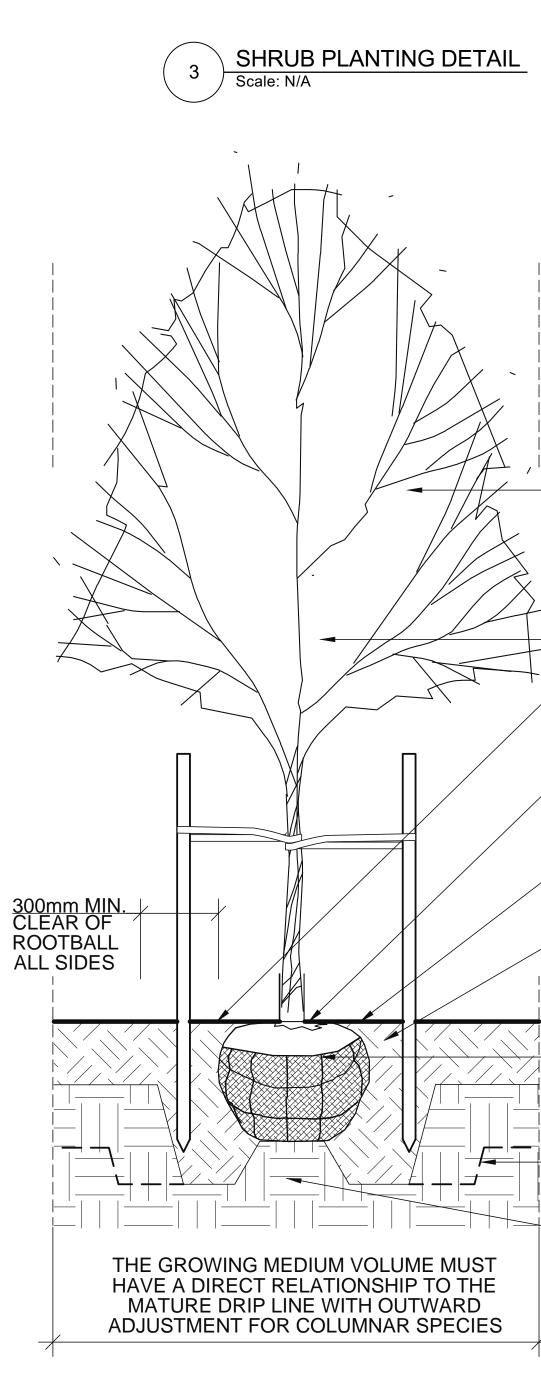



	-REMOVE BURLAP AND ROPE FROM AROUND BASE OF SHRUB REMOVE ALL 'ORGANIC' POTS PRIOR TO PLANTING
V	-FINISH GRADE
<u> </u>	MULCH
, `` / /	-450mm GROWING MEDIUM
/ \ / \ 	-COMPACTED SUBGRADE

SCARIFY SURFACE PRIOR TO PLACEMENT OF SHRUB SLOPE SURFACE TO DRAIN AWAY FROM ROOTBALL

	No.	Date	Issue/Revision Notes
	Α	10/7/2023	FOR COORDINATION
SET TREE PLUM. STAKE TREE WITH TWO			
VERTICAL 50mm X 50mm PRESSURE TREATED			
STAKES 1500mm LONG; PLACE 1/3RD OF THE			
STAKE BELOW GRADE. STAKES TO BE POSITIONED PARALLEL TO STREET FOR STREET TREES OR TO			
PREVAILING WIND. STAKES NOT TO PENETRATE			
OR DAMAGE ROOT BALL			RVED: This drawing and design are, remain the property of SW Landscape
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CREATE A 50mm DEEP WELL IN GROWING MEDIUM	with		nsent of SW Landscape Architect.
FOR THE FIRST YEAR OF WATERING. ENSURE		1000	
WELL IS A CLEAN-EDGED CIRCLE WITH A DIA. OF			
1500mm		<u> </u>	V V LL/M
TOP OF THE ROOTBALL TO BE FLUSH WITH SURROUNDING GRADE. FINISHED GRADE OF		sw	andscape architect
PLANTING TO BE EQUIVALENT TO NURSERY			
GROWN GRADE OF TREE			
PLACE 50mm DEPTH OF MULCH OVER THE			
PLANTING WELL. KEEP MULCH BACK FROM TRUNK A MINIMUM DISTANCE OF 100mm			
PLANTING HOLE SHALL BE MINIMUM DEPTH OF ROOTBALL. PLANTING HOLE EDGE TO BE A			
SHALLOW ANGLE. SCARIFY SIDES AND BOTTOM			
OF TREE PIT PRIOR TO PLANTING.			
	Design F	SW LAN	DSCAPE ARCHITECT
REMOVE COMPLETELY THE TOP 1/3 OF THE WIRE	919 MELBOURNE AVENUE, NORTH VANCOUVER		
BASKET, BURLAP, AND ALL NYLON AND BINDING		•	4@gmail.com 778 834-8959 landscapearchitect.com
MATERIAL. CUT OFF WIRE BASKET AND BURLAP, DO NOT FOLD THEM INTO THE HOLE PRIOR TO		www.sw	landscapearchitect.com
BACKFILLING	Client KS MECHANICAL LTD		
SOIL DEPTH MAY VARY TO ACCOMMODATE			
REQUIRED VOLUME WITHIN 900mm MAXIMUM DEPTH.	Project 1	ītle	
ENSURE A MIN. 300mm DEPTH OF		MULTI	FAMILY DWELLING
COMPACTED SUBGRADE UNDERNEATH		2645 M	AHON AVENUE, NV
ROOTBALL TO PREVENT SETTLING OF			
TREE	Sheet Ti	tle	DETAILS
			DETAILS
	Project M	^{//anager} TEVE WONG	Project ID 2023-8
	Drawn B	sw	Scale AS NOTED
			Sheet No.
	Date		- L-5
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