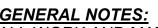
P.I.D: 014-872-641 (EXISTING LOT 12)

ISSUED FOR RS-2 REZONING APPLICATION MAY 15, 2024

DRAWING LIST

Number	Sheet Name	Current Revision	Current Revision Date
A01	COVER PAGE	2	2024-05-15
A02	CONTEXT PLAN	2	2024-05-15
A03	ACCESSIBILITY ANALYSIS	2	2024-05-15
A04	SITE PLAN	2	2024-05-15
A05	SITE PLAN ENLARGE GRADE	1	2024-05-15
A06	SITE PLAN - LOT COVERAGE	1	2024-05-15
A07	BLDG.A- ACCESSORY BUILDING	2	2024-05-15
A08	BLDG.B- ACCESSORY BUILDING	2	2024-05-15
A09	BLDG.A & B- BASEMENT FLOOR PLAN	2	2024-05-15
A10	BLDG.A&B LEVEL 1 FLOOR PLAN	2	2024-05-15
A11	BLDG.A&B-LEVEL 2 FLOOR PLAN	2	2024-05-15
A12	BLDG.A&B- ROOF PLAN	2	2024-05-15
A13	AREA OVERLAY BASEMENT & FIRST FLOOR	2	2024-05-15
A14	AREA OVERLAY SECOND FLOOR	2	2024-05-15
A15	AREA OVERLAY ACCESSORY BUILDING	1	2024-05-15
A16	BLDG.A&B SOUTH AND NORTH ELEVATIONS	2	2024-05-15
A17	BLDG.A- EAST & WEST ELEVATIONS	2	2024-05-15
A18	BLDG.B EAST AND WEST ELEVATIONS	2	2024-05-15
A19	BLDG-B SECTIONS	2	2024-05-15
A20	BLDG- A SECTIONS	2	2024-05-15



ALL WORK AND MATERIAL SHALL COMPLY WITH 2018 EDITION OF THE BRITISH COLUMBIA BUILDING CODE.

Unless otherwise noted in drawings, all dimensions in this et to read as

To face of the stud for the interior walls.

 To face of the exterior plywood on the exterior walls. To face of the concrete walls.

• Exterior face of the plywood to be on the gridline.

Face of the foundation below to be aligned with face of the exterior

EXCAVATIONS

1. GEOTECHNICAL Engineer is to certify a site is safe for workers when the slope of the excavations exceeds 3/4 horizontal to one vertical or

excavation exceeds 48". 2. Inspections can only be done if site is posted as safe by Professional Engineer.

1. Exterior Strip footings are required to have a minimum width of 10" supporting 1 floor, 14" supporting 2 floors, & 18" supporting 3 floors.

Refer to structural. 2. Interior Strip footings are required to have a minimum width of 8" supporting 1 floor, 14" supporting 2 floors, & 20" supporting 3 floors.

3. Footings are to extend 18" below grade minimum. 4. Foundation walls of basement below grade and crawl spaces must be

insulated with R12 to 24" below grade.

5. Provide anchor bolts per structural drawings. 6. Anchor posts to footings to resist uplift.

vaulted roofs in order to maintain airflow.

See BCBC 2012 Div. B Part 9 Sentence 9.19. 1. 2.

1. Provide crawl space access of 2'-0" x 3'-0", min. 18" clearance and ventilate to 1/500th of area. 2. 2" concrete over 6 mil U.V. rated poly required.

1. Unobstructed vent area shall be not less than 1/300 of the insulated ceiling area. The vent area shall be not less than 1/150 of the insulated ceiling area, where the roof slope is less than 1 in 6. Venting is required

2. Min. 2x2 cross-purlins to flat, vaulted ceilings, and decks over living areas to conform to BCBC 9.19.2.4) 3. Provide min. 2 1/2" clearance between roof sheathing and insulation #9.19.1.3.1) Provide min. 1" clearance between insulation and top of

4. Roof vents must be uniformly distributed with a minimum of 25% at base and 25% at the rooftop.

5. Provide attic access hatch of 2'-0" x 3'-0". 6. Attic hatches shall be weather stripped to maintain continuity of the air barrier. See BCBC 2012 9.19.2. & 9.25.3.3. & 9.36.2.21. 7. Submit Mechanical Ventilation/Air Conditioning design and letter of supervision by Professional Engineer, certified HRV or HVAC Technician at frame and final inspection.

8. Continuous or intermittent exhaust fans are required to all bathrooms and kitchens as per BCBC 9.32.3.3. 9. • It is recommended that high-density batt insulation be used in

INSULATION REQUIREMENTS.

(Prescriptive path, effective values) 1. Insulation where subject to mechanical damage is to be covered as per #9.25.2.3.(7) with drywall or equivalent (e.g. Furring wall). 2. Minimum insulation values R15.8 walls, R26.5 for flat or vaulted ceilings, and R39.2 for attic spaces, R-11.3 foundation, R26.5 Floor over exterior space, R-25,6 floor over unheated space, R-14.4 Wall to unheated space, R11.1 Slab above frost line, R-13.2 Slab below

3. provide a thermal break at slab edge. 4. Provide insulation in a 4' perimeter under the slab with a thermal

break at exterior walls. 5. Provide insulation under entire slab area and a thermal break at the exterior walls for slabs with radiant heating. 6-Refere to energy modeling summary sheet when building energy

compliant with performance path. 7. Piping for any plumbing & mechanical systems must be located within the thermal enclosure or are fully insulated to the required RSI value of the assembly they are in.

8. Foundation Wall insulation to wrap to edge of window/ framing on sides and bottom of well windows and doors

1. Straight stair: Rise min. 5" max. 7.87"

Run min. 8.25" max. 14" 2. Maximum 1" nosing on stair treads. 3. Minimum headroom is 6'-5" from a line through nosings,

measured vertically. 4. Handrail to be between 32" to 38" from a line, measured vertically, through nosing. 5. Winders to conform to 9.8.4.5.

6. Primary stair minimum width 2'-10". 7. Stairs 43" in width or greater require 2 handrails. 8. Handrail reqd. on interior stairs with three or more risers.

Exterior stairs with four or more risers. 9. Handrail as a guard is to be minimum 36"- 38"high.

1mm above tread surface) CHIMNEY & FIREPLACES

1. Provide minimum 2" clearance between chimney and combustible 2. Provide minimum 4" clearance between fireplace and combustible

3. Masonry fireplace hearths must conform to 9.22.5.1.

shall be slip-resistant, or be provided with slip-resistant strips (max.

walking surface has a slope of more than 1 in 2.

1. Contractor to double check provided window sizes with floor plan fabrication. 2. Except wired glass windows, all Windows, Doors, Skylights and Other

North American Fenestration Standard/Specification for Windows, Doors, and Skylights. 3. Glass in entrance, shower and sliding doors, and windows within 8" of

Sidelights 20"+ in width are to be safety glass. 5. Windows in walls enclosing shower or tubs are to be safety glass and be located above the waterproof wall finish height. 6. The bottom of an operable window in a bedroom is not to exceed 4'11" above the floor, and have a min. opening width of 15" with an area of 3.75sf, unless the house is sprinklered

above the surface shall be protected with guards or be non-operable and designed to #4.1.5.15.

9. Level 2 Bedroom windows as egress must have unobstructed opening of not less than 1 m in height and 0.55 m in width, and sill height not more than 1.076 m above finish floor, and 7 m above adjacent round 10. A bedroom window as egress must have unobstructed opening of

maintain the required opening during an emergency without the need for additional support.

MASONRY VENEER WALLS

2. interior Guards: min 900mm (36") high; 3. Exterior guards: min 900mm (36") high where the vertical distance to finished grade is

max 1800mm (6 ft.) 4. Handrails: Min 865mm and no more than 965mm high, measured vertically from

1. Guardrails to be a minimum 42" exterior and 36" interior height.

the top of the handrail to a straight line drawn tangent to the tread nosings of the stairs. (See BCBC 9.8.7.4.) 5. Openings in guards shall be small enough to prevent the passage of a 100mm (4") dia. sphere (See BCBC 9.8.8.5.);

6.Guards must not facilitate climbing (See BCBC 9.8.8.6.(2) for further 7. Every stair requires a handrail, except interior stairs with max. 2 risers,

or exterior stairs with max. 3 risers See BCBC 2012 Div. B Part 9. 9.8.7. 8. All glass guards to have top cap unless approved by Prof. Engineer. 9. A minimum of 36" in height is permitted for decks within 5'-11" of

10. Guard required to all drops exceeding 24" where access is provided 11. Guard required where the adjacent surface within 1.2 m of the

dimensions, window sill and head levels in elevation & sections prior

Glazed Products shall comply with WDMA/CSA101/I.S.2/A440, "NAFS – floors and within 36" of deadbolts are all to be safety glass.

7. Windows over stairs, ramps and landings that extend to less than 36"

8. Window wells are to be 30" minimum width when required as a bedroom egress 9.9.10.1

not less than 0.35 m² in area with no dimension less than 380 mm, and

11. Where a protective enclosure is installed over a window well, it shall be operable from the inside without the use of keys, tools, or special 12. Window sill that extends to less than 1 m from the floor and is

located at the second must be protected by guard.

1. Provide masonry/veneer wall flashing ties and weep holes as per

1. Doors between garage and dwelling are to be a self-closing and weather-stripped solid core door with 30 min. FRR. 2. Thicken slab edge at garage entry to 18" below grade.

MOISTURE PROTECTION 1. Provide flashing between horizontal intersections of differing wall finishes. All flashing to slope away from the building a minimum of 6%. 2. Provide flashing at all wall-roof junctions, including parapets for solid

3. Rainscreen assembly required for all buildings, with a minimum capillary break of 3/4".

4. All platforms are roofs 5. All roofs must slope 1 in 50 away from walls, this includes parapet walls surrounding decks 6. Extend roof membrane 6" up wall at deck floor.

5. 5/8" Drywall required to ceiling members at 24" o.c.

1. Cross bridging required @ 7'- 0" o.c. maximum for floor and roof joists. 4. For all tiled floor, install an additional layer of 3/8" exterior grade plywood on top of subfloor if concrete topping not provided.

6. Provide minimum 8" clearance between grade and siding. 7. Damp-proofing slabs, including crawl spaces, are to be 6 mil "UV" poly. 8. Furnace and laundry room door width of 2'-8" min 9. N.R.P. hinges required for outswing exterior doors. 10. Hardwired and interconnected smoke alarms required on every floor level differing by 36", within 5 meters of bedroom doors, and within 15

11. Hard wired **CARBON MONOXIDE** alarms must be installed within each bedroom or within 15' of each bedroom door. BCBC 9.32.4.2

12. A 5lb A.B.C. dry chemical fire extinguisher is required near the 13. Heating and air conditioning equipment must be secured to the building to resist overturning and displacement. 14. Solid Blocking shall be provided at exterior doors serving the dwelling unit and dwelling unit to garage doors Locate blocking at lock height between jamb and structural framing. 15. Factory-Built Fireplaces and their installation shall conform to

Waterproof Wall Finish: shall be provided as follows:

4. For all tiled wall surfaces. Provide water resistant GWB

accordance with manufacturers specifications

"AQUABOARD" or approved equivalent.

1. Above the floor in shower stalls: min 1,8m (6 ft.) 2. Above the rims of bathtubs equipped w/ showers- min 1.2m (4 ft.) 3. Above the rims of bathtubs not equipped with showers: min 400mm (16") See BCBC 2012 Div. B Part 9 Sentence 9.29.2.

CAN/ULC-S640-M, "Factory-Built Fireplaces" and be installed in

Solar Hot Water Ready: All new single family homes must comply with the provincial regulations as follows: 1. 2x2" (inside diameter) straight, continuous, conduit runs must be provided from the mechanical room to the attic or roof, be

capped/sealed at both ends and identified by markings that are 2. 2 -3/4" type L copper pipes with 1/2" insulation that must be tested

200 psi after installation. 3. 1 -1" electrical conduit raceway close to the 2" pipes. 4. Pipes must be ended in a workable and accessible area, ie., minimum 2' clearance from top of ceiling joist to underside of rafters.

5. One 9.3 m² (100 sq.ft.) of south facing roof, minimum of 2.7m (9 ft 6. Structural roof design of a load of 0.2kPa in addition to design loads

Principal Ventilation System Supply Air:

1. A principal ventilation system shall mechanically provide air to each bedroom and each floor without a bedroom. See BCBC 2012 Div. B Part9 Section 9.32.3.4. 2. HVAC equipment must be located within the thermal enclosure or designated to be installed outside the thermal enclosure.

Principal Ventilation System Exhaust Fan:

A principal system exhaust fan shall run continuously and provide a minimum airflow rate specified in Table 9.32.3.5. An exhaust fan shall be provided for every kitchen and bathroom. See BCBC 2012 Div. B Part 9 Section 9.32.3.5. & 9.32.3.6.

Water Conservation Plumbing Regulations: shall be provided as follows: Ultra low-flow toilets (4.8 L) Maximum flow rates of 8.3L/min for kitchen and lavatory faucets

See BCBC 2012 - Part 10. 10.3.1.1. & 10.3.1.2

Combustion Spillage Hazard

Maximum flow rates of 9.5L/min for shower heads

A large kitchen hood fan can upset the pressure balance in a house, resulting in carbon monoxide spillage from a fireplace, hot water tank or furnace, back into the house. Ensure that the kitchen fan output (CFM) does not exceed 'Box B' as indicated on the Mechanical Ventilation Checklist

Important Considerations for Secondary Suite Fire Separation

The fire separation consists of:

 Drywall supported on the ceiling; and • Wall framing protected between a layer of drywall on both sides. AVOID penetrating this drywall with holes larger than 5" diameter or 5" x 5" AVOID locating bathtubs, showers, furnace room equipment, electrical

the fire separation wall. Bathroom fans must be housed in a 5-sided, tightly fitted, drywall box.

panels, washer shut off boxes and back-to-back outlets, in or adjacent to,



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DRAWING TITLE

COVER PAGE

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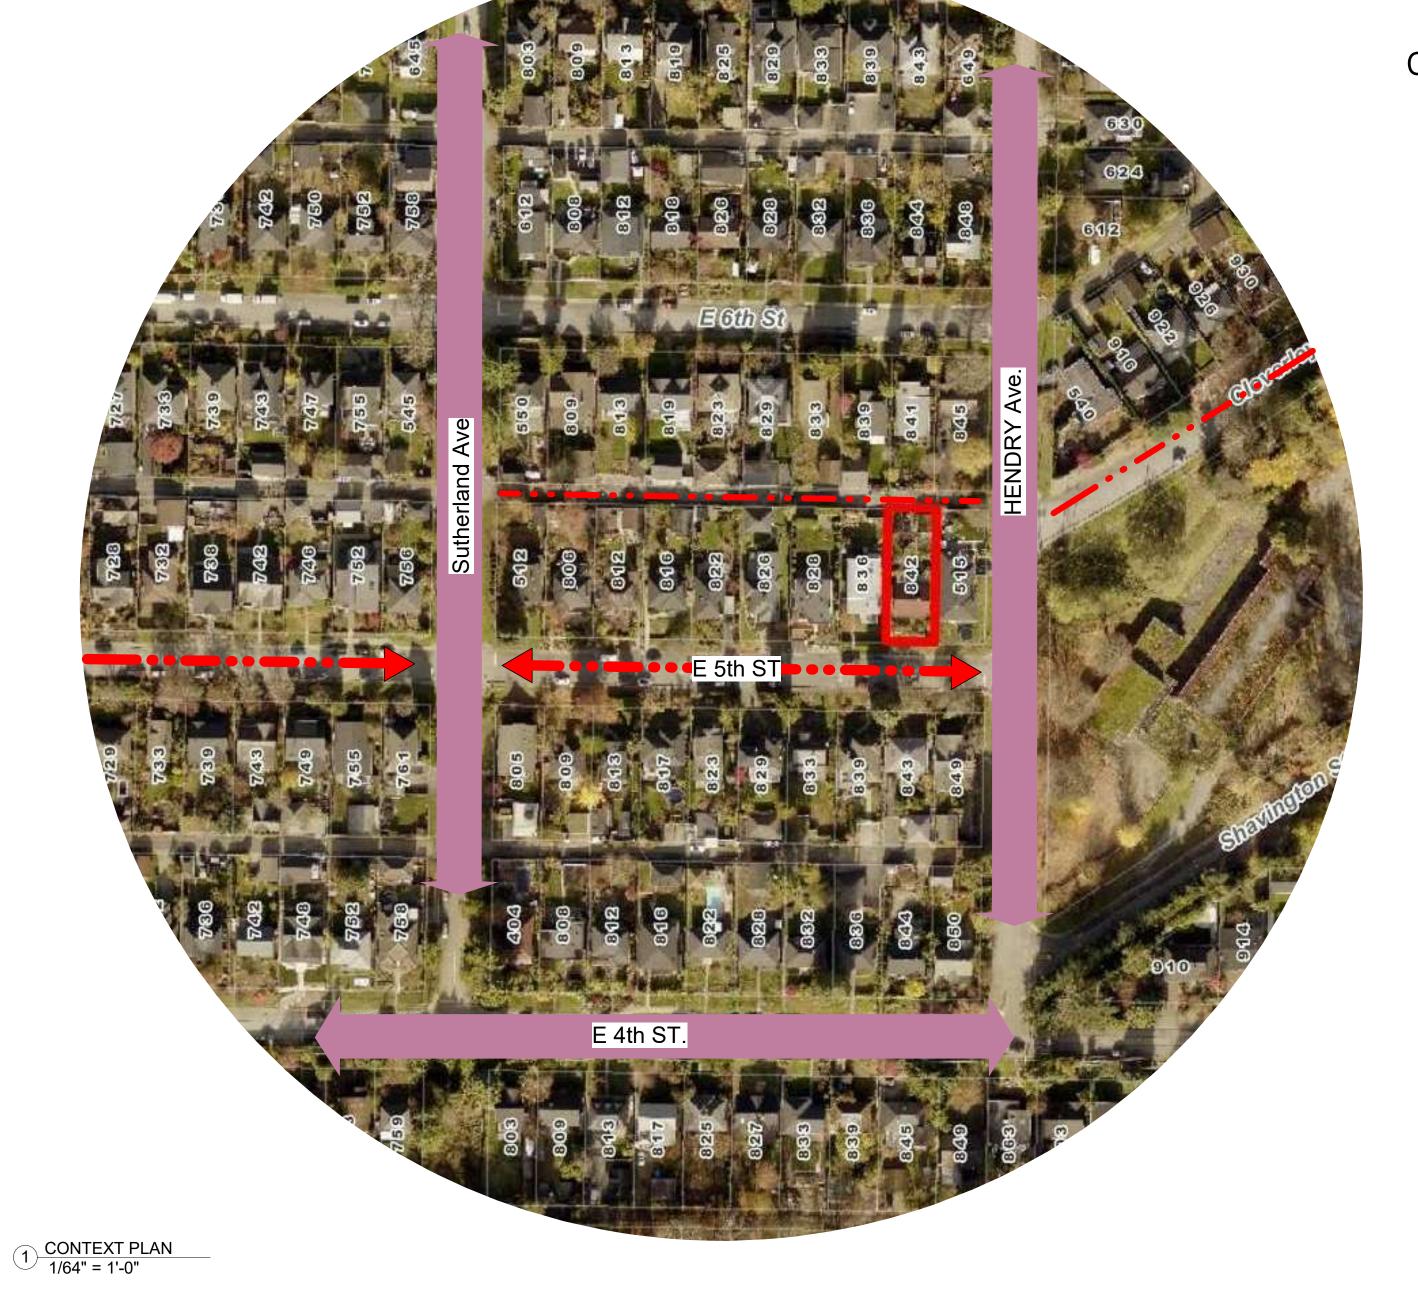
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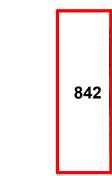
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SCALE

REVIEWED



CONTEXT PLAN LEGEND



Subject Project 50' x 136.59'



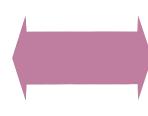
Lane Access



E 5TH ST



HENDRY AVE



SUTHERLAND AVE



SOUTH WEST LANE VIEW



SOUTH EAST LANE VIEW



NORTH EAST 5TH VIEW





ZONING LEGEND



SUBJECT PROJECT



DEVELOPMENT PERMIT -COACH HOUSE

RS1- RS2 REZONING



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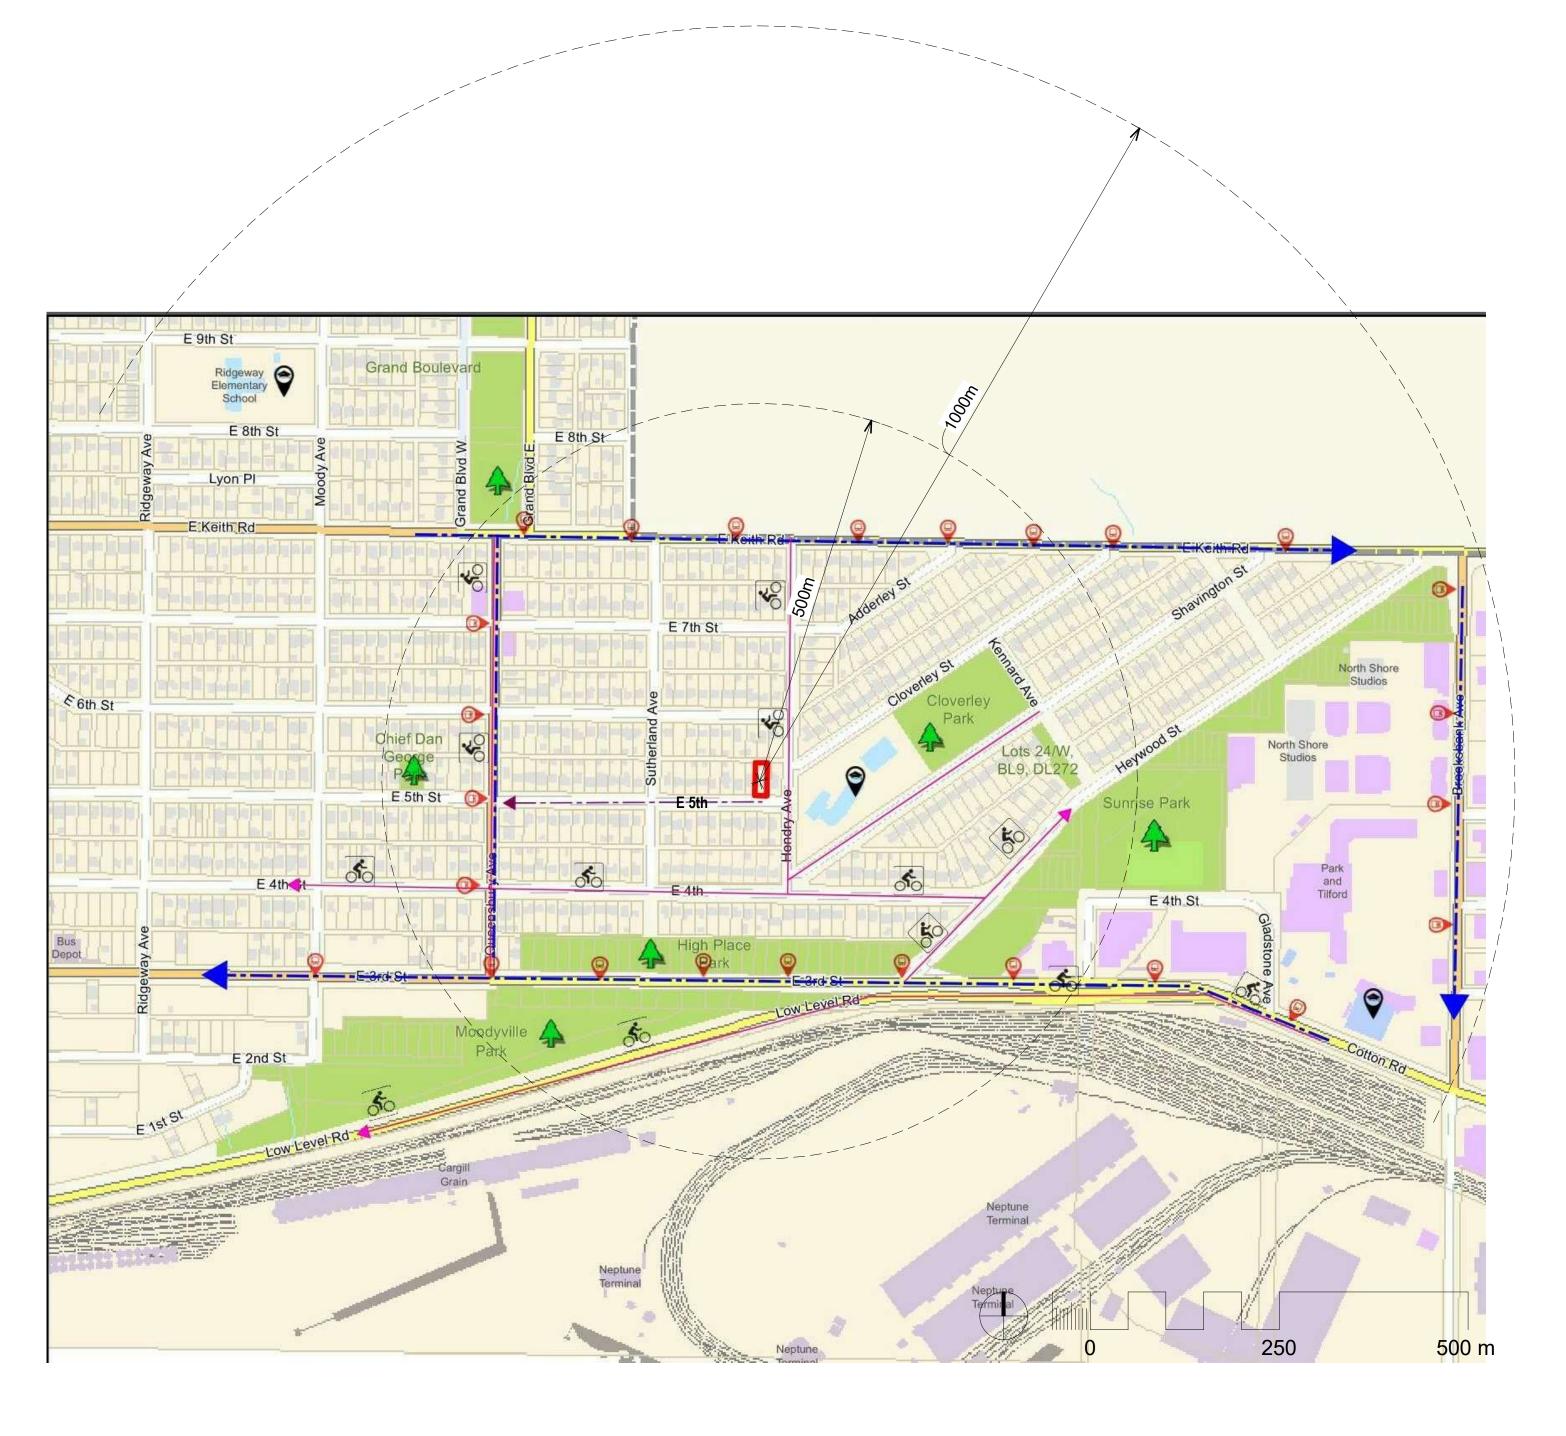
CONTEXT PLAN

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1 ACCESSIBILITY ANALYSIS3 1:5000



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CON	SULTANT		

BIKE ROUTE

BUS STOP

PEDESTRIAN

ROUTE

■ ■ BUS ROUTE

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DRAWING TITLE

ACCESSIBILITY ANALYSIS

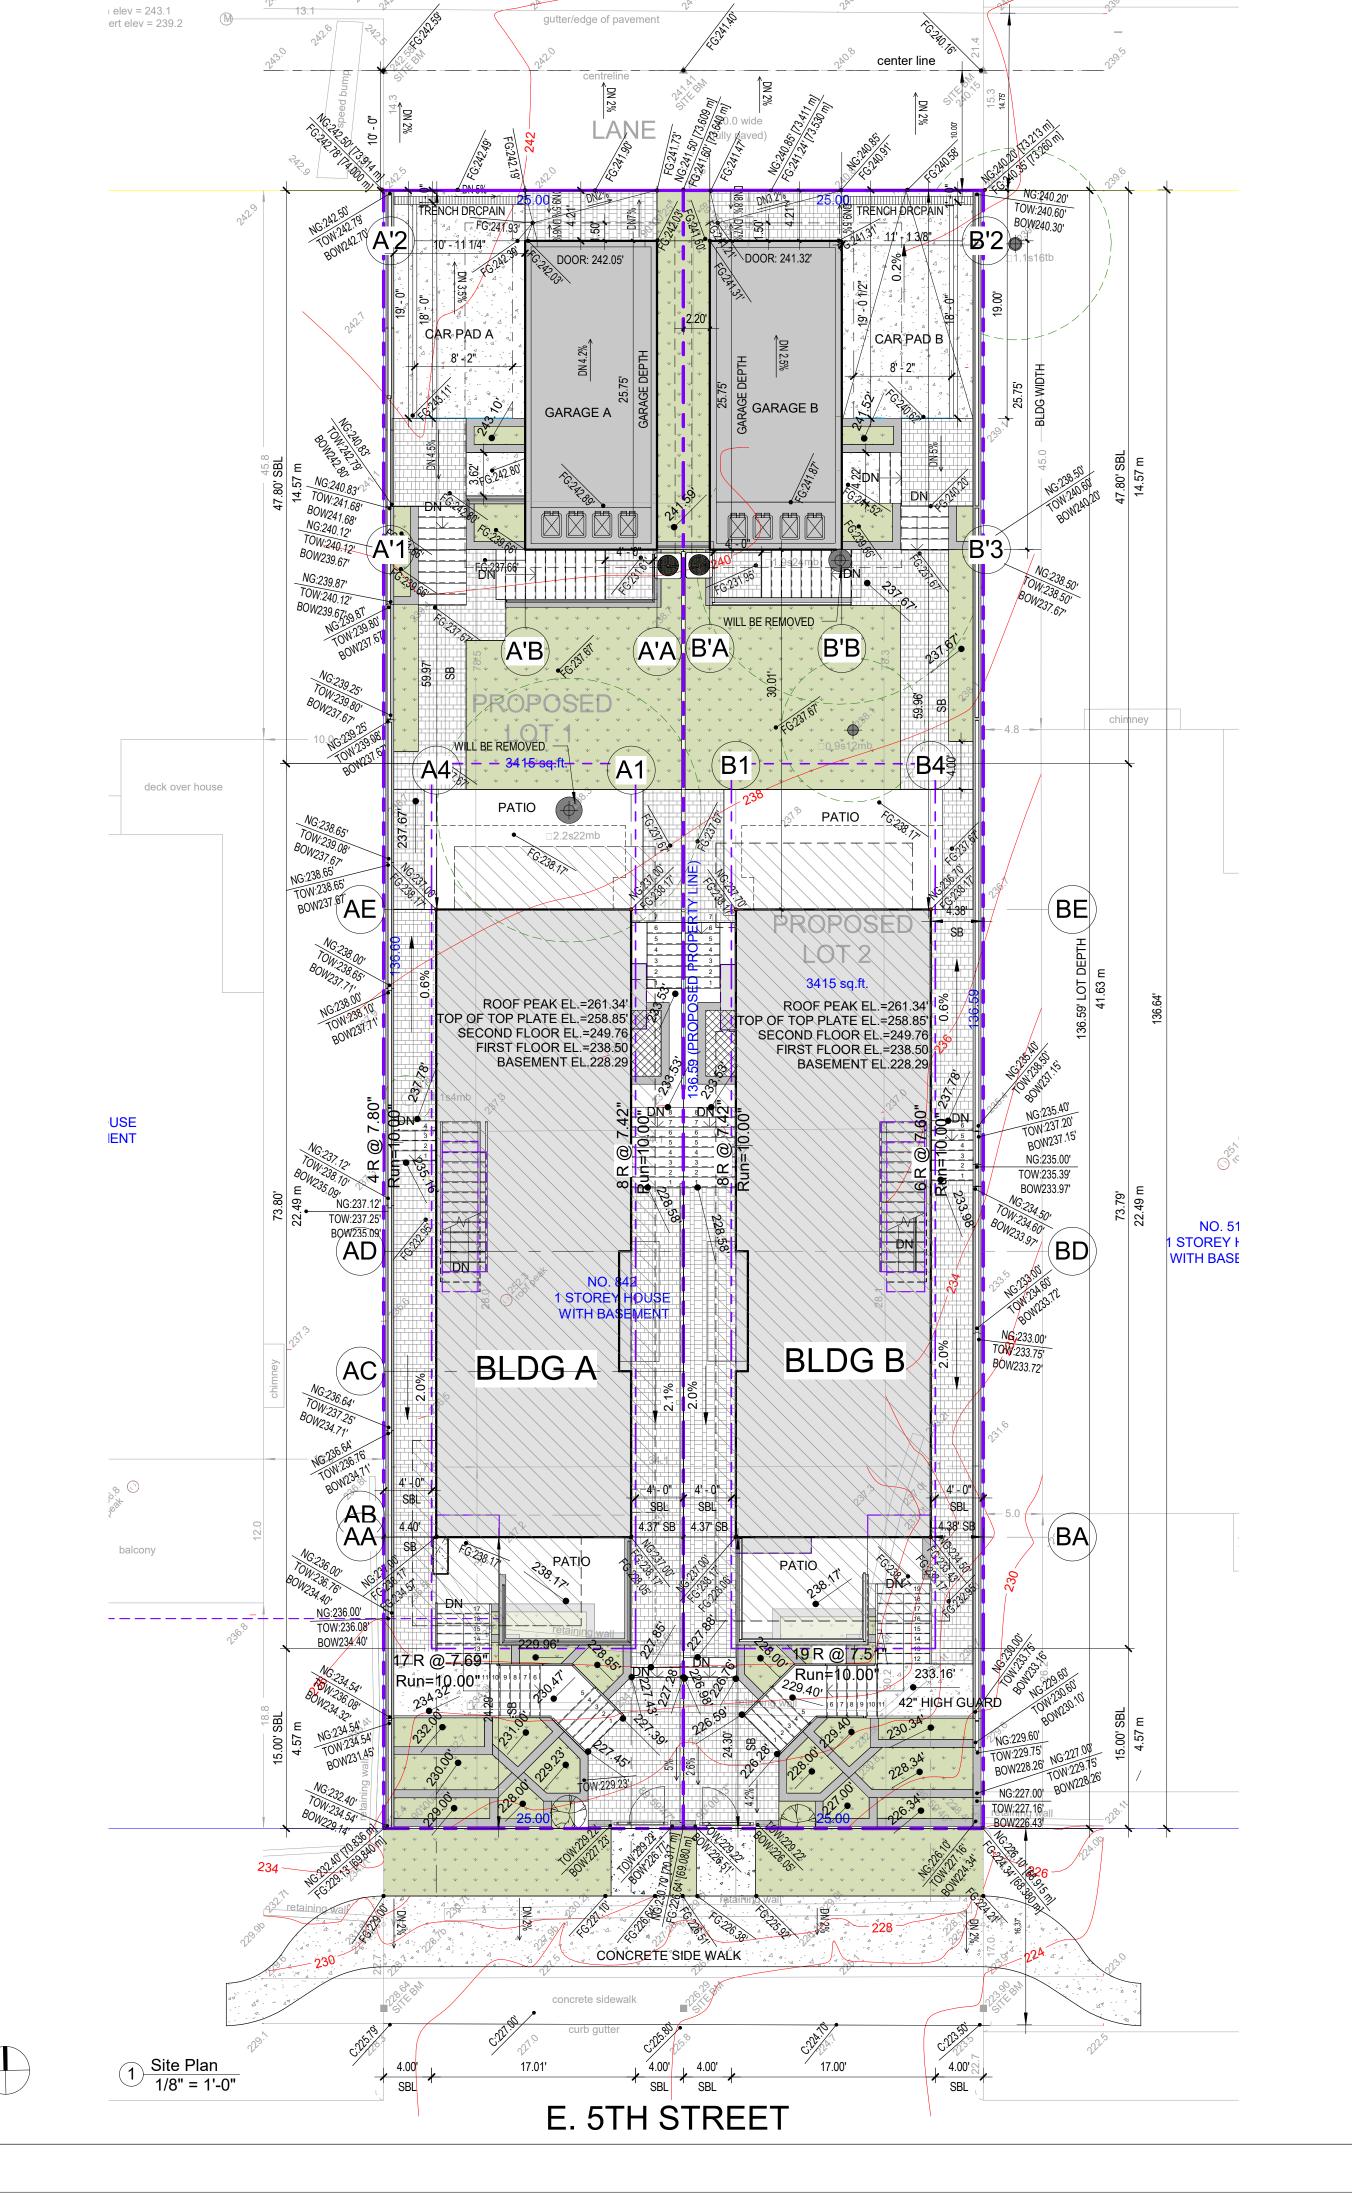
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PROJECT NO. PLOT DATE MAY 15, 2024 DRAWN 1:5000 REVIEWED 23285 Checker

A03



LOT "A"(WEST)

		BU	ILDING ANALYSIS	5			
CIVIC ADDRESS:			842 EAST 5TH S	TREET, I	NORTH VANCOUVER, B.C.		
LEGAL DESCRIPTION:	LOT 12 BLOCK 15 DISTRICT LOT 273 PLAN 1063						
ZONE:				RS1	TO RS2		
LOT AREA:				34	415		
LOT WIDTH				:	25		
USAGE			TWO-	UNIT RE	EIDENTIAL ZONE		
	ALLOWED	UNIT	PROPOSED	UNIT	COMMENTS		
FLOOR SPACE RATIO	1707.5	ft²	1,688.29	ft²	DECK AND COVERD PORCH NOT INCLUDED		
FIRST FLOOR AREA		ft²	837.87	ft²			
UPPER FLOOR AREA		ft²	850.42	ft²			
BELOW GRADE FLOOR AREA	FSR	ft²	9.60	ft²			
BELOW GRADE FLOOR AREA	EXCLUDED	ft²	830.80	ft²			
TOTAL LIVING SPACE		ft²	2528.69	ft²			
PRINCIPAL BUILDING COVERAGE		%	29.99%	%			
COMBINED LOT COVERAGE		%	46.58%	%	INDLUDES ACCESSORY BUILDING, DECK, AND COVERED		
COVERED PORCH		ft²	0.00	ft²			
COVERED BACK DECK		ft²	0.00	ft²			
BALCONY		ft²	166.60	ft²			
VERANDA		ft²	166.60	ft²			
FRONT YARD	15	ft	24.29	ft			
SIDE YARD-EAST	4	ft	4.36	ft			
SIDE YARD-WEST	4	ft	4.4	ft			
REAR YARD	47.8	ft	59.97	ft	0.35 TIMES THE LOT DEPTH		
ACCESSORY BUILDING	600	ft²	566.5	ft²	ACCESSORY GARAGE & STORAGE		
BLDG A AVERAGE FRONT	231.55	ft	227.88	ft			
BLDG A AVERAGE REAR	242	ft	242.19	ft			
REFERENCE GRADE	235.73	ft	235.73	ft			
MINIMUM FIRST STOREY LEVEL	238.23	ft	238.23	ft			
TOP PLATE	261.93	ft	258.85	ft			
ROOF RIDGE	268.73	ft	261.61	ft			

LOT "B" (EAST)

		В	UILDING ANALYSIS					
CIVIC ADDRESS:	CIVIC ADDRESS: 842 EAST 5TH STREET, NORTH VANCOUVER, B.C.							
LEGAL DESCRIPTION:			LOT 12 BLOCK	15 DIS	TRICT LOT 273 PLAN 1063			
ZONE:				RS1	. TO RS2			
LOT AREA:					3415			
LOT WIDTH					25			
USAGE			TWO-	UNIT R	REIDENTIAL ZONE			
	ALLOWED	UNIT	PROPOSED	UNIT	COMMENTS			
FLOOR SPACE RATIO	1707.5	ft²	1,706.14	ft²	DECK AND COVERD PORCH NOT INCLUDED			
FIRST FLOOR AREA		ft²	837.73	ft²				
UPPER FLOOR AREA		ft²	858.81	ft²				
BELOW GRADE FLOOR AREA	FSR	ft²	9.6	ft²				
BELOW GRADE FLOOR AREA	EXCLUDED	ft²	830.80	ft²				
TOTAL LIVING SPACE		ft²	2536.94	ft²				
PRINCIPAL BUILDING COVERAGE		%	29.71%	%				
COMBINED LOT COVERAGE		%	46.30%	%	INDLUDES ACCESSORY BUILDING, DECK, AND COVERED PORC			
PORCHES		ft²	0.00	ft²				
BACK DECK		ft²	0.00	ft²				
BALCONY		ft²	149.00	ft²				
VERANDA		ft²	149.00	ft²				
FRONT YARD	15	ft	24.3	ft				
SIDE YARD-EAST	4	ft	4.38	ft				
SIDE YARD-WEST	4	ft	4.37	ft				
REAR YARD	47.8	ft	59.96	ft	0.35 TIMES THE LOT DEPTH			
ACCESSORY BUILDING	600	ft²	566.5	ft²	ACCESSORY GARAGE & STORAGE			
BLDG B AVERAGE FRONT	228.4	ft	225.49	ft				
BLDG B AVERAGE REAR	240.85	ft	240.97	ft				
REFERENCE GRADE	233.38	ft	233.38	ft				
MINIMUM FIRST STOREY LEVEL	235.88	ft	238.50	ft				
TOP PLATE	259.58	ft	258.85	ft				
ROOF RIDGE	266.38	ft	260.84	ft				

Abbreviation LEGEND

SITE PLAN MATERIAL LEGEND

Fireplace guard	GFP HG	SIIE PLAN	MATERIAL LEGEND	SITE PLAN LINE	TYPES	
Handrail Vidth	HH LW		RETAINING WALL			
er Window Head	LWH		RETAINING WALL	PROPERTY LINE		
erty Line	PL					
osed	PR	- A	CONCRETE SLAB / PAVER	SETBACK LINE		
p Segment	RS		SONORE LE SEAB / I AVEIX			
Drain	RD					
ack	SB	7 - 7		LEVEL 1 OUTLINE		
ack line	SBL		ASPHALT			
e down	SDW	ı =∀ = /				
e Up	SUP	1 - 1 - 1 - 1 - 1 - 1 - 1 - 1 - 1 - 1 -		LEVEL 2 OUTLINE		
ke Alarm	SA		SAND			
ladding oundation	TCLD TFND					
earest opening	TNO	¥ ¥		ROOF OUTLINE		
oad Center line	TRCL	Ψ Ψ Ψ Ψ Ψ	GARDEN / LAWN			
of	TO	Ψ Ψ Ψ Ψ Ψ	GARDEN / LAWN	ROOF OVERHANG		
of Slab	TOS			OUTLINE		
of Wall	TOP					
ch Drain	TD		LIGHTWELL	FENCE		



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EAST 5TH SUBDIVISION

842 EAST 5TH STREET, CITY OF NORTH VANCOUVER, B.C.

DRAWING TITLE

SITE PLAN

DRAWING ISSUE

RSSUED FOR RS-2 REZONING

MAY 15, 2024 23285 SCALE

DRAWING NO. A04

A05

Site Plan-Lot Coverage
1/8" = 1'-0"

LOT COVERAGE AREA BREAKDOWN

Lot Area		3415				
	Allo	owed	Pro	vided		
	%	Area ft²	%	Area ft²		
Principal building lot coverage	35.00%	1195.25	29.98%	1,023.94		
Combined Lot coverage	N/A	N/A	46.57%	1,590.44		

Principal Building	AREA
Building Footprint	840.40 ft ²
First Floor overhangs	6.94 ft ²
Second Floor overhangs	10.00 ft ²
Front Porches (Including Slab With 3' Height Above Existing)	0.00 ft ²
Back Decks (Including Slab With 3' Height Above Existing)	0.00 ft ²
Front Decks (Including Slab With 3' Height Above Existing)	0.00 ft ²
Balcony	166.60 ft ²
Double count deduction, Deck Over Living Space	0.00 ft ²
Double count deduction, Second Floor Balcony Projections Over Deck	0.00 ft ²
Double count deduction, Second Floor Overhang over Deck and Porch	0.00 ft ²
Architectural Ornament	0.00 ft ²
Total Decks, Balconies, Porches, etc.	166.60 ft ²
Principal Building Total	1,023.94 ft ²
Accessory Building	
Accessory Building (MAX 880 ft²)	566.50 ft ²
Exclusions	
Second Floor Projections Over the Deck	0.00 ft ²
GRAND TOTAL	1,590.44 ft ²

Calculation Note:

CAR PAD

GARAGE A

LANE

GARAGE B

CAR PAD

4 R @ 7.62B'3

Run=11.00"

B4

BC

BBBA

~(B'B)

PATIO: 182.50 ft²

BALCONY: 74.08 ft²

SECOND FLOOR
 OVERHANGS:
 18.39 ft²

Run=10.00"

- FIRST FLOOR

OVERHANG: 6.94 ft²

7 R @ 6.51" 7 R @ 6.51"

4 CONCRETE SIDE WALK

E. 5TH STREET

Run=11.00"

FIRST FLOOR OVERHANG: 6.94 ft²

BLDG A

SECOND FLOOR OVERHANGS:

10 ft² —

AC

17 R @ 7.69" Run=10.00"

#Run=11.00"

LANE CENTER LINE

SITE PLAN- LOT COVERAGE LEGEND

GARDEN

CONCRETE PAVER

PAVERS ON PADSTALL

CONCRETE SLAB

ASPHALT

PEA GRAVEL

DOUBLE COUNT DIDUCTION

PRINCIPAL OR

OVERHANGS

ACCESSORY BUILDING

FRONT & BACK DECK

DECK OVER LINING SPACE

FRONT PORCH

PATIO

LIGHTWELL

BALCONY

LOT COVERAGE
1/4" = 1'-0"

CONCRETE WALL

The provided lot coverage calculation excludes the access stairs as they are not regulated in the zoning bylaw and definition of "Lot Coverage" for One Unit Residential use.

LOT COVERAGE AREA BREAKDOWN

Lot Area	3415						
	Allo	owed	Provided				
	%	Area ft²	%	Area ft²			
Principal building lot coverage	35.00%	1195.25	29.71%	1,014.73			
Combined Lot coverage	N/A	N/A	46.30%	1,581.23			

Principal Building	AREA
Building Footprint	840.40 ft ²
First Floor overhangs	6.94 ft ²
Second Floor overhangs	18.39 ft²
Front Porches (Including Slab With 3' Height Above Existing)	0.00 ft ²
Back Decks (Including Slab With 3' Height Above Existing)	0.00 ft ²
Front Decks (Including Slab With 3' Height Above Existing)	0.00 ft ²
Balcony	149.00 ft ²
Double count deduction, Deck Over Living Space	0.00 ft ²
Double count deduction, Second Floor Balcony Projections Over Deck	0.00 ft ²
Double count deduction, Second Floor Overhang over Deck and Porch	0.00 ft ²
Architectural Ornament	0.00 ft ²
Total Decks, Balconies, Porches, etc.	149.00 ft ²
Principal Building Total	1,014.73 ft ²
Accessory Building	
Accessory Building Garage & Storage (MAX 880 ft²)	566.50 ft ²
Exclusions	
Second Floor Projections Over the Deck	0.00 ft ²
GRAND TOTAL	1,581.23 ft ²

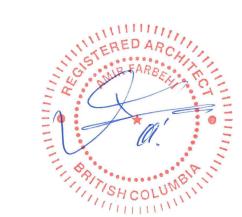
Calculation Note:

The provided lot coverage calculation excludes the access stairs as they are not regulated in the zoning bylaw and definition of "Lot Coverage" for One Unit Residential use.

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DRAWING TITLE

SITE PLAN - LOT COVERAGE

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PROJECT NO. PLOT DATE 23285 SCALE

MAY 15, 2024 REVIEWED As indicated

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BLDG.A- ACCESSORY BUILDING

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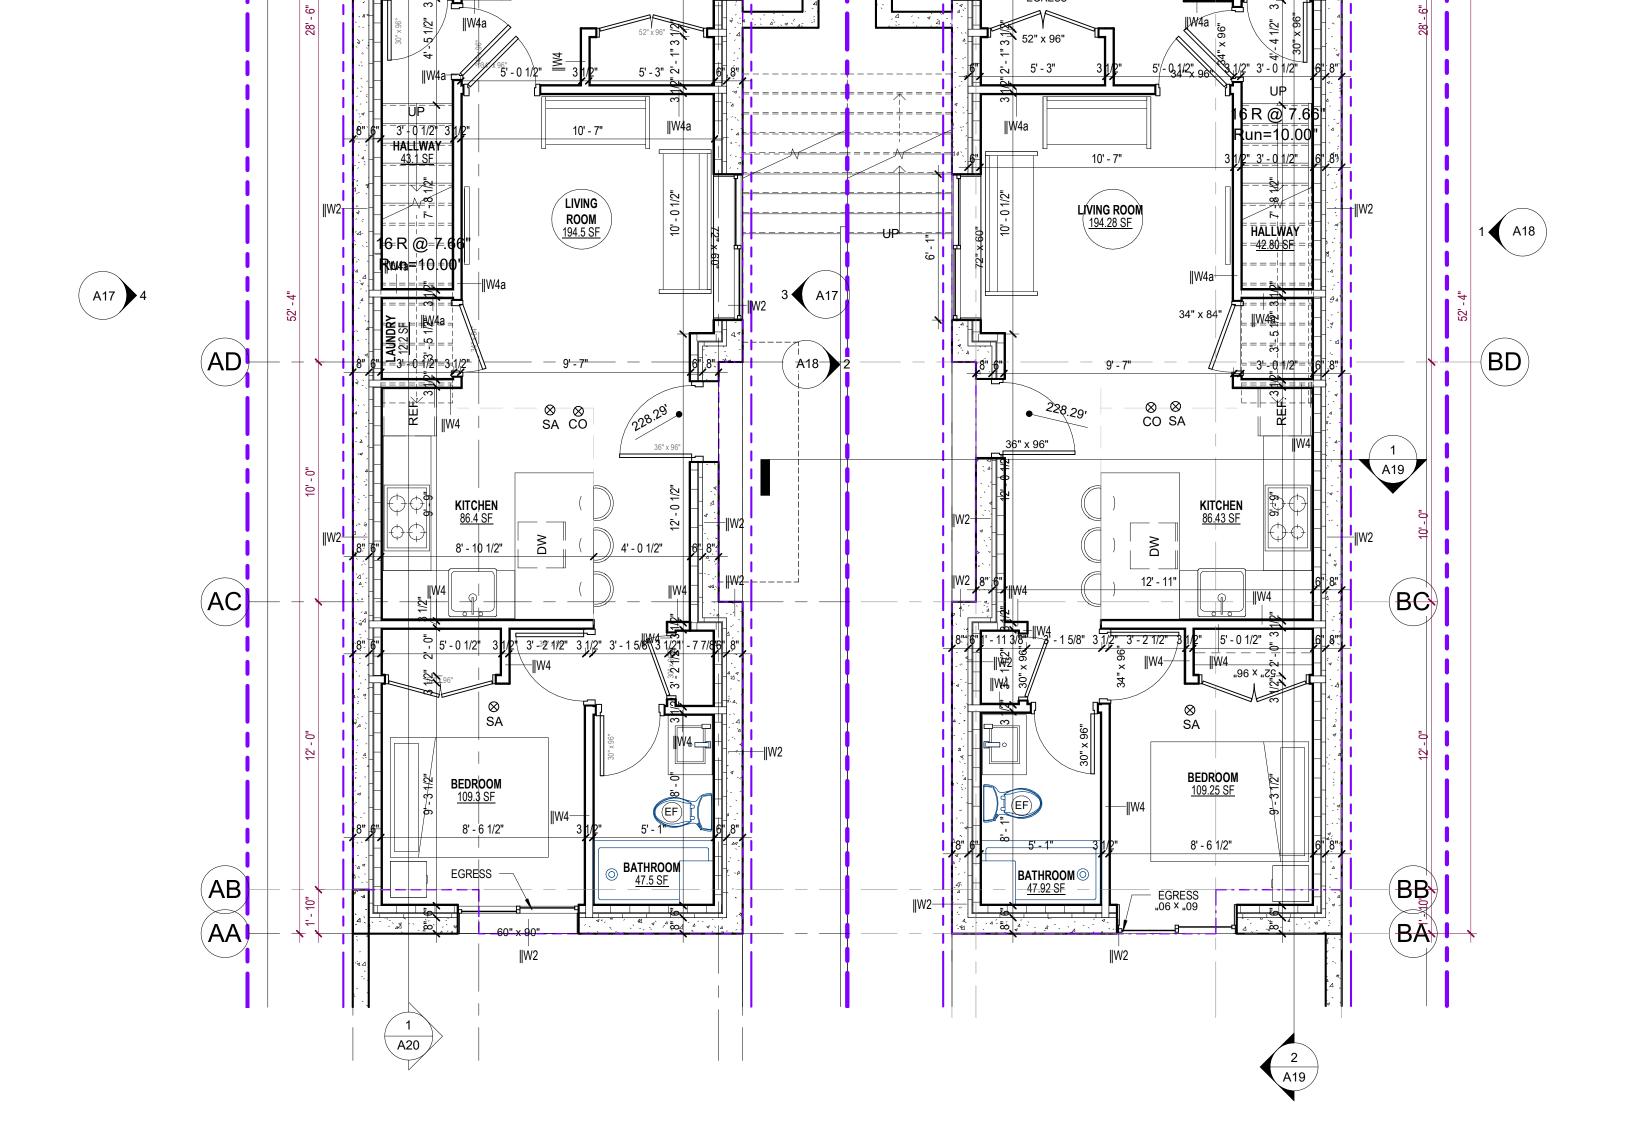
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A09

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10' - 0"

BEDROOM 155.00 SF

BATHROOM 45.13 SF

- 2x2" CONDUIT UP TO ROOF LEVEL

WALL MOUNT

10' - 0"

BEDROOM 155.2 SF

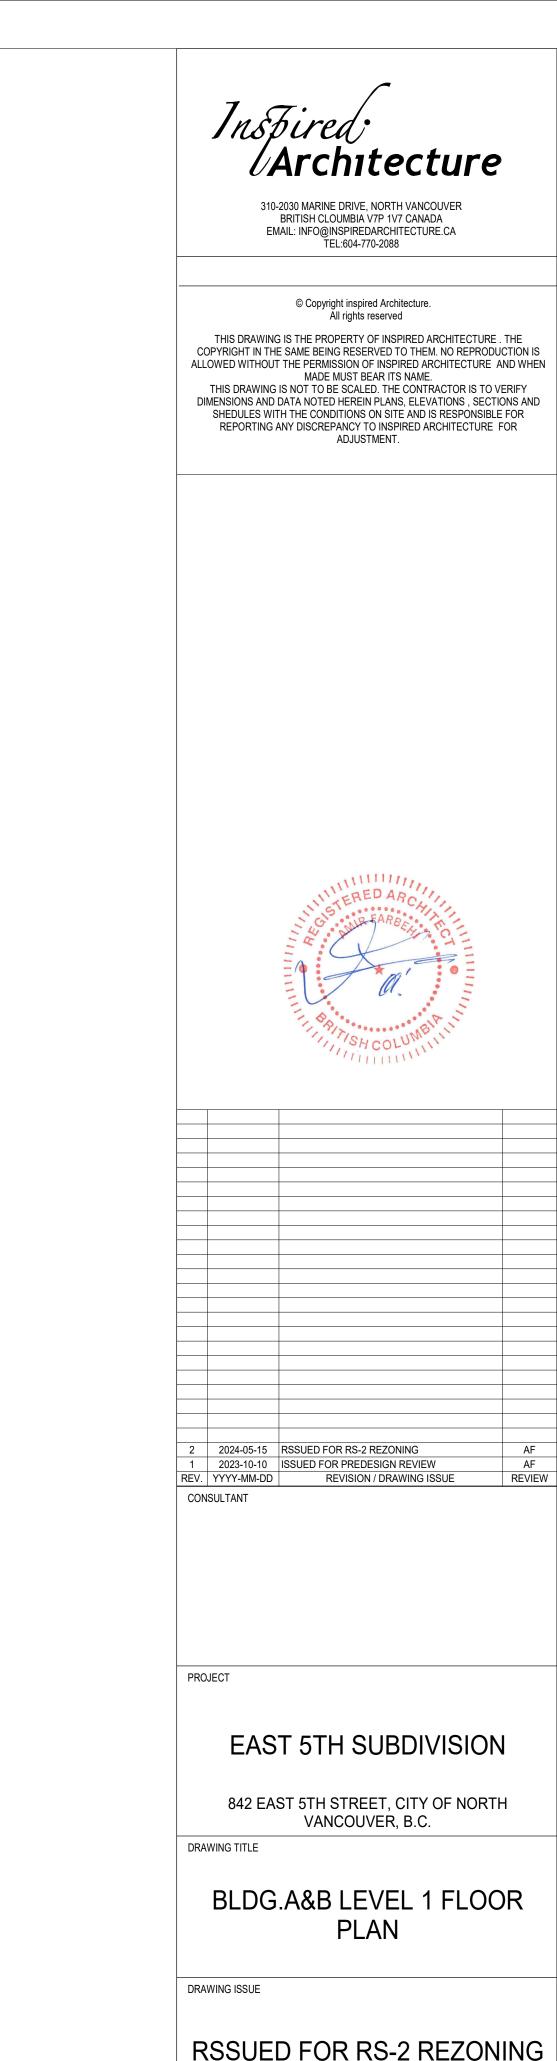
8' - 6 1/2"

CAP 2x2" CONDUIT ABOVE ROOF LEVEL

WALL MOUNT BOILER

1) 00-BLDG B-BASEMENT 1/4" = 1'-0"

1) 01-BLDG B-FIRST FLOOR 1/4" = 1'-0"



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BLDG.A&B LEVEL 1 FLOOR PLAN

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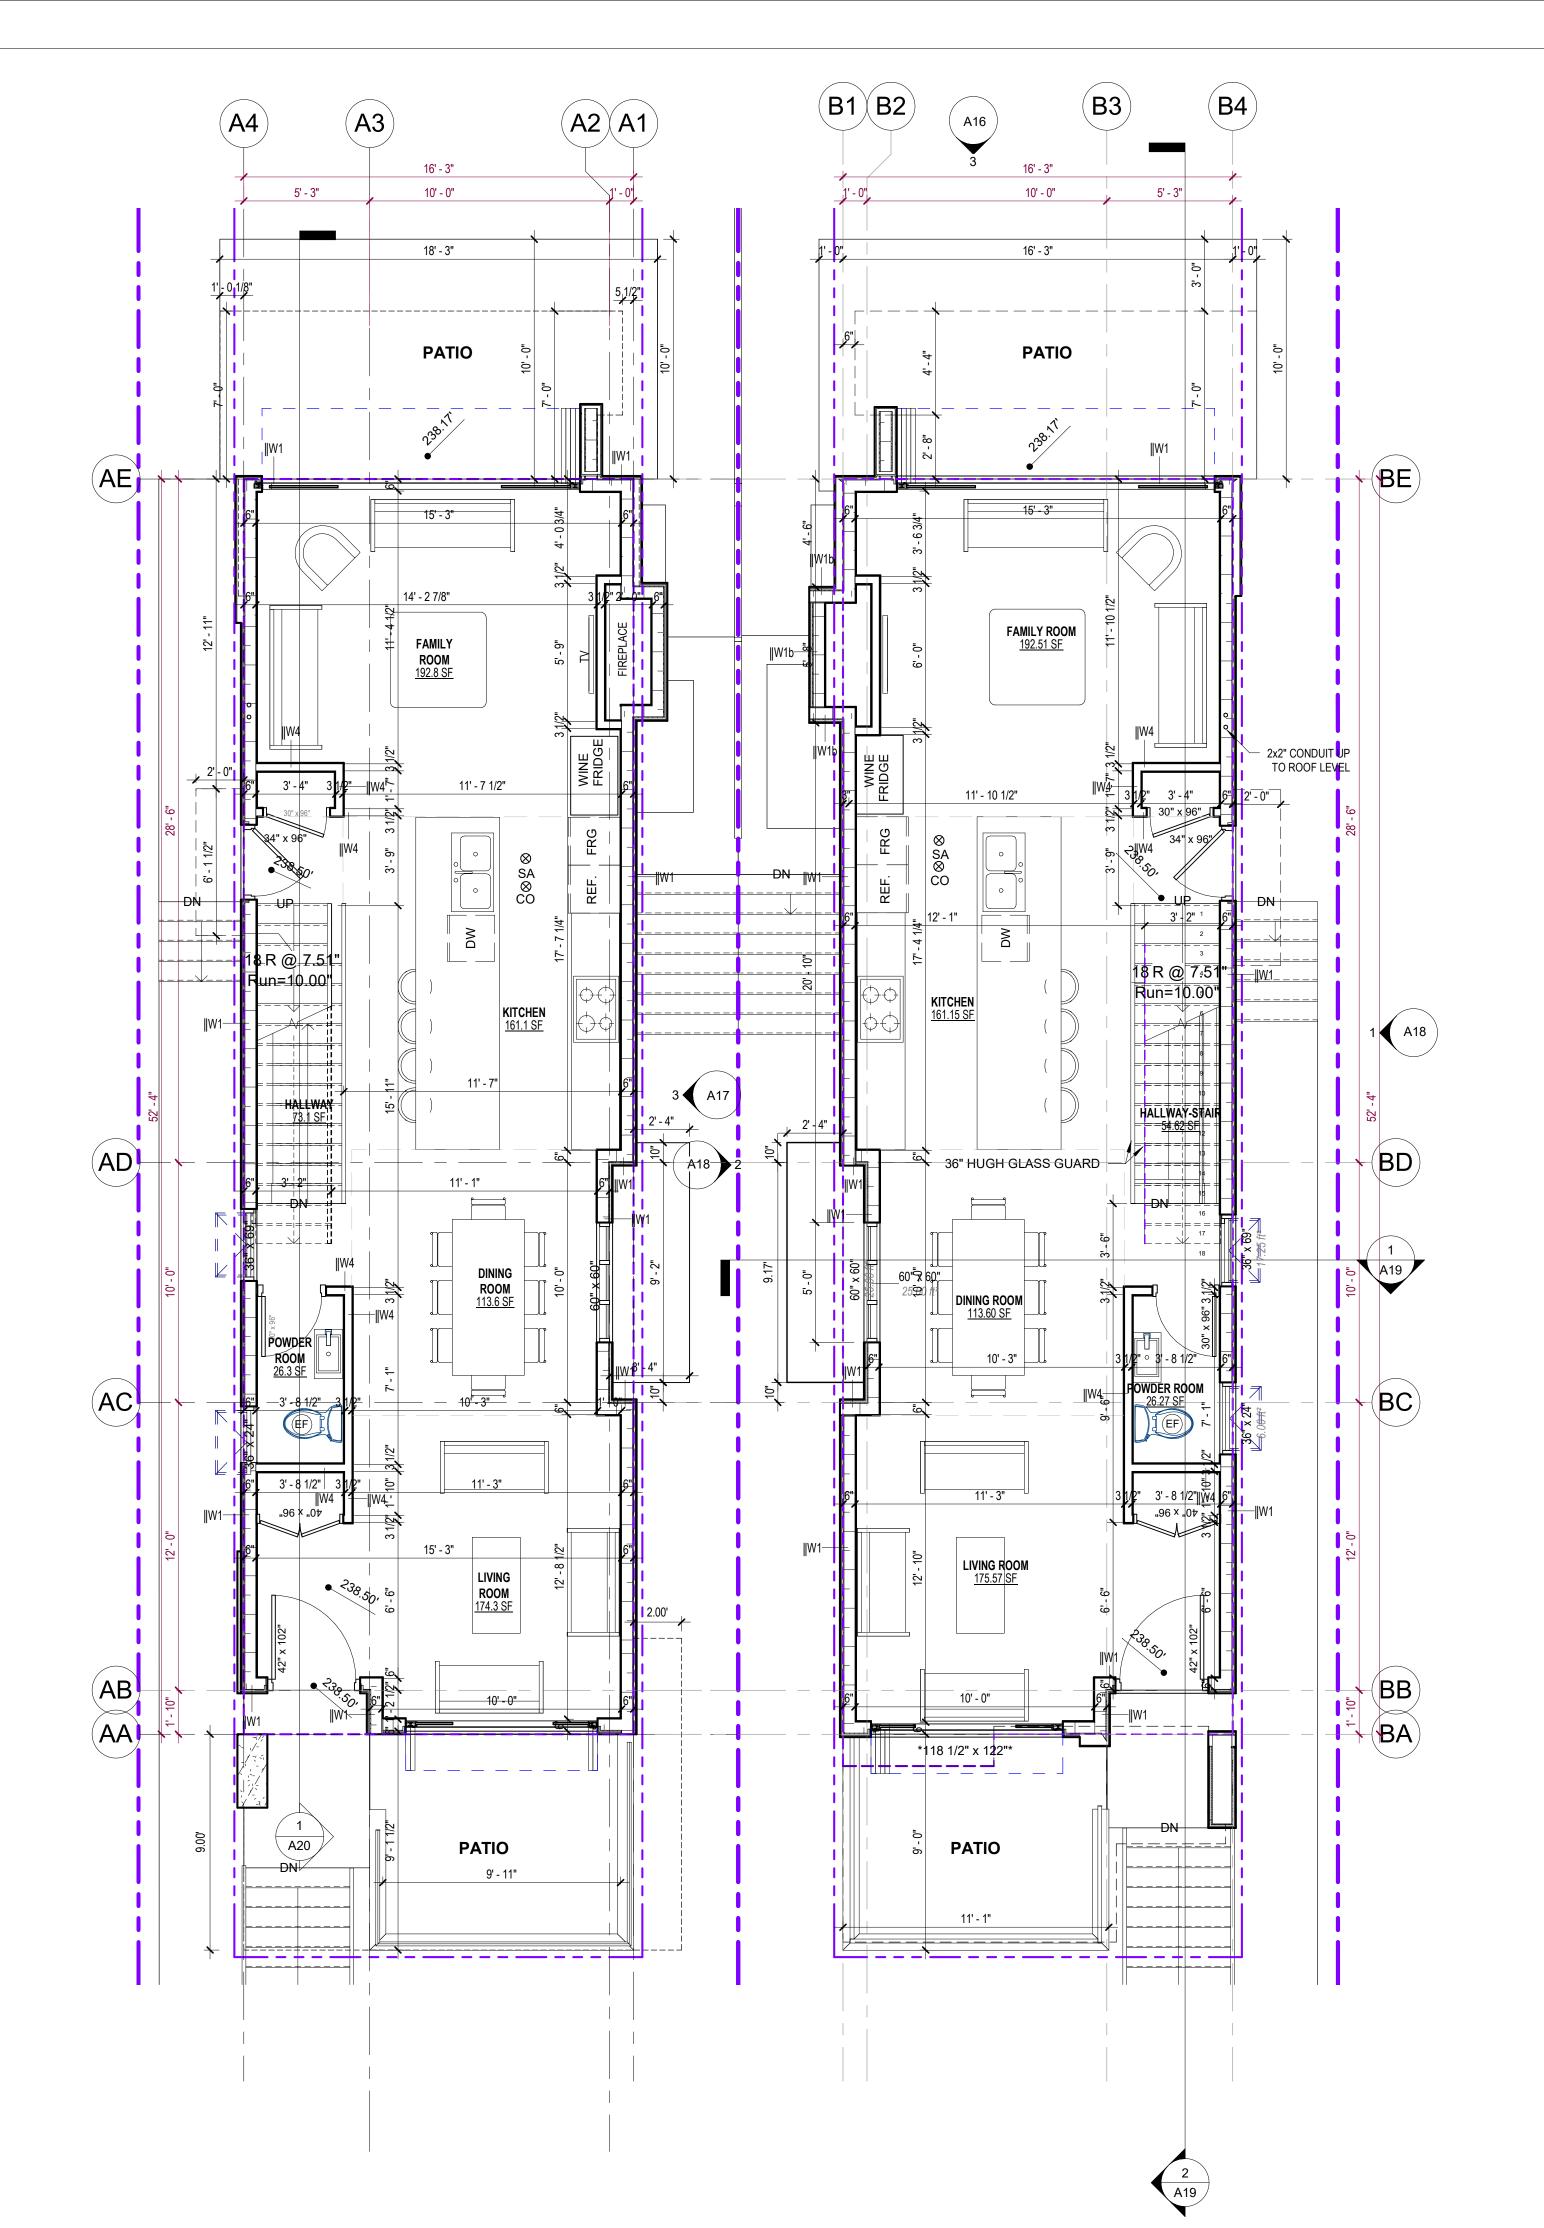
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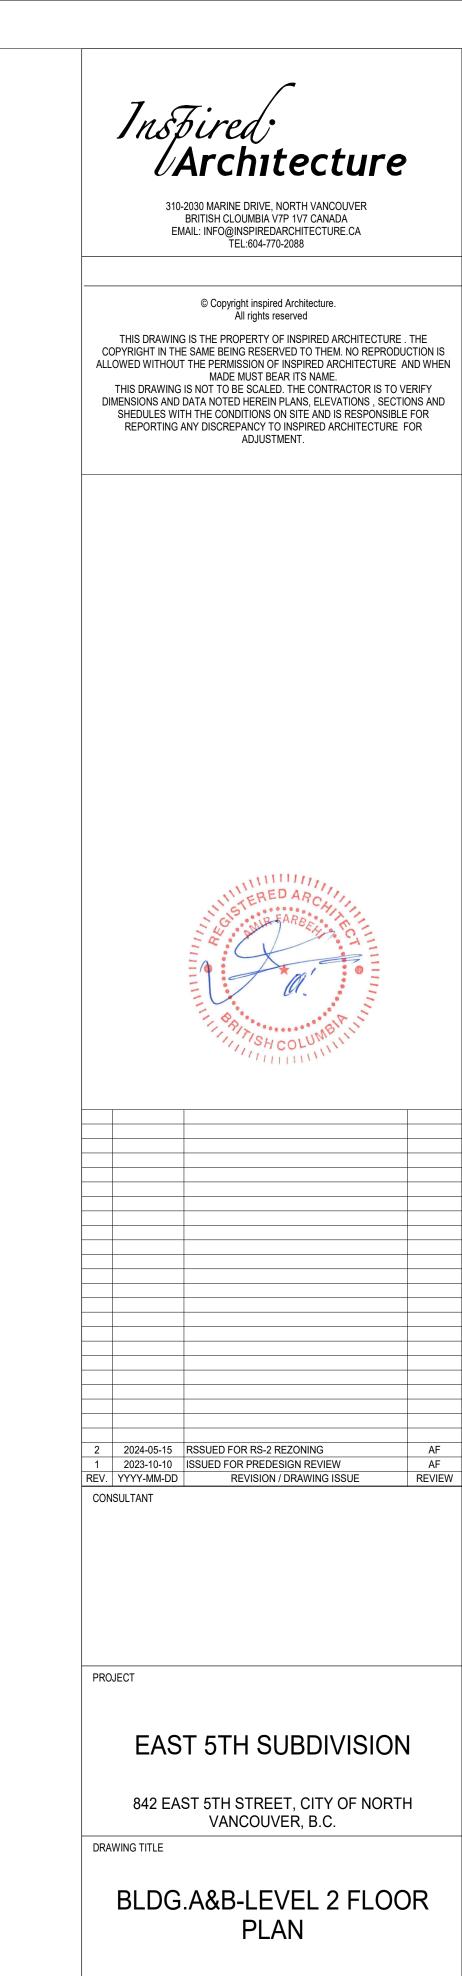
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REVIEWED





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BLDG.A&B-LEVEL 2 FLOOR PLAN

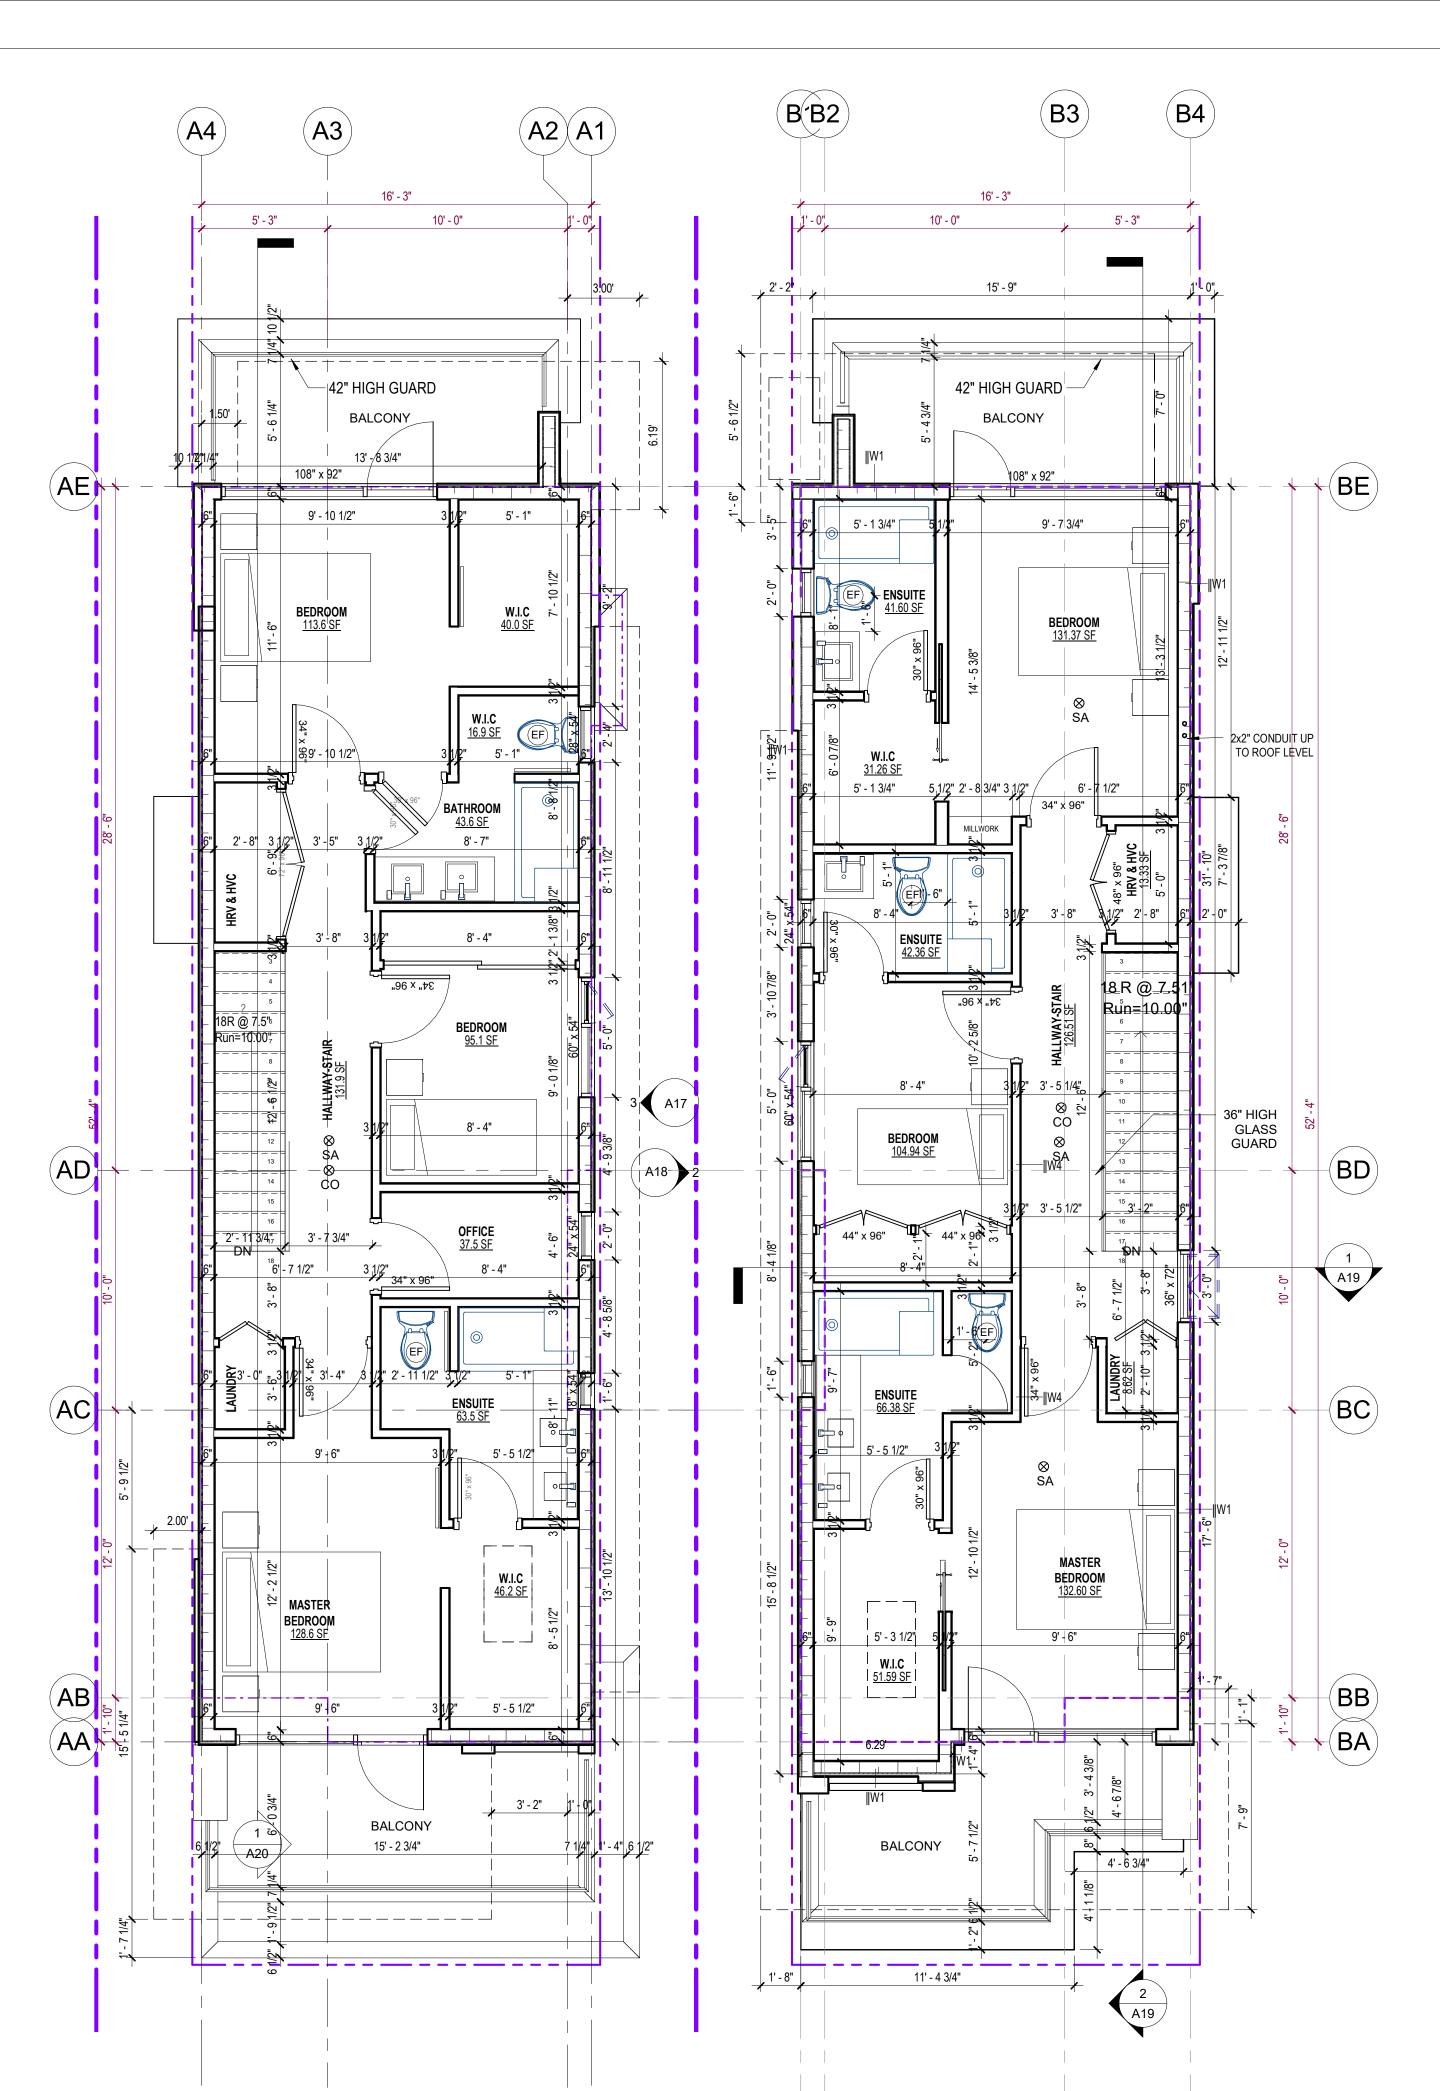
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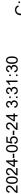
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A11







SOLLAR COLLECTOR!!

ROOF TRUSSES TO ACCOMMODATE

FLAT ROOF

16' - 3"

SKYLIGHT

ADDITIONAL DEAD LOAD OF 0.24 Kpa IN 張明S AREA

CAP 2x2" CONDUIT ABOVE ROOF LEVEL

BC

CAP 2x<mark>2</mark>" CONDUIT ABOVE ROOF LEVEL

AB

| SOLLAR COLLECTOR!!

RØOF TRUSSES TO

ACCOMMODATE
ADDITIONAL DEAD LOAD
OF 0.24 Kpa IN THIS AREA

FLAT ROOF

1 A20 Inspired Architecture

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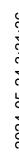
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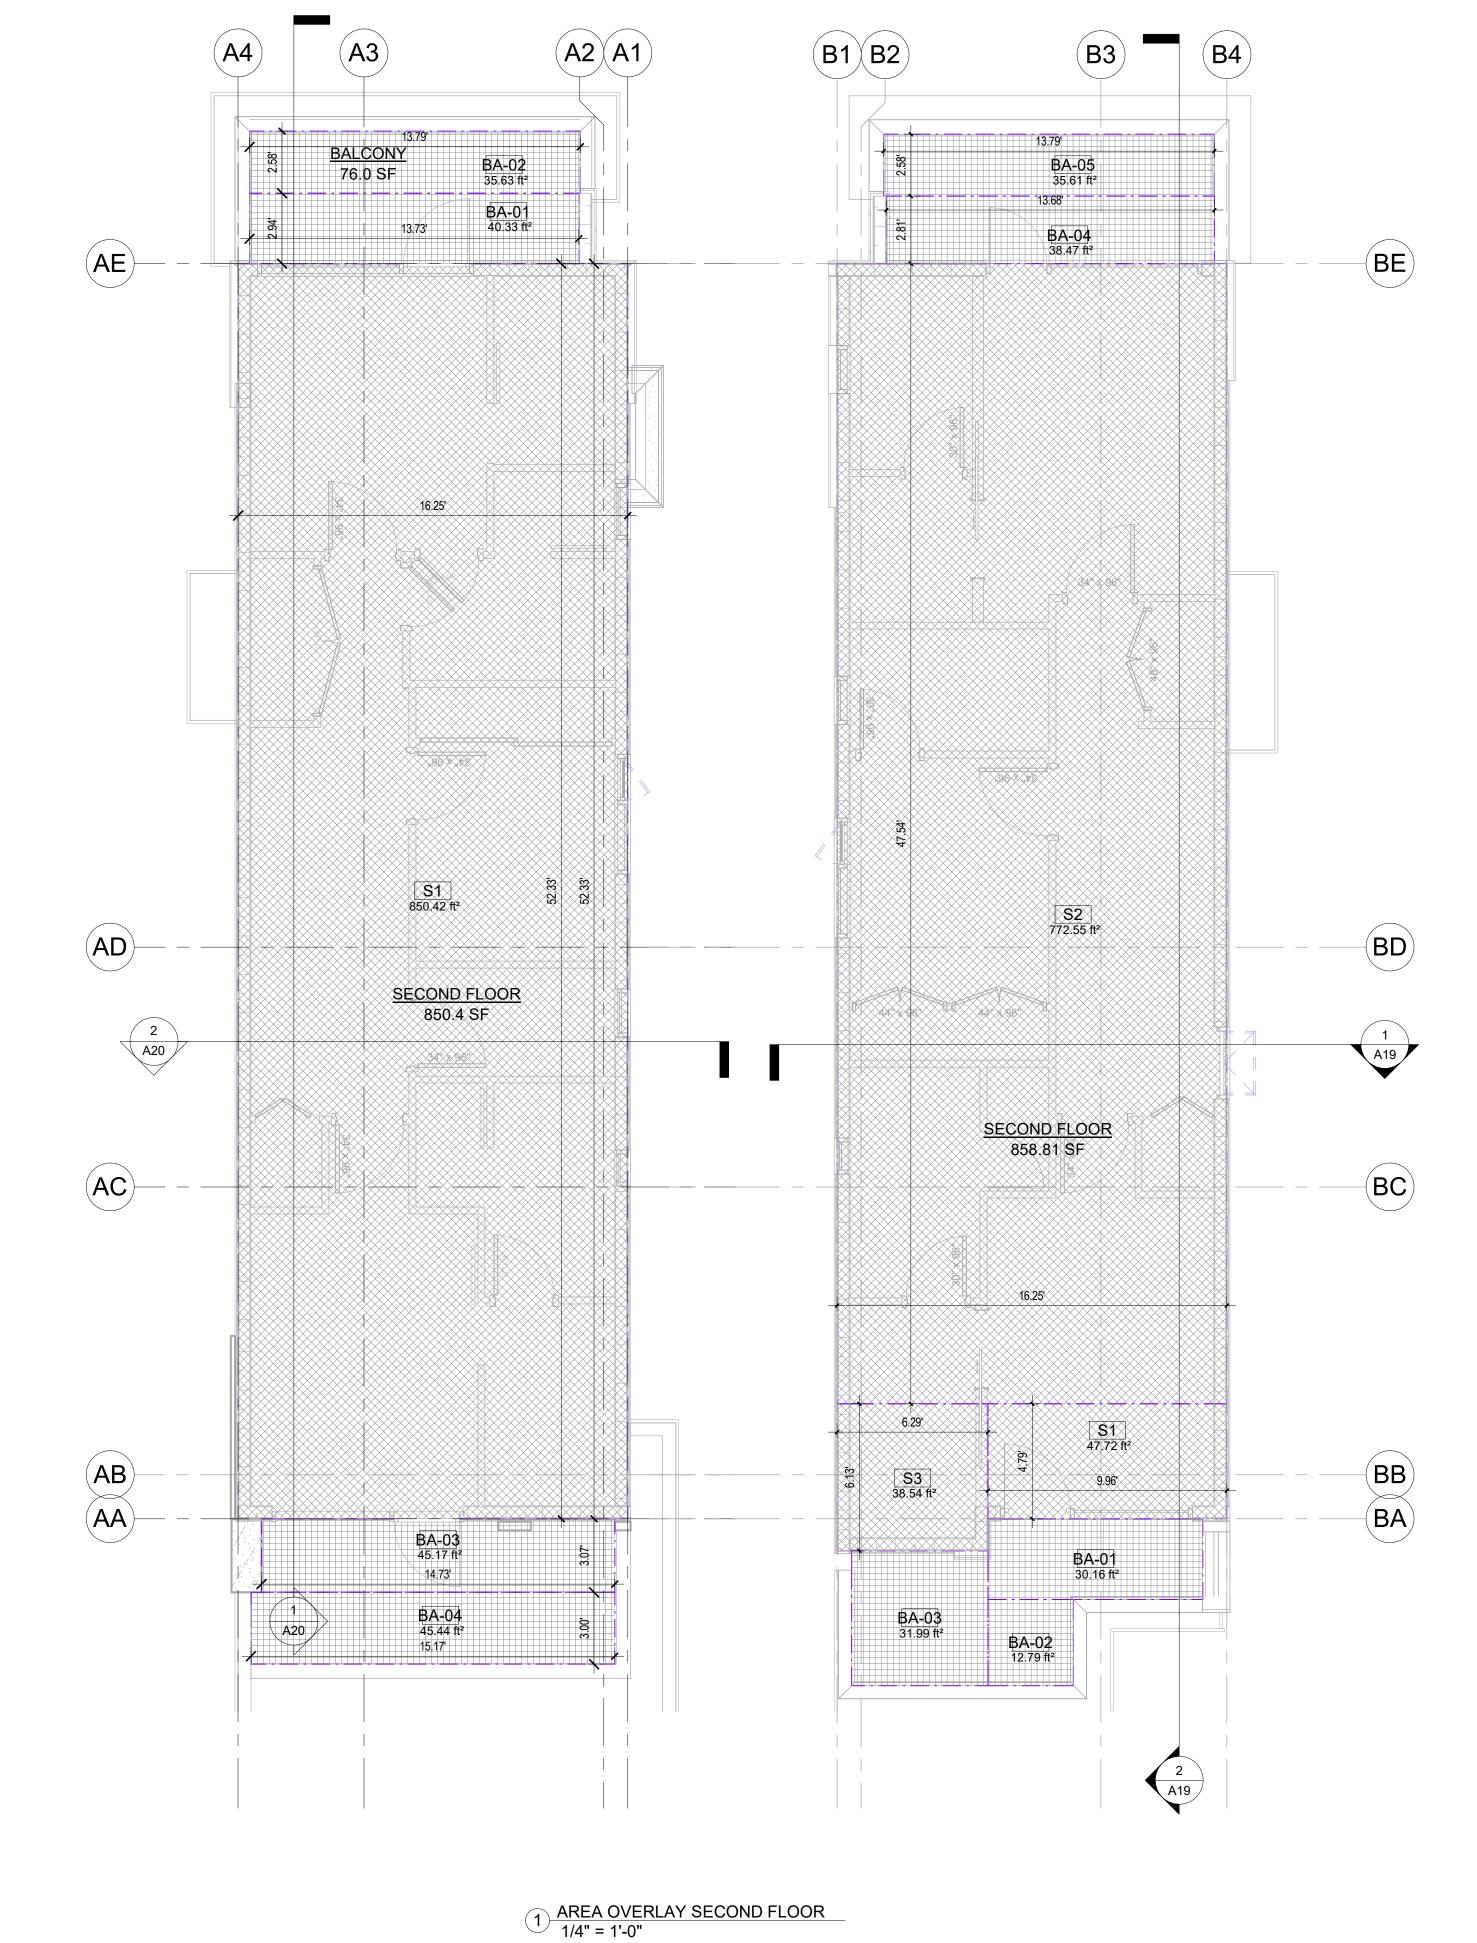
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23285 SCALE

SCALE 1/4" = 1'-0" REVIEWED

A12





ML	Mark	Dimension X	Dimension Y	Area	Gross Area Category
				1	
A-BASEMENT	A-B04	5.25'	1.83'	9.63 ft ²	Gross Area
A-BASEMENT: 1				9.63 ft ²	
A-FIRST FLOOR	F-01	11.00'	3.83'	42.17 ft²	Gross Area
A-FIRST FLOOR	F-02	5.25'	12.00'	63.00 ft ²	Gross Area
A-FIRST FLOOR	F-03	11.00'	10.00'	110.00 ft ²	Gross Area
A-FIRST FLOOR	F-04	15.25'	10.00'	152.50 ft ²	Gross Area
A-FIRST FLOOR	F-05	16.25'	18.54'	301.30 ft ²	Gross Area
A-FIRST FLOOR	F-06	17.54'	5.50'	96.45 ft ²	Gross Area
A-FIRST FLOOR	F-07	16.25'	4.46'	72.45 ft ²	Gross Area
A-FIRST FLOOR: 7				837.87 ft ²	
A-SECOND FLOOR	S1	16.25'	52.33'	850.42 ft ²	Gross Area
A-SECOND FLOOR A-SECOND FLOOR: 1	S1	16.25'	52.33'	850.42 ft ² 850.42 ft ²	Gross Area
	S1 B-B04	5.25'	52.33' 1.83'		Gross Area Gross Area
A-SECOND FLOOR: 1				850.42 ft ²	
A-SECOND FLOOR: 1 B-BASEMENT B-BASEMENT: 1				850.42 ft² 9.63 ft²	
A-SECOND FLOOR: 1 B-BASEMENT B-BASEMENT: 1 B-FIRST FLOOR	B-B04	5.25'	1.83'	850.42 ft² 9.63 ft² 9.63 ft²	Gross Area
A-SECOND FLOOR: 1 B-BASEMENT B-BASEMENT: 1 B-FIRST FLOOR B-FIRST FLOOR	B-B04	5.25'	1.83' 3.82'	850.42 ft ² 9.63 ft ² 9.63 ft ² 42.03 ft ²	Gross Area Gross Area
B-BASEMENT B-BASEMENT: 1 B-FIRST FLOOR B-FIRST FLOOR B-FIRST FLOOR	B-B04 F-01 F-02	5.25' 11.00' 5.25'	1.83' 3.82' 1.99'	9.63 ft ² 9.63 ft ² 9.63 ft ² 42.03 ft ² 10.44 ft ²	Gross Area Gross Area Gross Area
B-BASEMENT B-BASEMENT: 1 B-FIRST FLOOR B-FIRST FLOOR B-FIRST FLOOR B-FIRST FLOOR	F-01 F-02 F-04	5.25' 11.00' 5.25' 16.25'	1.83' 3.82' 1.99' 10.01'	850.42 ft ² 9.63 ft ² 9.63 ft ² 42.03 ft ² 10.44 ft ² 162.70 ft ²	Gross Area Gross Area Gross Area Gross Area
A-SECOND FLOOR: 1 B-BASEMENT	F-01 F-02 F-04 F-05	5.25' 11.00' 5.25' 16.25' 15.25'	1.83' 3.82' 1.99' 10.01' 10.00'	9.63 ft ² 9.63 ft ² 9.63 ft ² 42.03 ft ² 10.44 ft ² 162.70 ft ² 152.50 ft ²	Gross Area Gross Area Gross Area Gross Area Gross Area Gross Area
A-SECOND FLOOR: 1 B-BASEMENT: 1 B-FIRST FLOOR B-FIRST FLOOR B-FIRST FLOOR B-FIRST FLOOR B-FIRST FLOOR	F-01 F-02 F-04 F-05 F-06	5.25' 11.00' 5.25' 16.25' 15.25' 16.25'	1.83' 3.82' 1.99' 10.01' 10.00' 18.46'	9.63 ft ² 9.63 ft ² 9.63 ft ² 42.03 ft ² 10.44 ft ² 162.70 ft ² 152.50 ft ² 299.95 ft ²	Gross Area
B-BASEMENT B-BASEMENT: 1 B-FIRST FLOOR	F-01 F-02 F-04 F-05 F-06 F-07	5.25' 11.00' 5.25' 16.25' 15.25' 16.25' 17.53'	1.83' 3.82' 1.99' 10.01' 10.00' 18.46' 5.42'	9.63 ft ² 9.63 ft ² 9.63 ft ² 42.03 ft ² 10.44 ft ² 162.70 ft ² 152.50 ft ² 299.95 ft ² 94.96 ft ²	Gross Area
A-SECOND FLOOR: 1 B-BASEMENT: 1 B-FIRST FLOOR	F-01 F-02 F-04 F-05 F-06 F-07	5.25' 11.00' 5.25' 16.25' 15.25' 16.25' 17.53'	1.83' 3.82' 1.99' 10.01' 10.00' 18.46' 5.42'	9.63 ft ² 9.63 ft ² 9.63 ft ² 42.03 ft ² 10.44 ft ² 162.70 ft ² 152.50 ft ² 299.95 ft ² 94.96 ft ² 75.16 ft ²	Gross Area
A-SECOND FLOOR: 1 B-BASEMENT B-BASEMENT: 1 B-FIRST FLOOR	F-01 F-02 F-04 F-05 F-06 F-07 F-08	5.25' 11.00' 5.25' 16.25' 15.25' 16.25' 16.25' 17.53' 16.25'	1.83' 3.82' 1.99' 10.01' 10.00' 18.46' 5.42' 4.63'	9.63 ft ² 9.63 ft ² 9.63 ft ² 42.03 ft ² 10.44 ft ² 162.70 ft ² 152.50 ft ² 299.95 ft ² 94.96 ft ² 75.16 ft ² 837.73 ft ²	Gross Area

Level	Mark	Dimension X	Dimension Y	Area	Gross Area Category
A-BASEMENT	A-B01	11.00'	13.83'	152.2 ft²	Below Grade
A-BASEMENT	A-B02	5.25'	12.00'	63.0 ft ²	Below Grade
A-BASEMENT	A-B03	15.25'	10.00'	152.5 ft ²	Below Grade
A-BASEMENT	A-B05	16.25'	28.50'	463.1 ft ²	Below Grade
B-BASEMENT	B-B01	11.00'	13.83'	152.2 ft ²	Below Grade
B-BASEMENT	B-B02	5.25'	12.00'	63.0 ft ²	Below Grade
B-BASEMENT	B-B03	15.25'	10.00'	152.5 ft ²	Below Grade
B-BASEMENT	B-B05	16.25'	28.50'	463.1 ft ²	Below Grade
Below Grade: 8				1661.6 ft ²	
A-Garage Door	A-G1	25.75'	11.00'	283.3 ft²	Garage
B-Garage Door	B-G1	25.75'	11.00'	283.3 ft²	Garage
Garage: 2		1 1		566.5 ft²	3
A-FIRST FLOOR	P-01	5.25'	7.40'	38.9 ft²	PATIO
	P-02	11.00'	9.00'	99.0 ft²	PATIO
A-FIRST FLOOR		18.25'	10.00'	182.5 ft ²	PATIO
A-FIRST FLOOR A-FIRST FLOOR	P-03	18.25			
	P-03 PA-01	11.00'	5.93'	65.2 ft ²	PATIO
A-FIRST FLOOR			5.93' 3.07'	65.2 ft² 33.8 ft²	PATIO PATIO
A-FIRST FLOOR B-FIRST FLOOR	PA-01	11.00'			
A-FIRST FLOOR B-FIRST FLOOR B-FIRST FLOOR	PA-01 PA-02	11.00' 11.00'	3.07'	33.8 ft ²	PATIO
A-FIRST FLOOR B-FIRST FLOOR B-FIRST FLOOR B-FIRST FLOOR	PA-01 PA-02 PA-03	11.00' 11.00' 5.25'	3.07' 5.74'	33.8 ft² 30.1 ft²	PATIO PATIO
A-FIRST FLOOR B-FIRST FLOOR B-FIRST FLOOR B-FIRST FLOOR B-FIRST FLOOR	PA-01 PA-02 PA-03	11.00' 11.00' 5.25'	3.07' 5.74'	33.8 ft² 30.1 ft² 182.5 ft²	PATIO PATIO

Level	Mark	Dimension X	Dimension Y	Dimension R	Area	Gross Area Category
20101	Man	Billionololly	Dimension 1	Billionelonit	71104	Gross / wed editogery
A-SECOND FLOOR	BA-01	13.73'	2.94'		40.3 ft ²	Balcony
B-SECOND FLOOR	BA-01	8.96'	3.37'		30.2 ft ²	Balcony
A-SECOND FLOOR	BA-02	13.79'	2.58'		35.6 ft ²	Balcony
B-SECOND FLOOR	BA-02	3.56'	3.59'		12.8 ft ²	Balcony
A-SECOND FLOOR	BA-03	14.73'	3.07'		45.2 ft ²	Balcony
B-SECOND FLOOR	BA-03	5.69'	5.63'		32.0 ft ²	Balcony
A-SECOND FLOOR	BA-04	15.17'	3.00'		45.4 ft ²	Balcony
B-SECOND FLOOR	BA-04	13.68'	2.81'		38.5 ft ²	Balcony
B-SECOND FLOOR	BA-05	13.79'	2.58'		35.6 ft ²	Balcony
Balcony: 9					315.6 ft ²	
Grand total: 9					315.6 ft ²	



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AREA OVERLAY SECOND FLOOR

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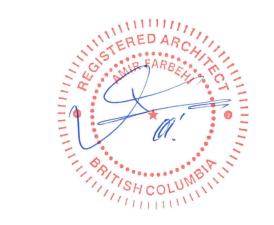
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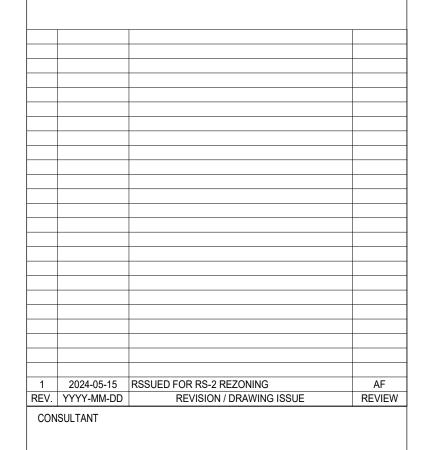
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DRAWING TITLE

AREA OVERLAY ACCESSORY BUILDING

DRAWING ISSUE

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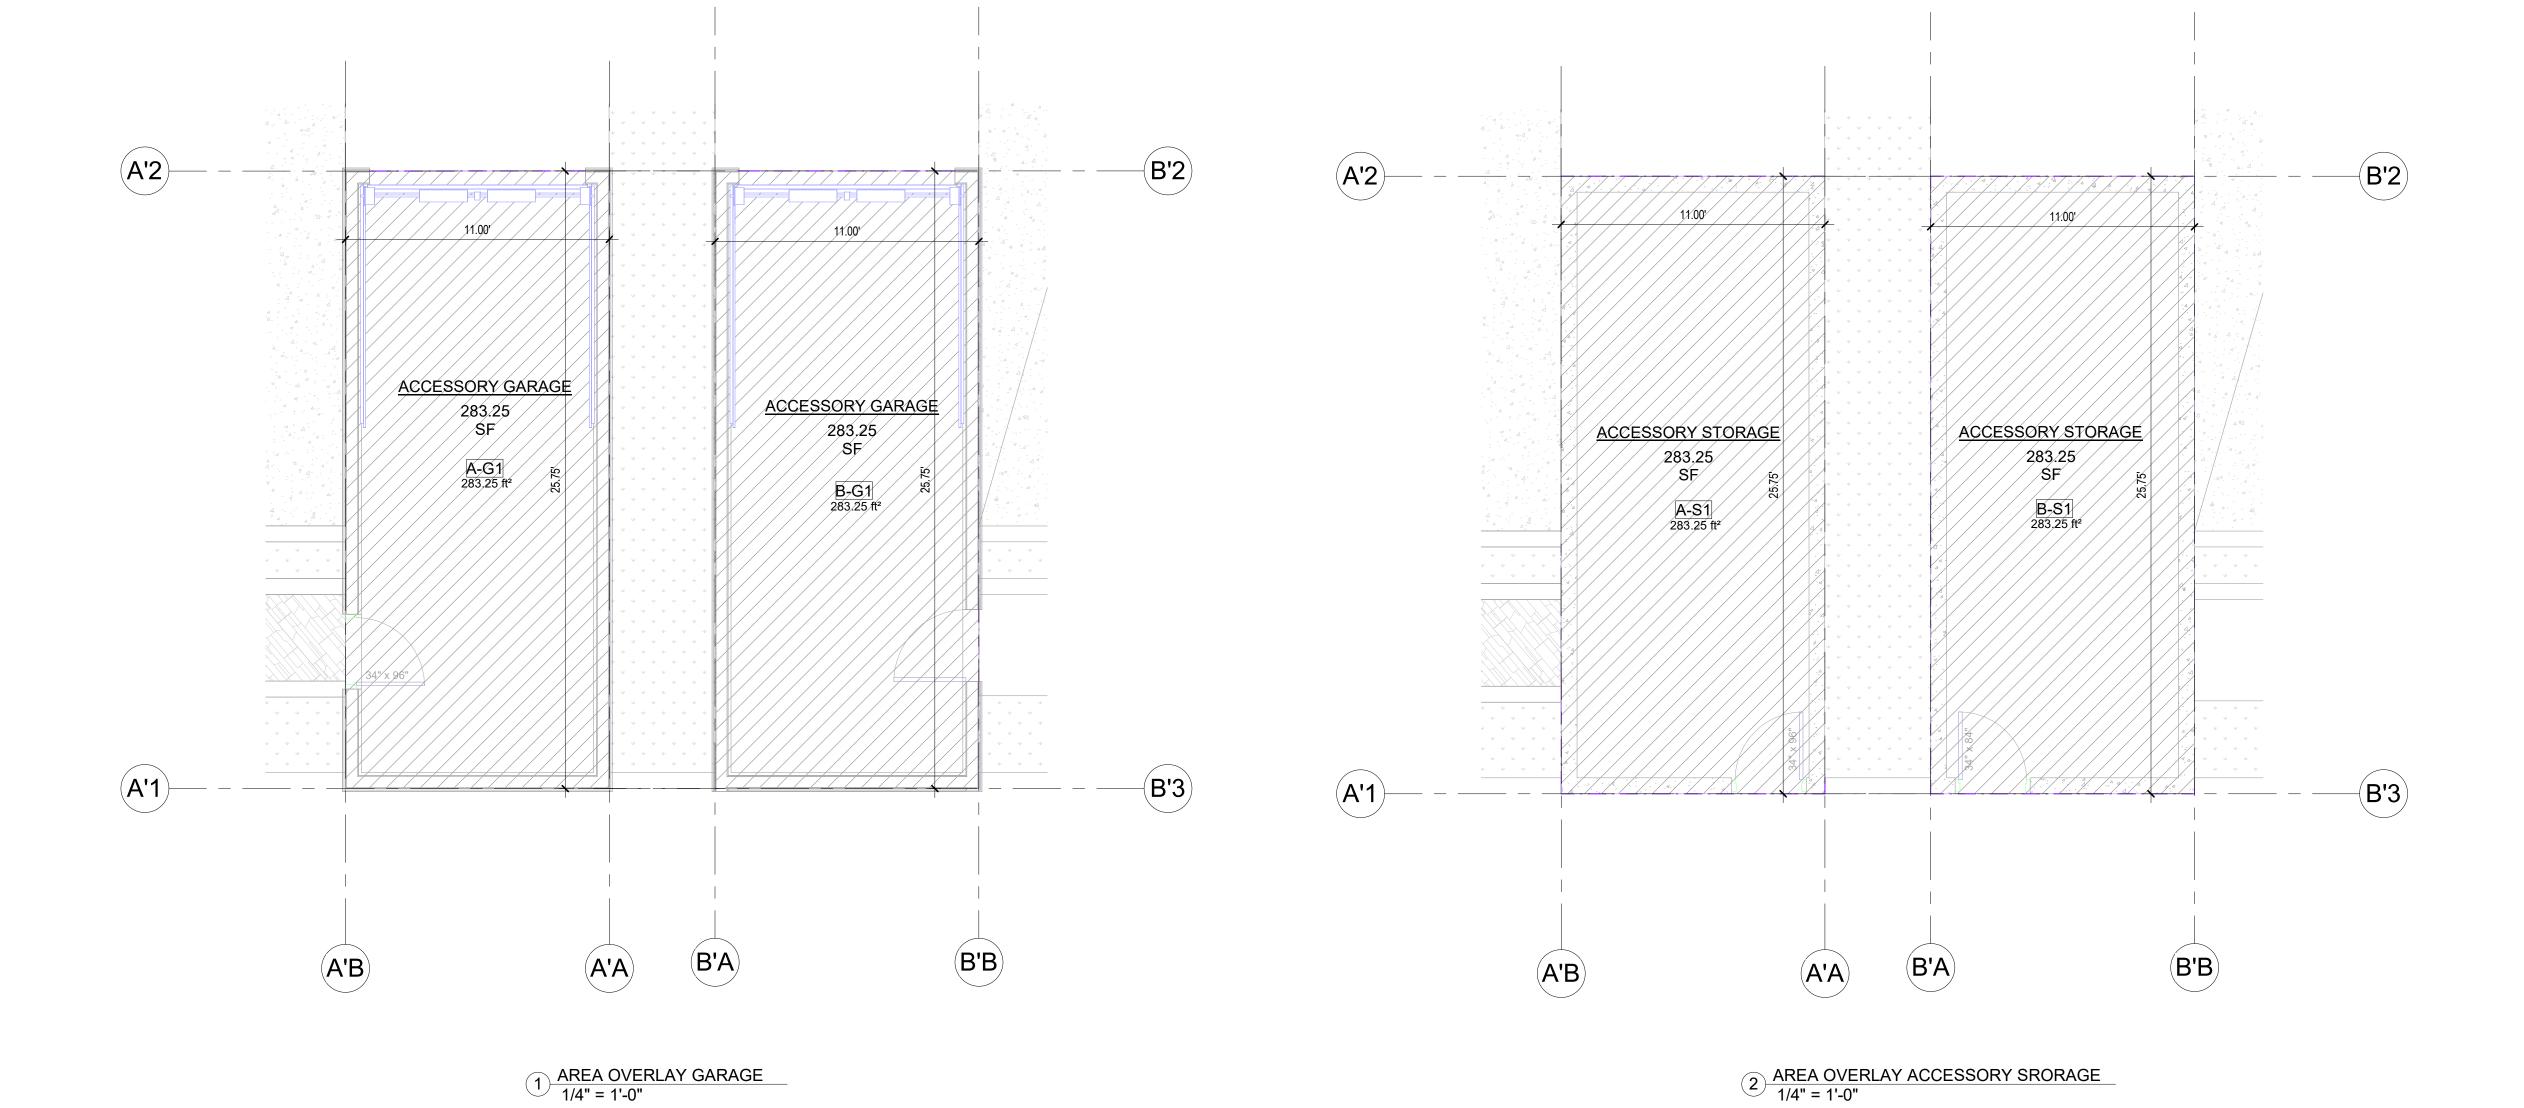
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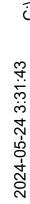
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BLDG.A&B SOUTH AND

RSSUED FOR RS-2 REZONING

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2	2024-05-15	RSSUED FOR RS-2 REZONING	
_ _	2023-10-10	ISSUED FOR PREDESIGN REVIEW	
REV.	YYYY-MM-DD	REVISION / DRAWING ISSUE	R

PROJE

EAST 5TH SUBDIVISION

842 EAST 5TH STREET, CITY OF NORTH VANCOUVER, B.C.

DRAWING TITLE

BLDG.A- EAST & WEST ELEVATIONS

DRAWING ISSUE

RSSUED FOR RS-2 REZONING

PROJECT NO. PLOT DATE MAY 15, 2024 DRAWN

23285 SCALE 1/4" = 1'-0" REVIEWED

DRAWING NO.

A17

261.34 B- FLAT ROOF RIDGE

42" HIGH GUARD -

260.06 ROOF _ ___

258.85 B-U/S of Roof

257.76 U.W.Head

250.76 U.W.Sill

247.00 L.W. Head

249.76 B-SECOND FLOOR

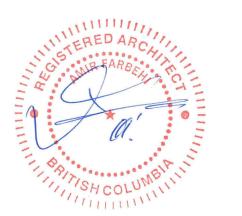
248.00 U/S of Flat ROOF

310-2030 MARINE DRIVE, NORTH VANCOUVER BRITISH CLOUMBIA V7P 1V7 CANADA EMAIL: INFO@INSPIREDARCHITECTURE.CA TEL:604-770-2088

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42" HIGH GUARD

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PROJECT

EAST 5TH SUBDIVISION

842 EAST 5TH STREET, CITY OF NORTH VANCOUVER, B.C.

DRAWING TITLE

BLDG.B EAST AND WEST **ELEVATIONS**

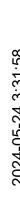
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RSSUED FOR RS-2 REZONING

MAY 15, 2024 23285 REVIEWED

DRAWING NO.

A18



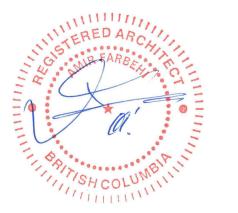




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BLDG-B SECTIONS

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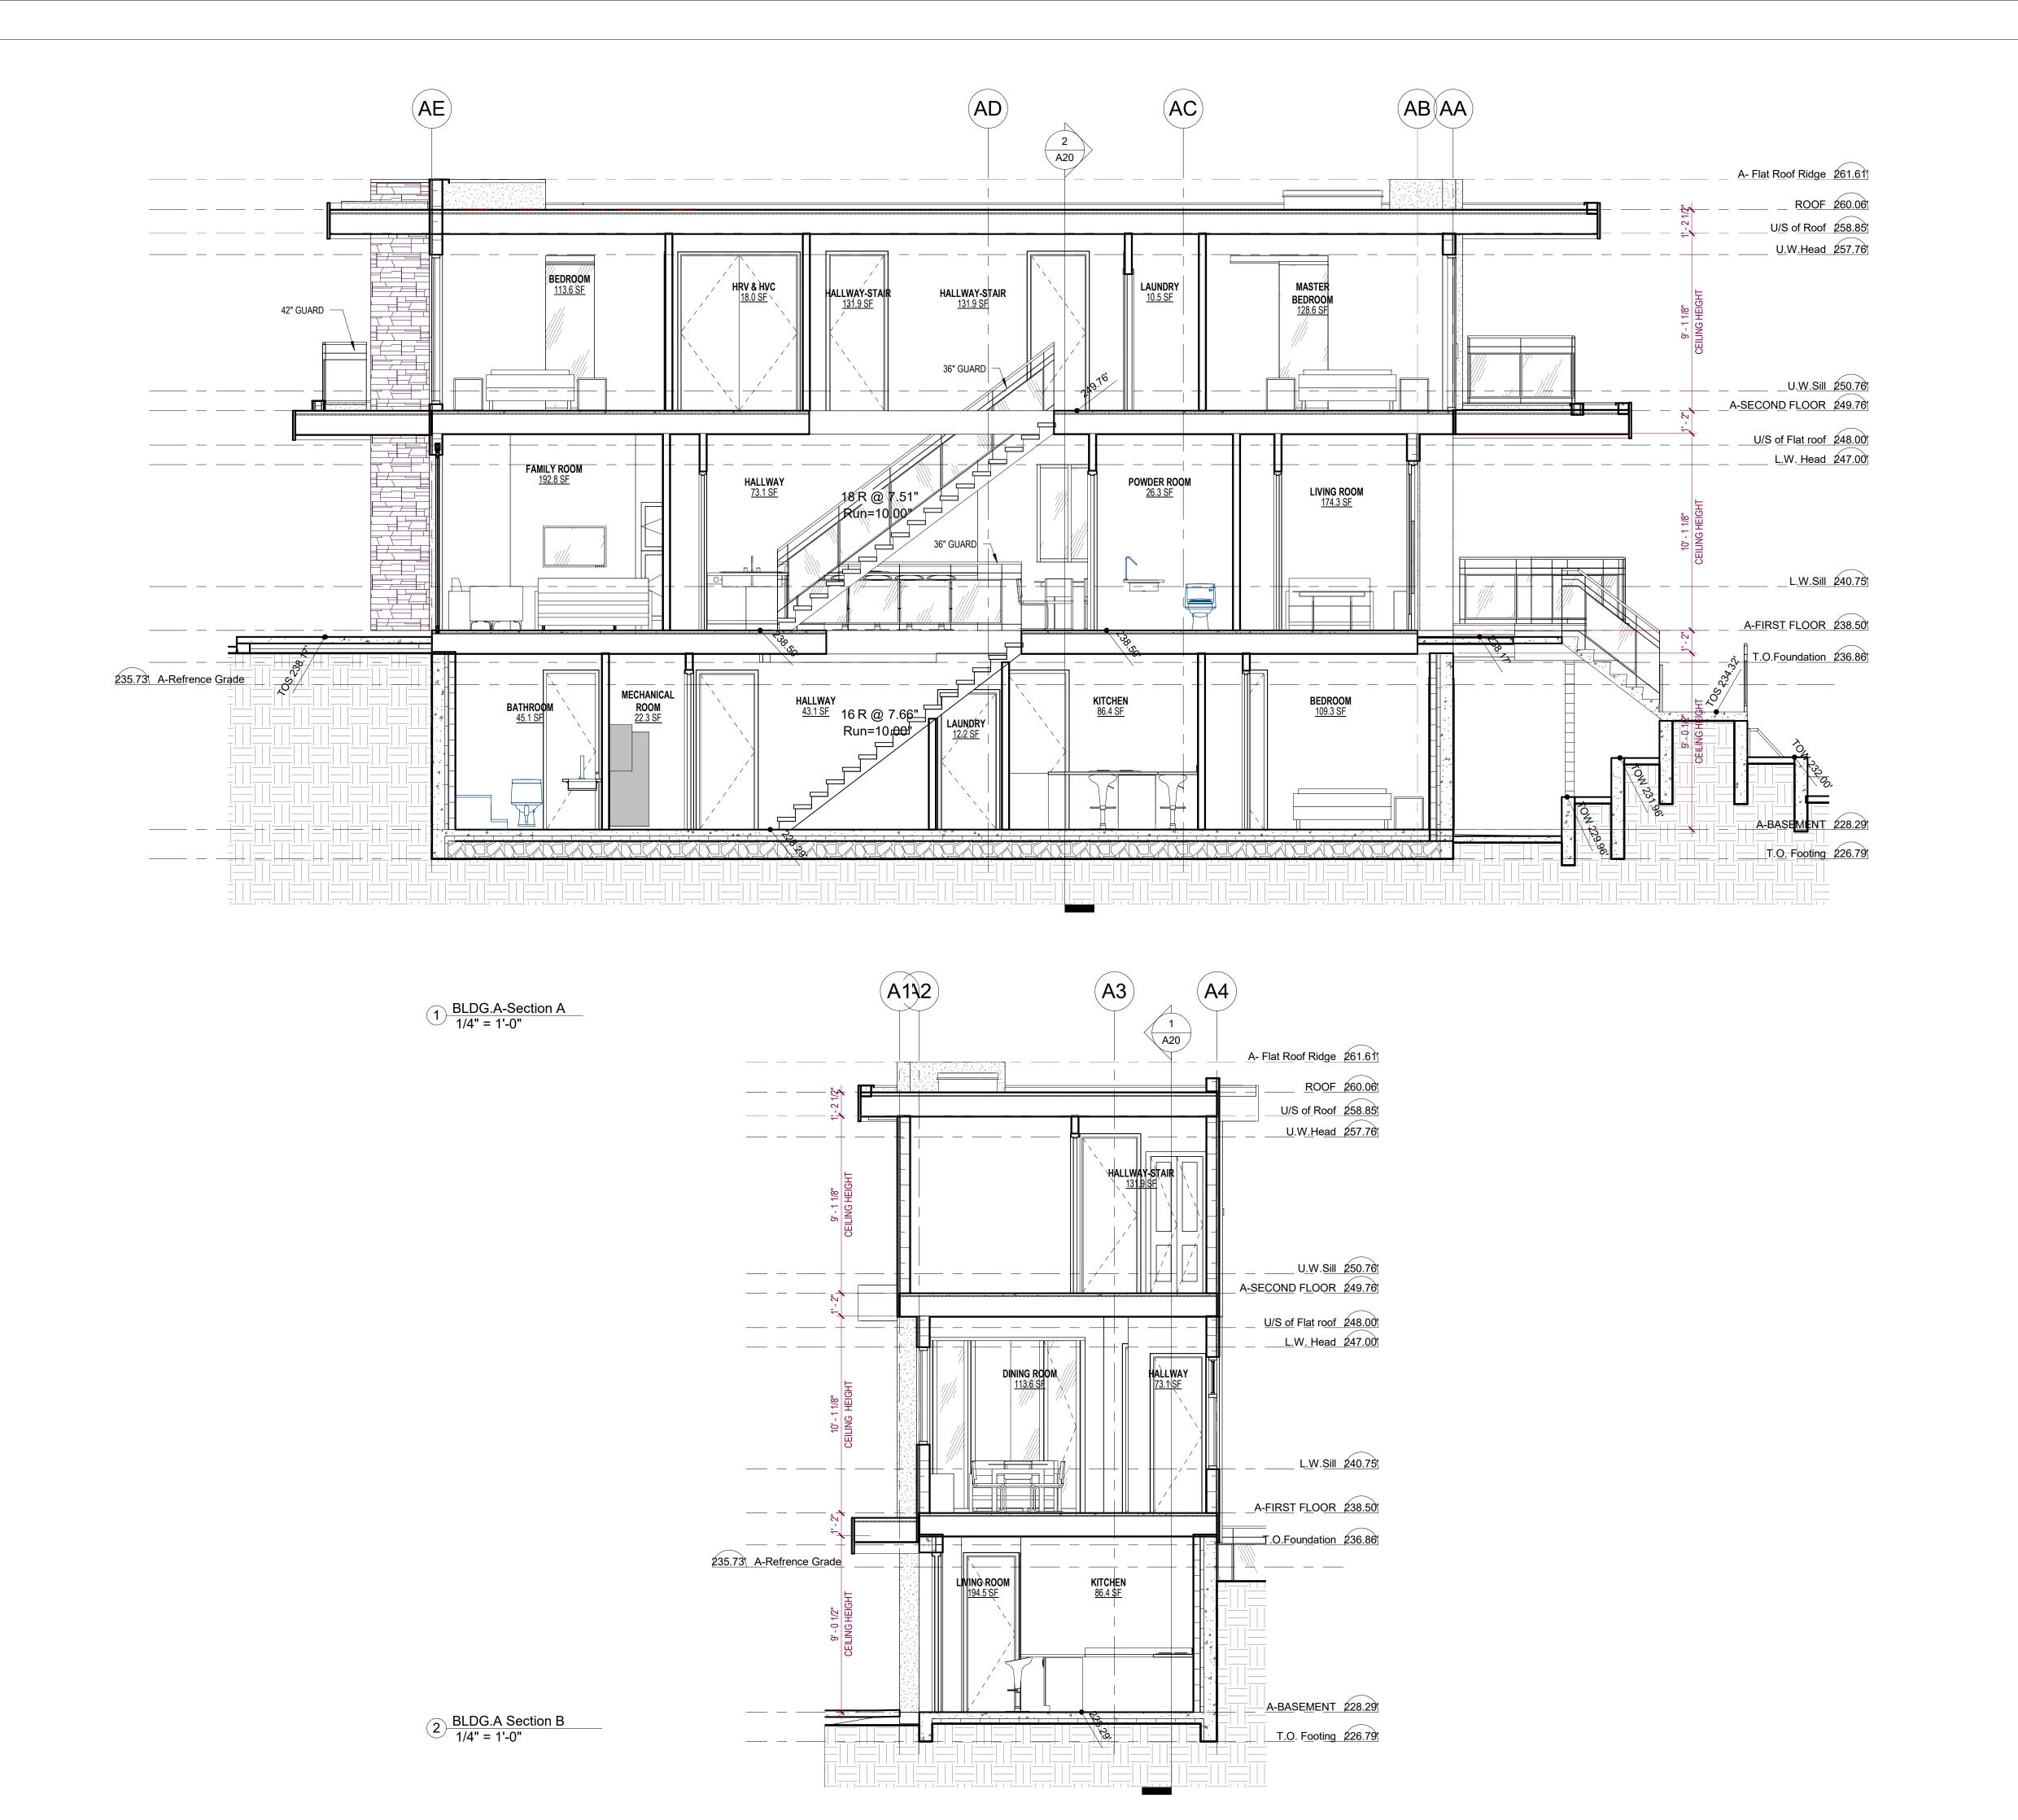
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PROJECT NO. PLOT DATE 23285

MAY 15, 2024 DRAWN REVIEWED 1/4" = 1'-0"

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BLDG- A SECTIONS

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PROJECT NO. PLOT DATE MAY 15, 2024 DRAWN NN
23285 SCALE 1/4" = 1'-0" REVIEWED

DRAWING NO.

A20